

AFC URGENT CARE SITE PLAN


A RESUBDIVISION OF LOTS 1 AND 2, BLOCK 1, AURORA PLAZA

SITUATED IN THE NORTHEAST ¼ OF SECTION 2, TOWNSHIP 4 SOUTH, RANGE 67 WEST OF THE 6TH P.M.
CITY OF AURORA, COUNTY OF ARAPAHOE, STATE OF COLORADO

SITE DATA TABLE	
LAND AREA WITHIN PROPERTY LINES:	37770 SF = 0.867 ACRES
NUMBER OF BUILDINGS	2
TOTAL BUILDING COVERAGE	9222 SF = 0.212 ACRES (24.42%) INCL. WITH HARD SURFACE
HARD SURFACE AREA	32960 SF = 0.757 ACRES (87.31%)
LANDSCAPE AREA	4810 SF = 0.110 ACRES (12.69%)
REQUIRED PATIO SIZING	461 SF
PROVIDED PATIO	805 SF
PARKING SPACES REQUIRED	(GFA/1000)*4=38
PARKING SPACES PROVIDED	39
BICYCLE PARKING SPACES REQUIRED	4
BICYCLE PARKING SPACES PROVIDED	4
HANDICAP SPACES REQUIRED	2
HANDICAP SPACES PROVIDED (BOTH ARE VAN ACCESSIBLE)	2
MAXIMUM SIGN QUANTITY	5 PER TENANT
MAXIMUM SIGN AREA	80 SF PER TENANT

BUILDING A DATA TABLE	
GROSS FLOOR AREA	3717 SF
BUILDING TYPE	V-B
FIRE SPRINKLER	NO
MAXIMUM HEIGHT OF BUILDING	23'-6"
ZONING CLASSIFICATION	OA-G
PROPOSED USE	MEDICAL OFFICE & URGENT CARE

BUILDING B DATA TABLE	
GROSS FLOOR AREA	5606 SF
BUILDING TYPE	V-B
FIRE SPRINKLER	NO
MAXIMUM HEIGHT OF BUILDING	23'-6"
ZONING CLASSIFICATION	OA-G
PROPOSED USE	MEDICAL OFFICE & URGENT CARE

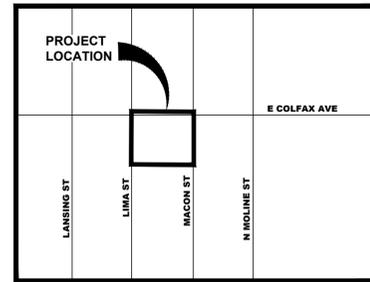

VICINITY MAP
1" = 500'
NORTH

SHEET LIST

1	COVER SHEET	10	PHOTOMETRIC SITE PLAN
2	NOTES AND LEGEND	11	OVERALL STREET ELEVATIONS
3	SITE PLAN	12	BUILDING A ELEVATIONS
4	PATIO DIAGRAM	13	BUILDING A ELEVATIONS
5	GRADING AND UTILITY PLAN	14	BUILDING B ELEVATIONS
6	SITE PLAN DETAILS SHEET	15	BUILDING B ELEVATIONS
7	TREE MITIGATION PLAN	16	MATERIAL BOARD
8	PLANTING PLAN	17	ARCH DETAILS
9	LANDSCAPE DETAILS		

Signature Block

(Official Project Name) Site Plan *

Legal Description: _____

This Site Plan and any amendments hereto, upon approval by the City of Aurora and recording, shall be binding upon the applicants therefore, their successors and assigns. This plan shall limit and control the issuance and validity of all building permits, and shall restrict and limit the construction, location, use, occupancy and operation of all land and structures within this plan to all conditions, requirements, locations and limitations set forth herein. Abandonment, withdrawal or amendment of this plan may be permitted only upon approval of the City of Aurora.

In witness thereof, _____ has caused these
(Corporation, Company, or Individual)

presents to be executed this ____ day of _____ AD, _____.

By: _____ Corporate Seal
(Principals or Owners)

State of Colorado _____)ss
County of _____)

The foregoing instrument was acknowledged before me this ____ day of _____ AD, _____ by

(Principals or Owners)

Witness my hand and official seal

(Notary Public) Notary Seal

My commission expires _____ Notary Business Address: _____

CITY OF AURORA APPROVALS

City Attorney: _____ Date: _____

Planning Director: _____ Date: _____

Planning and Zoning Commission: _____ Date: _____
(Chairperson)

City Council: _____ Date: _____

Attest: _____ Date: _____
(City Clerk)

Database Approval Date _____

RECORDER'S CERTIFICATE:

Accepted for filing in the office of the Clerk and Recorder of _____
Colorado at _____ o'clock ____ M, this ____ day of _____ AD, _____.
Clerk and Recorder: _____ Deputy: _____

LEGAL DESCRIPTION

LEGAL DESCRIPTION:

LOT 1, BLOCK 1, SHAY PLAZA SUBDIVISION FILING NO. 1

COMMENCING AT THE NORTH ¼ CORNER OF SAID SECTION 2;

THENCE N89°36'49"E ALONG THE NORTH LINE OF THE NORTHEAST ¼ OF SAID SECTION 2, A DISTANCE OF 29.54 FEET;

THENCE S00°23'11"E A DISTANCE OF 50.00 FEET TO THE NORTHWEST CORNER OF A RIGHT-OF-WAY (R.O.W.) CONVEYANCE AS RECORDED IN BOOK 7886 AT PAGE 743 IN THE ARAPAHOE COUNTY CLERK AND RECORDER'S OFFICE;

THENCE N89°36'49"E ALONG THE NORTH LINE OF SAID CONVEYANCE, A DISTANCE OF 24.77 FEET TO THE POINT OF BEGINNING;

THENCE N89°36'49"E ALONG THE SOUTH R.O.W. LINE OF EAST COLFAX AVENUE, A DISTANCE OF 250.28 FEET;

THENCE S00°05'43"W ALONG THE WEST R.O.W. LINE OF MACOM STREET, A DISTANCE OF 140.00 FEET;

THENCE S89°36'49"W ALONG THE NORTH LINE OF LOT 1, BLOCK 1, LIMA CENTER SUBDIVISION FILING NO. 1 AS RECORDED AT RECEPTION NO. 1529258 IN SAID ARAPAHOE COUNTY CLERK AND RECORDER'S OFFICE, A DISTANCE OF 275.17 FEET;

THENCE N00°08'51"E ALONG THE EAST R.O.W. LINE OF LIMA STREET, A DISTANCE OF 115.23 FEET TO THE SOUTHERLY POINT OF SAID R.O.W. CONVEYANCE;

THENCE ALONG THE SOUTHEASTERLY CURVE OF SAID R.O.W. CONVEYANCE, A CURVE TO THE RIGHT HAVING A CENTRAL ANGLE OF 89°27'57", A RADIUS OF 25.00 FEET, AN ARC LENGTH OF 39.04 FEET, A CHORD BEARING OF N44°52'50"E WITH A CHORD DISTANCE OF 35.19 FEET TO THE POINT OF BEGINNING.

CONTAINS (38,382 SQUARE FEET) 0.8811 ACRES, MORE OR LESS.

AFC URGENT CARE - SITE PLAN

NOT FOR CONSTRUCTION

CONSULTANT TEAM

ARCHITECT CUSHING TERRELL LAURA DOUGHERTY 303 E 17TH AVE SUITE 105 DENVER, CO 80203 (720) 598-9255	CIVIL ENGINEER CUSHING TERRELL MICHAEL WHITE, PE 303 E 17TH AVE SUITE 105 DENVER, CO 80203 (303) 653-6004	ELECTRICAL ENGINEER CUSHING TERRELL PATRICK MORANVILLE, PE 303 E 17TH AVE SUITE 105 DENVER, CO 80203 (303) 598-9266	LANDSCAPE ARCHITECT CUSHING TERRELL ANGELA HANSEN 800 W MAIN ST, SUITE #800 BOISE ID 83702 (208) 577-5657	GEOTECHNICAL ENGINEER KUMAR AND ASSOCIATES, INC 2390 SOUTH LIPAN STREET DENVER, CO 80223 (303) 742-9700
---	--	--	--	---

AMENDMENT BLOCK



ABBREVIATIONS

@	AT	LT	LEFT
AB	ABANDONED	MEG	MATCH EXISTING GRADE
AHJ	AUTHORITIES HAVING JURISDICTION	MH	MANHOLE
APPROX	APPROXIMATE	MTR	METER
ASCE	AMERICAN SOCIETY OF CIVIL ENGINEERS	NTS	NOT TO SCALE
BC	BACK OF CURB	OC	ON CENTER
BCR	BACK OF CURB RADIUS	OH, OHP	OVERHEAD, OVERHEAD POWER
BM	BENCHMARK	OHU	OVERHEAD UTILITIES
BOT	BOTTOM	PB	PULL BOX
BP	BURIED POWER	PC	POINT OF CURVATURE
BT	BURIED TELEPHONE	PIP	PROTECT IN PLACE
BW	BOTTOM OF WALL	PL	PROPERTY LINE
C&G	CURB & GUTTER	PP	POWER POLE
CATV, TV	CABLE TELEVISION	PRC	POINT OF REVERSE CURVE
CI	CAST IRON	PT	POINT OF TANGENCY
CIPP	CURED IN PLACE PIPE	PVC	POLYVINYL CHLORIDE PIPE
CL	CENTERLINE	RCP	REINFORCED CONCRETE PIPE
CMP	CORRUGATED METAL PIPE	RIM	RIM OF MANHOLE LID OR GRATE
CO	CLEANOUT	ROW	RIGHT OF WAY
D, DIA	DIAMETER	SF	SQUARE FOOT, SQUARE FEET
DG	DECOMPOSED GRANITE	SP	SPECIAL PROVISIONS
DI	DUCTILE IRON	SS	SANITARY SEWER
DIP	DUCTILE IRON PIPE	SSMH	SANITARY SEWER MANHOLE
DOM	DOMESTIC WATER	ST	STORM DRAIN
DW	DRIVEWAY	STA	STATION
DWG	DRAWING	STCB	STORM CATCH BASIN
EG	EXISTING GRADE	STCI	STORM CURB INLET
ELEC, E	ELECTRIC	STD	STANDARD
EL, ELEV	ELEVATION	STMH	STORM MANHOLE
EOP, EP	EDGE OF PAVEMENT	STDY	STORM YARD DRAIN
ESCP	EROSION AND SEDIMENT CONTROL PLAN	SW	SIDEWALK
EX	EXISTING	SWPPP	STORMWATER POLLUTION PREVENTION PLAN
FC	FACE OF CURB	SY	SQUARE YARD
FG	FINISHED GRADE	T, TEL	TELEPHONE
FH, HYD	FIRE HYDRANT	TA	TOP OF ASPHALT
FL	FLOW LINE	TBC	TOP BACK OF CURB
FT	FOOT, FEET	TC	TOP OF CONCRETE
G	GAS	TEMP	TEMPORARY
GM	GAS METER	TRANS	TRANSITION
GV	GAS VALVE	TW	TOP OF WALL
GW	GUY WIRE	TYP	TYPICAL
HP	HIGH PRESSURE	VCP	VITRIFIED CLAY PIPE
IE	INVERT ELEVATION	WM	WATER MAIN
INT	INTERSECTION	WV	WATER VALVE
IRR	IRRIGATION	W/	WITH
L	LENGTH	Δ	DELTA
LF	LINEAL FOOT, LINEAR FEET		
LS	LANDSCAPING		

CITY OF AURORA STANDARD NOTES

- THE DEVELOPER, HIS SUCCESSORS AND ASSIGNS, INCLUDING THE HOMEOWNERS OR MERCHANTS ASSOCIATION, SHALL BE RESPONSIBLE FOR INSTALLATION, MAINTENANCE AND REPLACEMENT OF ALL FIRE LANE SIGNS AS REQUIRED BY THE CITY OF AURORA.
- ALL SIGNS MUST CONFORM TO THE CITY OF AURORA SIGN CODE.
- RIGHT OF WAY FOR INGRESS AND EGRESS FOR SERVICE AND EMERGENCY VEHICLES IS GRANTED OVER, ACROSS, ON AND THROUGH ANY AND ALL PRIVATE ROADS AND WAYS NOW OR HEREAFTER ESTABLISHED ON THE DESCRIBED PROPERTY, AND THE SAME ARE HEREBY DESIGNATED AS "SERVICE/EMERGENCY AND UTILITY EASEMENTS" AND SHALL BE POSTED "NO PARKING - FIRE LANE."
- ACCESSIBLE EXTERIOR ROUTES SHALL BE PROVIDED FROM PUBLIC TRANSPORTATION STOPS, ACCESSIBLE PARKING AND ACCESSIBLE PASSENGER LOADING ZONES AND PUBLIC SIDEWALKS TO 60 OF THE ACCESSIBLE BUILDING ENTRANCES THEY SERVE. THE ACCESSIBLE ROUTE BETWEEN ACCESSIBLE PARKING AND ACCESSIBLE BUILDING ENTRANCES SHALL BE THE MOST PRACTICAL DIRECT ROUTE. THE ACCESSIBLE ROUTE MUST BE LOCATED WITHIN A SIDEWALK NO SLOPE ALONG THIS ROUTE MAY EXCEED 1:20 WITHOUT PROVIDING A RAMP WITH A MAXIMUM SLOPE OF 1:12 AND HANDRAILS. CROSSWALKS ALONG THIS ROUTE SHALL BE WIDE ENOUGH TO WHOLLY CONTAIN THE CURB RAMP WITH A MINIMUM WIDTH OF 36" AND SHALL BE PAINTED WITH WHITE STRIPES. THE CITY OF AURORA ENFORCES HANDICAPPED ACCESSIBILITY REQUIREMENTS BASED ON THE 2021 INTERNATIONAL BUILDING CODE, CHAPTER 11, AND THE INTERNATIONAL CODE COUNCIL (ICC) A117.1-2017.
- THE APPLICANT HAS THE OBLIGATION TO COMPLY WITH ALL APPLICABLE REQUIREMENTS OF THE AMERICANS WITH DISABILITIES ACT.
- THE DEVELOPER, HIS SUCCESSORS AND ASSIGNS, SHALL BE RESPONSIBLE FOR INSTALLATION, MAINTENANCE AND REPLACEMENT OF ALL LANDSCAPING MATERIALS SHOWN OR INDICATED ON THE APPROVED SITE PLAN OR LANDSCAPE PLAN ON FILE IN THE PLANNING DEPARTMENT. ALL LANDSCAPING WILL BE INSTALLED PRIOR TO ISSUANCE OF CERTIFICATE OF OCCUPANCY.
- ALL CROSSINGS OR ENCROACHMENTS INTO EASEMENTS AND RIGHTS-OF-WAY OWNED BY THE CITY OF AURORA ("CITY") IDENTIFIED AS BEING PRIVATELY-OWNED AND MAINTAINED HEREIN ARE ACKNOWLEDGED BY THE UNDERSIGNED AS BEING SUBJECT TO CITY'S USE AND OCCUPANCY OF SAID EASEMENTS OR RIGHTS-OF-WAY. THE UNDERSIGNED, ITS SUCCESSORS AND ALIGNS, FURTHER AGREES TO REMOVE, REPAIR, REPLACE, MODIFY, OR OTHERWISE ADJUST SAID CROSSING OR ENCROACHMENTS UPON REQUEST FROM THE CITY AND AT NO EXPENSE TO THE CITY. THE CITY RESERVES THE RIGHT TO MAKE FULL USE OF THE EASEMENTS AND RIGHTS-OF-WAY AS MAY BE NECESSARY OR CONVENIENT AND THE CITY RETAINS ALL RIGHTS TO OPERATE, MAINTAIN, INSTALL, REPAIR, REMOVE OR RELOCATE ANY CITY FACILITIES STATE WITHIN SAID EASEMENTS AND RIGHTS-OF-WAY AT ANY TIME AND IN SUCH A MANNER AS IT DEEMS NECESSARY OR CONVENIENT.
- THE APPROVAL OF THIS DOCUMENT DOES NOT CONSTITUTE FINAL APPROVAL OF GRADING, DRAINAGE, UTILITY, PUBLIC IMPROVEMENTS AND BUILDING PLANS. CONSTRUCTION PLANS MUST BE REVIEWED AND APPROVED BY THE APPROPRIATE AGENCY PRIOR TO THE ISSUANCE OF BUILDING PERMITS.
- ALL BUILDING ADDRESS NUMBERS SHALL COMPLY WITH SECTIONS 126-271 AND 126-278 OF THE AURORA CITY CODE.
- ALL ROOFTOP MECHANICAL EQUIPMENT AND VENTS GREATER THAN EIGHT (8) INCHES IN DIAMETER MUST BE SCREENED. SCREENING MAY BE DONE EITHER WITH AN EXTENDED PARAPET WALL OR A FREESTANDING SCREEN WALL. SCREENS SHALL BE AT LEAST AS HIGH AS THE EQUIPMENT THEY HIDE. IF EQUIPMENT IS VISIBLE BECAUSE SCREENS DON'T MEET THIS MINIMUM HEIGHT REQUIREMENT, THE DIRECTOR OF PLANNING MAY REQUIRE CONSTRUCTION MODIFICATIONS PRIOR TO THE ISSUANCE OF A PERMANENT CERTIFICATE OF OCCUPANCY.
- NOTWITHSTANDING ANY SURFACE IMPROVEMENTS, LANDSCAPING, PLANTING OR CHANGES SHOWN IN THESE SITE OR CONSTRUCTION PLANS, OR ACTUALLY CONSTRUCTED OR PUT IN PLACE, ALL UTILITY EASEMENTS MUST REMAIN UNOBSTRUCTED AND FULLY ACCESSIBLE ALONG THEIR ENTIRE LENGTH TO ALLOW FOR ADEQUATE MAINTENANCE EQUIPMENT. ADDITIONALLY, NO INSTALLATION, PLANTING, CHANGE IN THE SURFACE, ETC., SHALL INTERFERE WITH THE OPERATION OF THE UTILITY LINES PLACED WITHIN THE EASEMENT. BY SUBMITTING THESE SITE OR CONSTRUCTION PLANS FOR APPROVAL, THE LANDOWNER RECOGNIZES AND ACCEPTS THE TERMS, CONDITIONS AND REQUIREMENTS OF THIS NOTE.
- FINAL GRADE SHALL BE AT LEAST SIX (6) INCHES BELOW ANY EXTERIOR WOOD SIDING ON THE PREMISES.
- ALL INTERESTED PARTIES ARE HEREBY ALERTED THAT THIS SITE PLAN IS SUBJECT TO ADMINISTRATIVE CHANGES AND AS SHOWN ON THE ORIGINAL SITE PLAN ON FILE IN THE AURORA CITY PLANNING OFFICE AT THE MUNICIPAL BUILDING. A COPY OF THE OFFICIAL CURRENT PLAN MAY BE PURCHASED THERE. LIKEWISE, SITE PLANS ARE REQUIRED TO AGREE WITH THE APPROVED SUBDIVISION PLAT OF RECORD AT THE TIME OF A BUILDING PERMIT; AND IF NOT, MUST BE AMENDED TO AGREE WITH THE PLAT AS NEEDED, OR VICE VERSA.
- ERRORS IN APPROVED SITE PLANS RESULTING FROM COMPUTATIONS OR INCONSISTENCIES IN THE DRAWINGS MADE BY THE APPLICANT ARE THE RESPONSIBILITY OF THE PROPERTY OWNER OF RECORD. WHERE FOUND, THE CURRENT MINIMUM CODE REQUIREMENTS WILL APPLY AT THE TIME OF BUILDING PERMIT. PLEASE BE SURE THAT ALL PLAN COMPUTATIONS ARE CORRECT.
- ALL REPRESENTATIONS AND COMMITMENTS MADE BY APPLICANTS AND PROPERTY OWNERS AT PUBLIC HEARINGS REGARDING THIS PLAN ARE BINDING UPON THE APPLICANT, PROPERTY OWNER, AND ITS HEIRS, SUCCESSORS, AND ASSIGNS.
- ARCHITECTURAL FEATURES, SUCH AS BAY WINDOWS, FIREPLACES, ROOF OVERHANGS, GUTTERS, EAVES, FOUNDATIONS, FOOTINGS, CANTILEVERED WALLS, ETC, ARE NOT ALLOWED TO ENCRACH INTO ANY EASEMENT OR FIRE LANE.
- THE VENDOR OF ANY FUTURE SALE OF THE REAL PROPERTY SHALL PROVIDE THE REQUIRED NOTICE PER CITY CODE SECTION 146-158(C) TO BE RECORDED WITH THE COUNTY CLERK AND RECORDER AND SHALL PROVIDE SUCH NOTICE TO EACH PROSPECTIVE PURCHASER OF ANY AND ALL SAID PROPERTY. SEE EXHIBIT C4 UNDER THE AIRPORT RELATED LAND USE RESTRICTIONS SECTION OF THIS GUIDEBOOK.
- THE 2021 INTERNATIONAL FIRE CODE (IFC), REQUIRES ALL BUILDINGS TO BE ASSESSED FOR ADEQUATE EMERGENCY RESPONDER RADIO COVERAGE (ERRC). AT THE TIME THE STRUCTURE IS AT FINAL FRAME AND FINAL ELECTRICAL INSPECTIONS, THE GENERAL CONTRACTOR (GC) WILL BE REQUIRED TO HIRE A QUALIFIED INDEPENDENT 3RD PARTY TO ASSESS THE RADIO FREQUENCY LEVELS WITHIN THE STRUCTURE. ONCE COMPLETED, THE 3RD PARTY WILL PROVIDE THE RESULTS OF THE TEST TO BOTH THE DC AND THE AURORA BUILDING DIVISION AS TO WHETHER THE STRUCTURE PASSED OR FAILED THE PRELIMINARY RADIO SURVEILLANCE. A STRUCTURE THAT HAS PASSED THIS SURVEILLANCE REQUIRES NO FURTHER ACTION BY THE GC. A FAILED RADIO SURVEILLANCE WILL REQUIRE A LICENSED CONTRACTOR TO SUBMIT PLANS TO THE AURORA BUILDING DIVISION TO OBTAIN A BUILDING PERMIT FOR THE INSTALLATION OF AN ERRC SYSTEM PRIOR TO INSTALLATION. THIS ASSESSMENT AND INSTALLATION IS AT THE OWNER OR DEVELOPERS EXPENSE. FUTURE INTERIOR OR EXTERIOR MODIFICATIONS TO THE STRUCTURE AFTER THE ORIGINAL CERTIFICATE OF OCCUPANCY IS ISSUED WILL REQUIRE A REASSESSMENT FOR ADEQUATE RADIO FREQUENCY COVERAGE.
- THE DEVELOPER IS RESPONSIBLE FOR SIGNING AND STRIPING ALL PUBLIC STREETS. THE DEVELOPER IS REQUIRED TO PLACE TRAFFIC CONTROL, STREET NAME, AND GUIDE SIGNS ON ALL PUBLIC STREETS AND PRIVATE STREETS APPROACHING AN INTERSECTION WITH A PUBLIC STREET. SIGNS SHALL BE FURNISHED AND INSTALLED PER THE MOST CURRENT EDITIONS OF THE MANUAL ON UNIFORM TRAFFIC CONTROL DEVICES (MUTCD) AND CITY STANDARDS, AND SHOWN ON THE SIGNING AND STRIPING PLAN FOR THE DEVELOPMENT.
- THE STREETLIGHT OR PEDESTRIAN LIGHT INSTALLATION WITHIN THE PUBLIC RIGHT-OF-WAY SHALL BE DESIGNED, FUNDED, AND CONSTRUCTED BY THE DEVELOPER/OWNER. OWNERSHIP AND MAINTENANCE OF THE STREET/PEDESTRIAN LIGHTS SHALL BE THE RESPONSIBILITY OF THE CITY OF AURORA ONCE THEY HAVE BEEN ACCEPTED. STREET LIGHT AND/OR PEDESTRIAN PHOTOMETRIC PLANS SHALL BE PREPARED AND SUBMITTED TO THE CITY FOR REVIEW AND APPROVAL AND SHALL BECOME A PART OF THE APPROVED CIVIL CONSTRUCTION PLANS FOR THE PROJECT. AN ELECTRICAL PLAN SHOWING SITE LOCATION OF LIGHTS, ELECTRICAL ONE LINE AND GROUNDING DETAILS SHALL BE SUBMITTING TO THE PERMIT CENTER FOR REVIEW BY THE BUILDING DEPARTMENT. THE OWNER IS RESPONSIBLE FOR OBTAINING AN ADDRESS FOR THE METER(S) FROM THE PLANNING DEPARTMENT. A BUILDING PERMIT FOR THE METER AND A PUBLIC INSPECTIONS PERMIT FOR THE STREET LIGHTS ARE REQUIRED. CERTIFICATE OF OCCUPANCIES WILL NOT BE ISSUED UNTIL THE STREET AND/OR PEDESTRIAN LIGHTING PLANS ARE APPROVED, CONSTRUCTED, AND INITIALLY ACCEPTED.
- IN LOCATIONS WHERE UTILITY EASEMENTS OVERLAP DRAINAGE EASEMENTS, ONLY SUBSURFACE UTILITIES SHALL BE PERMITTED WITHIN THE PORTION OF THE UTILITY EASEMENT THAT OVERLAPS THE DRAINAGE EASEMENT. INSTALLATION OF ABOVE GROUND UTILITIES WITHIN A DRAINAGE EASEMENT REQUIRES PRIOR WRITTEN APPROVAL BY THE CITY ENGINEER.
- THE DEVELOPER IS RESPONSIBLE FOR SIGNING AND STRIPING ALL PUBLIC STREETS. THE DEVELOPER IS REQUIRED TO PLACE TRAFFIC CONTROL, STREET NAME, AND GUIDE SIGNS ON ALL PUBLIC STREETS AND PRIVATE STREETS APPROACHING AN INTERSECTION WITH A PUBLIC STREET. SIGNS SHALL BE FURNISHED AND INSTALLED PER THE MOST CURRENT EDITIONS OF THE MANUAL ON UNIFORM TRAFFIC CONTROL DEVICES (MUTCD) AND CITY STANDARDS, AND SHOWN ON THE SIGNING AND STRIPING PLAN FOR THE DEVELOPMENT.

LEGEND

EXISTING	PROPOSED	
		ASPHALT
		CONCRETE
		COLORED CONCRETE
		PERVIOUS PAVERS
		WATER MAIN
		FIRE SERVICE
		DOMESTIC WATER SERVICE
		STORM DRAIN
		SANITARY SEWER
		BURIED POWER
		OVERHEAD POWER
		BURIED TELEPHONE
		BURIED GAS
		BURIED FIBER OPTIC
		BUILDING
		BUILDING ROOF OVERHANG
		VERTICAL CURB
		CURB AND GUTTER
		CURB AND GUTTER - CATCH
		CURB AND GUTTER - SPILL
		VEGETATION EXTENTS
		PROPERTY LINE - SUBJECT
		PROPERTY LINE - ADJACENT
		EASEMENT
		ACCESSIBILITY ROUTE
		CONTROL POINT
		FOUND PROPERTY CORNER AS NOTED
		KNOX BOX
		FIRE HYDRANT/ CONTROL POINT HYDRANT
		WATER VALVE
		WATER SHUTOFF/CURB STOP
		WATER METER
		STORM DRAIN MANHOLE
		STORM DRAIN INLET STRUCTURE
		STORM DRAIN CURB INLET
		STORM DRAIN OUTLET STRUCTURE
		STORM DRAIN ROOF DOWNSPOUT
		STORM DRAIN CLEANOUT
		SANITARY SEWER MANHOLE
		SANITARY SEWER CLEANOUT
		UTILITY POLE
		GUY WIRE
		LIGHT POLE (ONE LIGHT AND DIRECTION)
		LIGHT POLE
		TRANSFORMER
		POWER METER OR POWER HANDHOLE
		GAS METER
		TELEPHONE PEDESTAL
		IRRIGATION CONTROL VALVE
		POLE SIGN AND DOUBLE POLE SIGN
		BOLLARD (OR AS NOTED)
		PARKING STALL COUNT
		DECIDUOUS TREE
		CONIFEROUS TREE
		BUSH

Cushing Terrell

cushingterrell.com
800.757.9522

AFC URGENT CARE - SITE PLAN

© 2023 | ALL RIGHTS RESERVED

SITE PLAN

04.26.2024
DRAWN BY | DOCTER
CHECKED BY | YOUNG
REVISIONS

NOTES AND LEGEND

2


NOT FOR CONSTRUCTION

LEGEND

EXISTING	PROPOSED	EXISTING	PROPOSED	EXISTING	PROPOSED

GENERAL NOTES

- PROPOSED STREET LIGHT LOCATIONS ARE CONCEPTUAL. FINAL LOCATIONS WILL BE DETERMINED WITH PHOTOMETRIC ANALYSIS SUBMITTED WITH THE STREET LIGHTING PLANS IN THE CIVIL PLAN SUBMITTAL.
- LINEWORK FOR EXISTING DRIVEWAYS / CURB CUTS ON THE NORTH SIDE OF E COLFAX WERE DEVELOPED FROM AERIAL IMAGERY TO PROVIDE ADDITIONAL CONTEXT FOR THE PROPOSED SITE.
- THE STREETLIGHT OR PEDESTRIAN LIGHT INSTALLATION WITHIN THE PUBLIC RIGHT-OF-WAY SHALL BE DESIGNED, FUNDED, AND CONSTRUCTED BY THE DEVELOPER/OWNER. OWNERSHIP AND MAINTENANCE OF THE STREET/PEDESTRIAN LIGHTS SHALL BE THE RESPONSIBILITY OF THE CITY OF AURORA ONCE THEY HAVE BEEN ACCEPTED. STREET LIGHT AND/OR PEDESTRIAN PHOTOMETRICS PLANS SHALL BE PREPARED AND SUBMITTED TO THE CITY FOR REVIEW AND APPROVAL AND SHALL BECOME A PART OF THE APPROVED CIVIL CONSTRUCTION PLANS FOR THE PROJECT. AN ELECTRICAL PLAN SHOWING SITE LOCATION OF LIGHTS, ELECTRICAL ONE LINE AND GROUNDING DETAILS SHALL BE SUBMITTING TO THE PERMIT CENTER FOR REVIEW BY THE BUILDING DEPARTMENT. THE OWNER IS RESPONSIBLE FOR OBTAINING AN ADDRESS FOR THE METER(S) FROM THE PLANNING DEPARTMENT. A BUILDING PERMIT FOR THE METER AND A PUBLIC INSPECTIONS PERMIT FOR THE STREET LIGHTS ARE REQUIRED. CERTIFICATE OF OCCUPANCIES WILL NOT BE ISSUED UNTIL THE STREET AND/OR PEDESTRIAN LIGHTING PLANS ARE APPROVED, CONSTRUCTED AND INITIALLY ACCEPTED.
- IN LOCATIONS WHERE UTILITY EASEMENTS OVERLAP DRAINAGE EASEMENTS, ONLY SUBSURFACE UTILITIES SHALL BE PERMITTED WITHIN THE PORTION OF THE UTILITY EASEMENT THAT OVERLAPS THE DRAINAGE EASEMENT. INSTALLATION OF ABOVE-GROUND UTILITIES WITHIN A DRAINAGE EASEMENT REQUIRES PRIOR WRITTEN APPROVAL BY THE CITY ENGINEER.

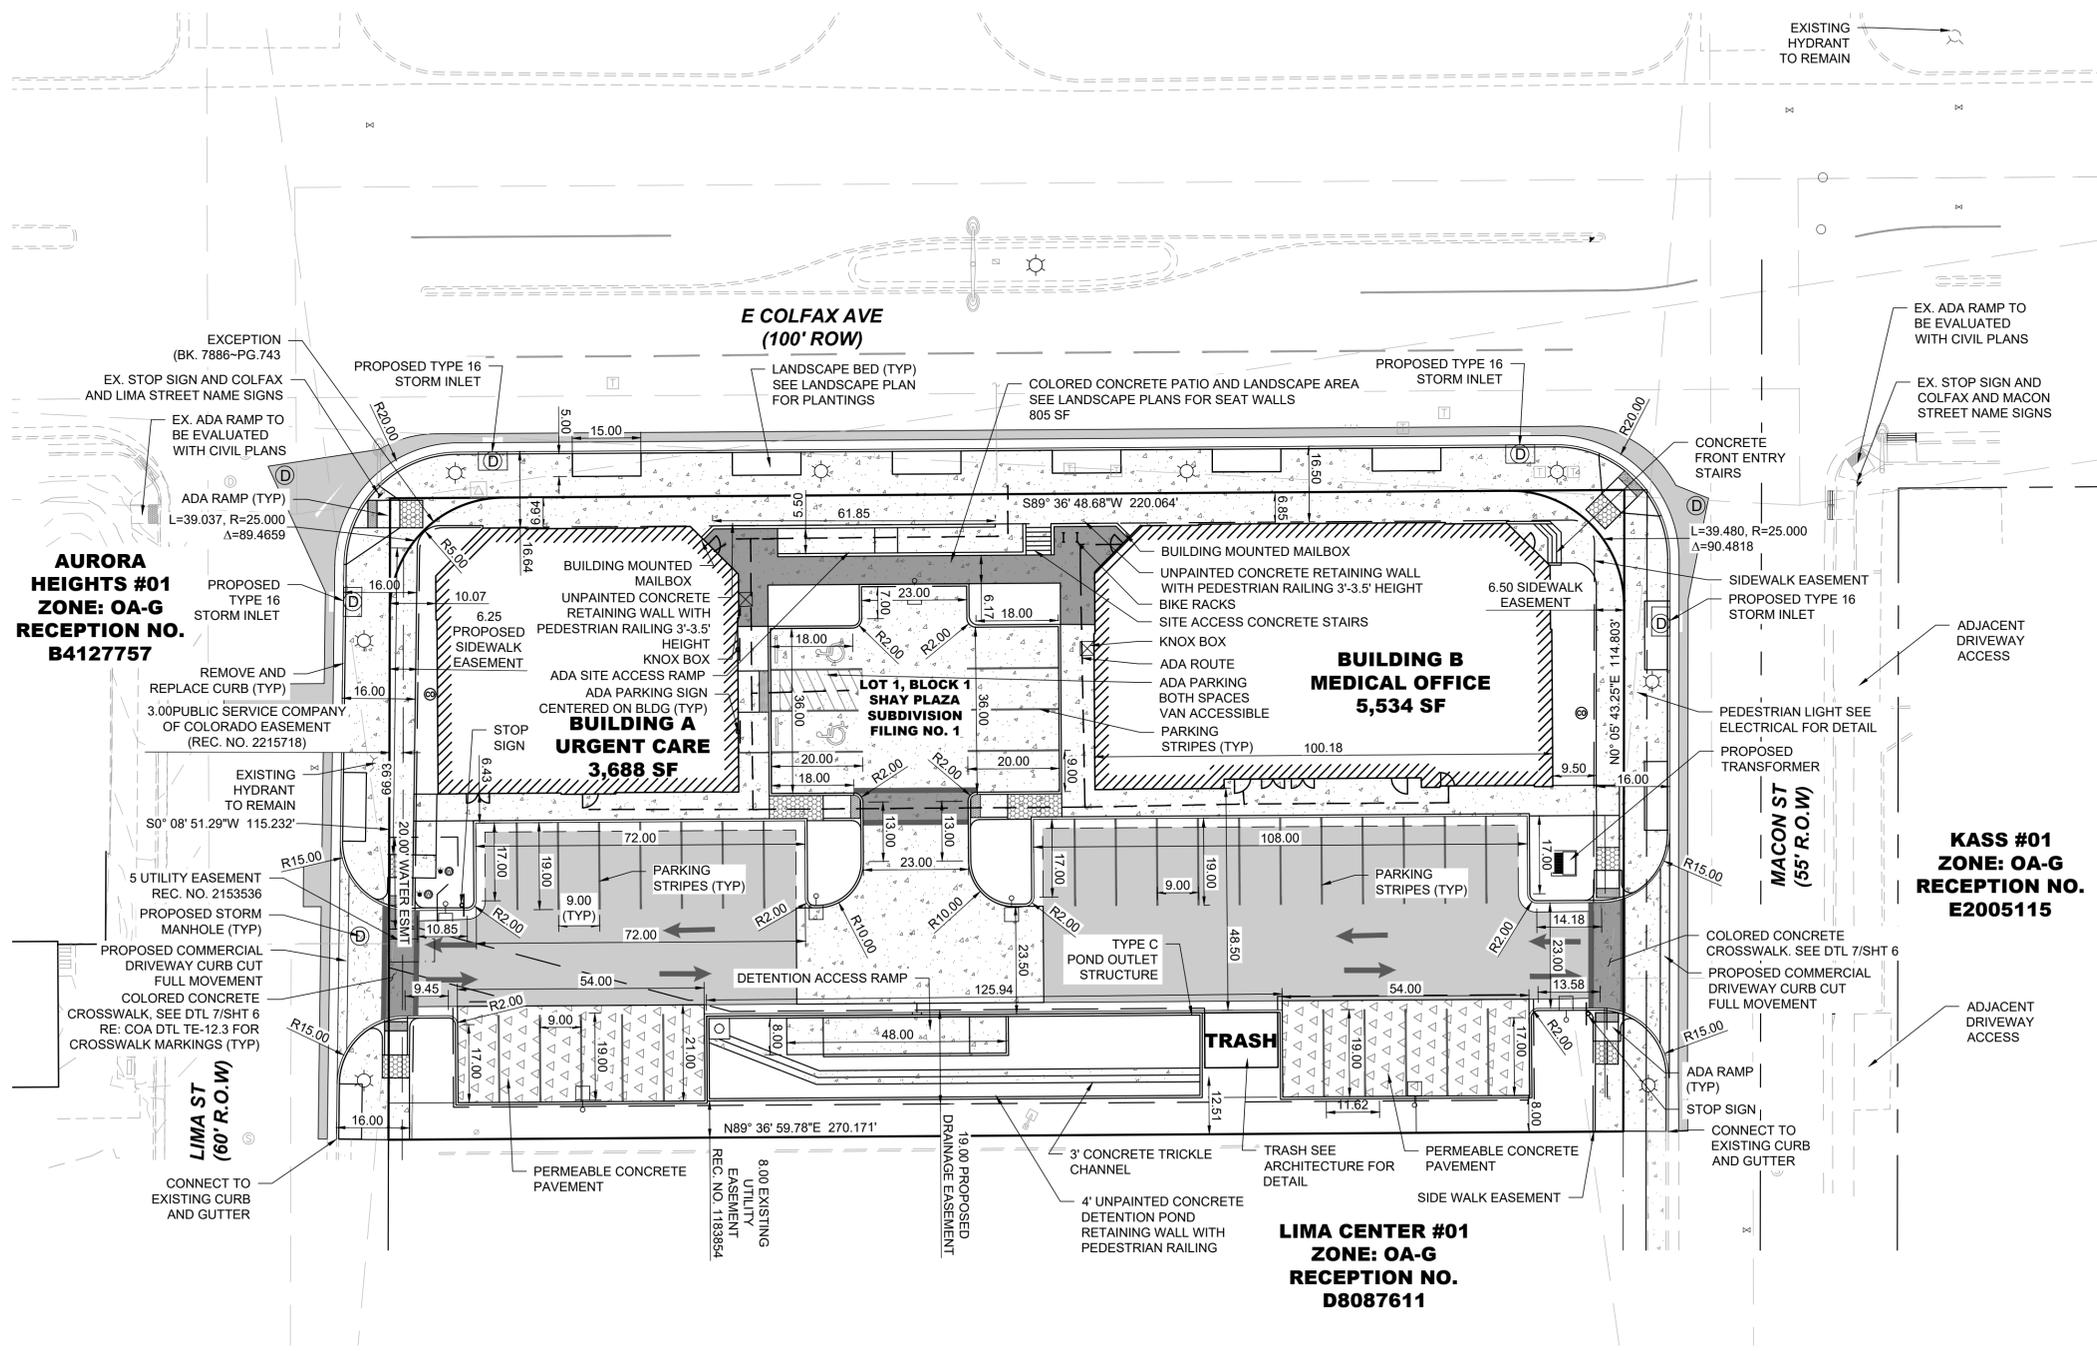

1 SITE PLAN
3




© 2023 | ALL RIGHTS RESERVED

SITE PLAN

04.26.2024
DRAWN BY | DOCTER
CHECKED BY | YOUNG
REVISIONS

SITE PLAN

NOT FOR CONSTRUCTION

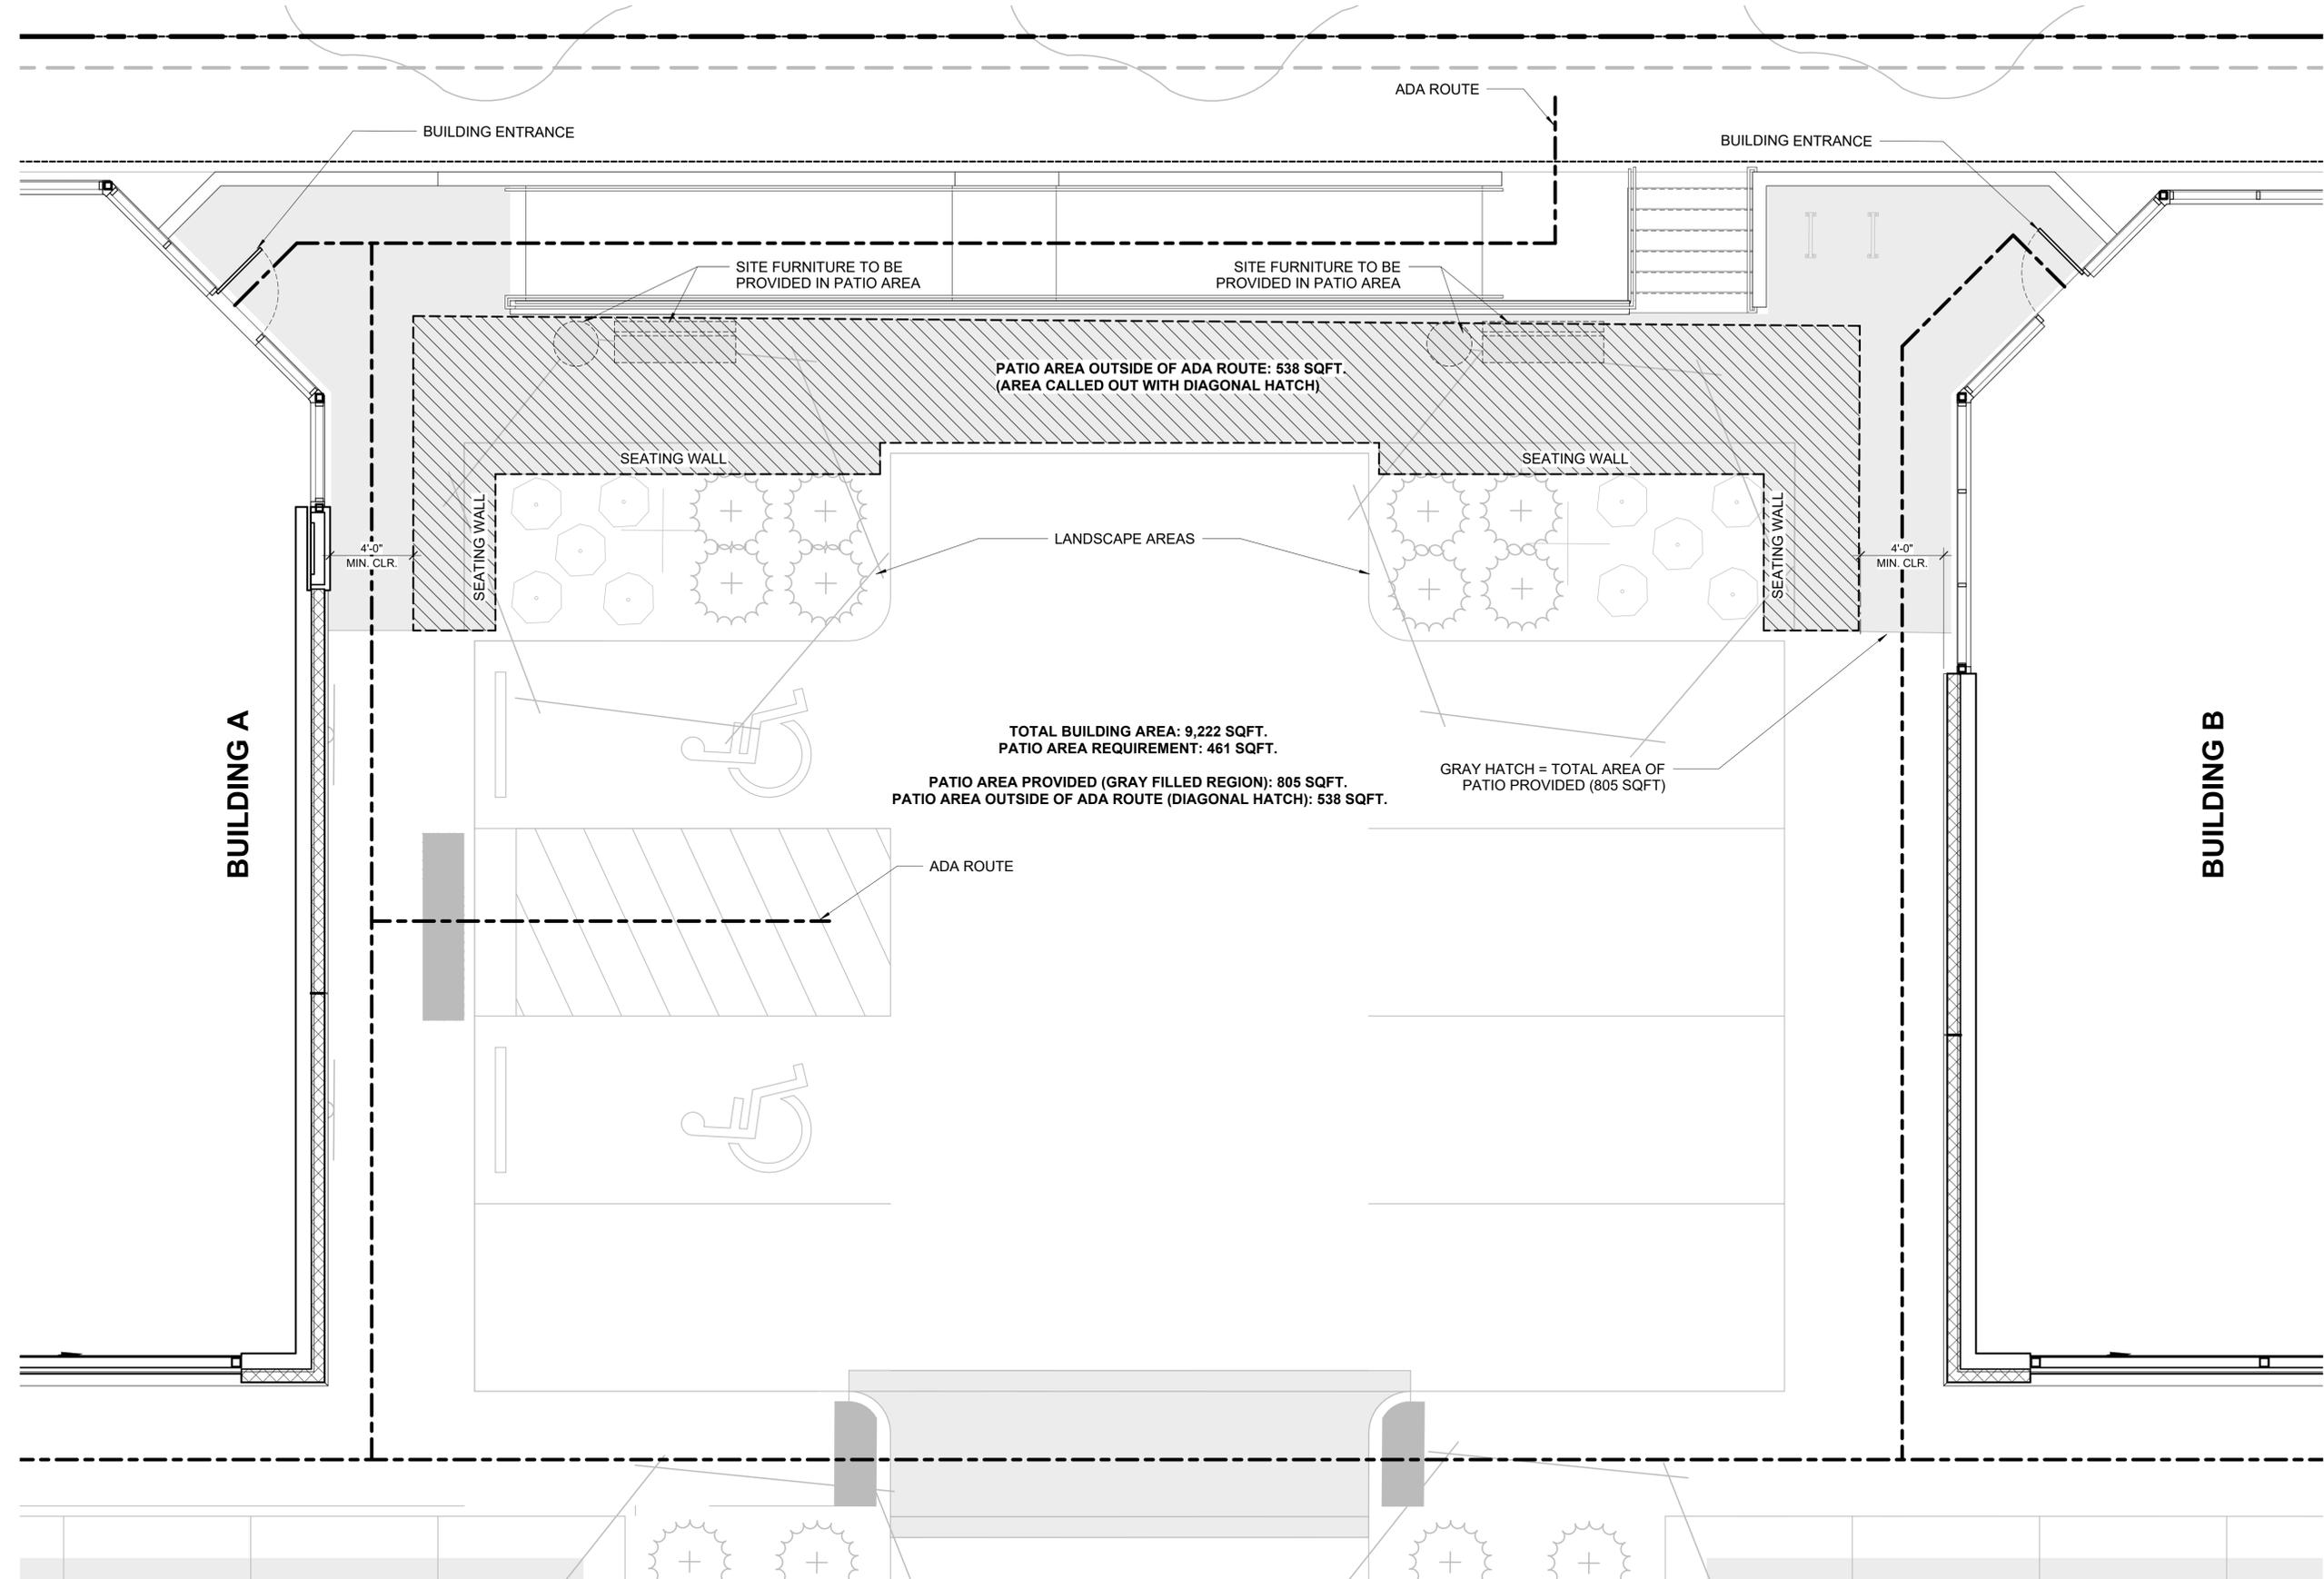

AFC URGENT CARE - SITE PLAN



© 2024 | ALL RIGHTS RESERVED

SITE PLAN


04.26.2024
PROJECT# | AFC_EASTCOLFAX2
DESIGNED BY | DOUGHERTY
DRAWN BY | SCHMALHORST
REVISIONS

PATIO DIAGRAM


NOT FOR CONSTRUCTION



NORTH REF

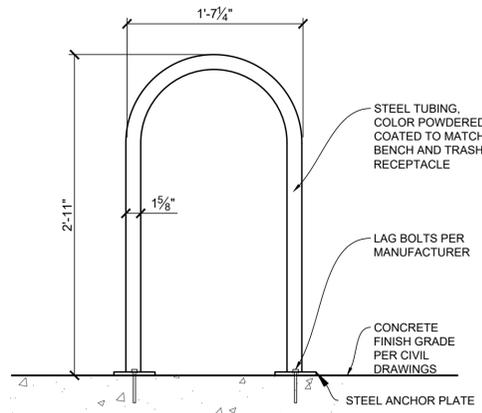


NOTE:
1. MAGLIN MBR500-00003 (MBR500-S), SURFACE MOUNTED, COLOR TO MATCH BENCH AND TRASH.
2. INSTALL PER MANUFACTURER'S RECOMMENDATIONS.

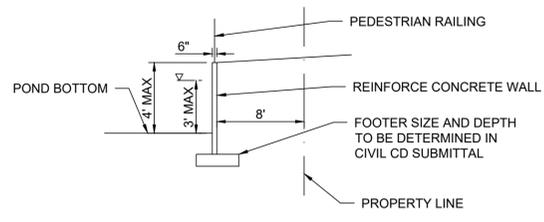


5 COMMERCIAL DRIVEWAY CURB RETURN

6 CONCEPTUAL RETAINING WALL SECTION

AFC URGENT CARE - SITE PLAN

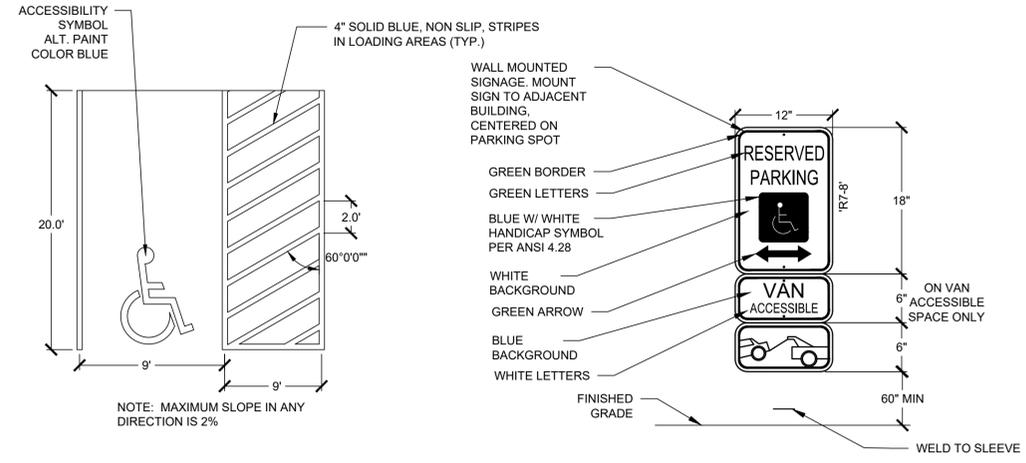

4 ADA PARKING DETAIL

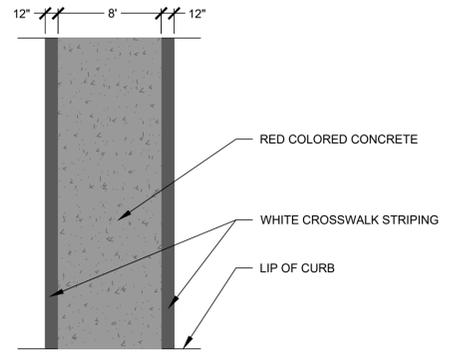

7 CROSSWALK DETAIL

© 2023 | ALL RIGHTS RESERVED

SITE PLAN

04.26.2024
DRAWN BY | DOCTER
CHECKED BY | YOUNG
REVISIONS

NOT FOR CONSTRUCTION


DETAILS SHEET


6

TREE MITIGATION TABLE					
TREE #	SPECIES	DIAMETER	MITIGATION VALUE	COMMENTS	MITIGATION INCHES
1	JUNIPER	8	\$205.93		2
2	JUNIPER	6	\$231.75		2
3	JUNIPER	7	\$315.37	MULTI-STEM	3
TOTAL		21	\$753.05		7

LEGEND

-  EXISTING TREE - TO REMAIN
-  EXISTING TREE - TO BE REMOVED

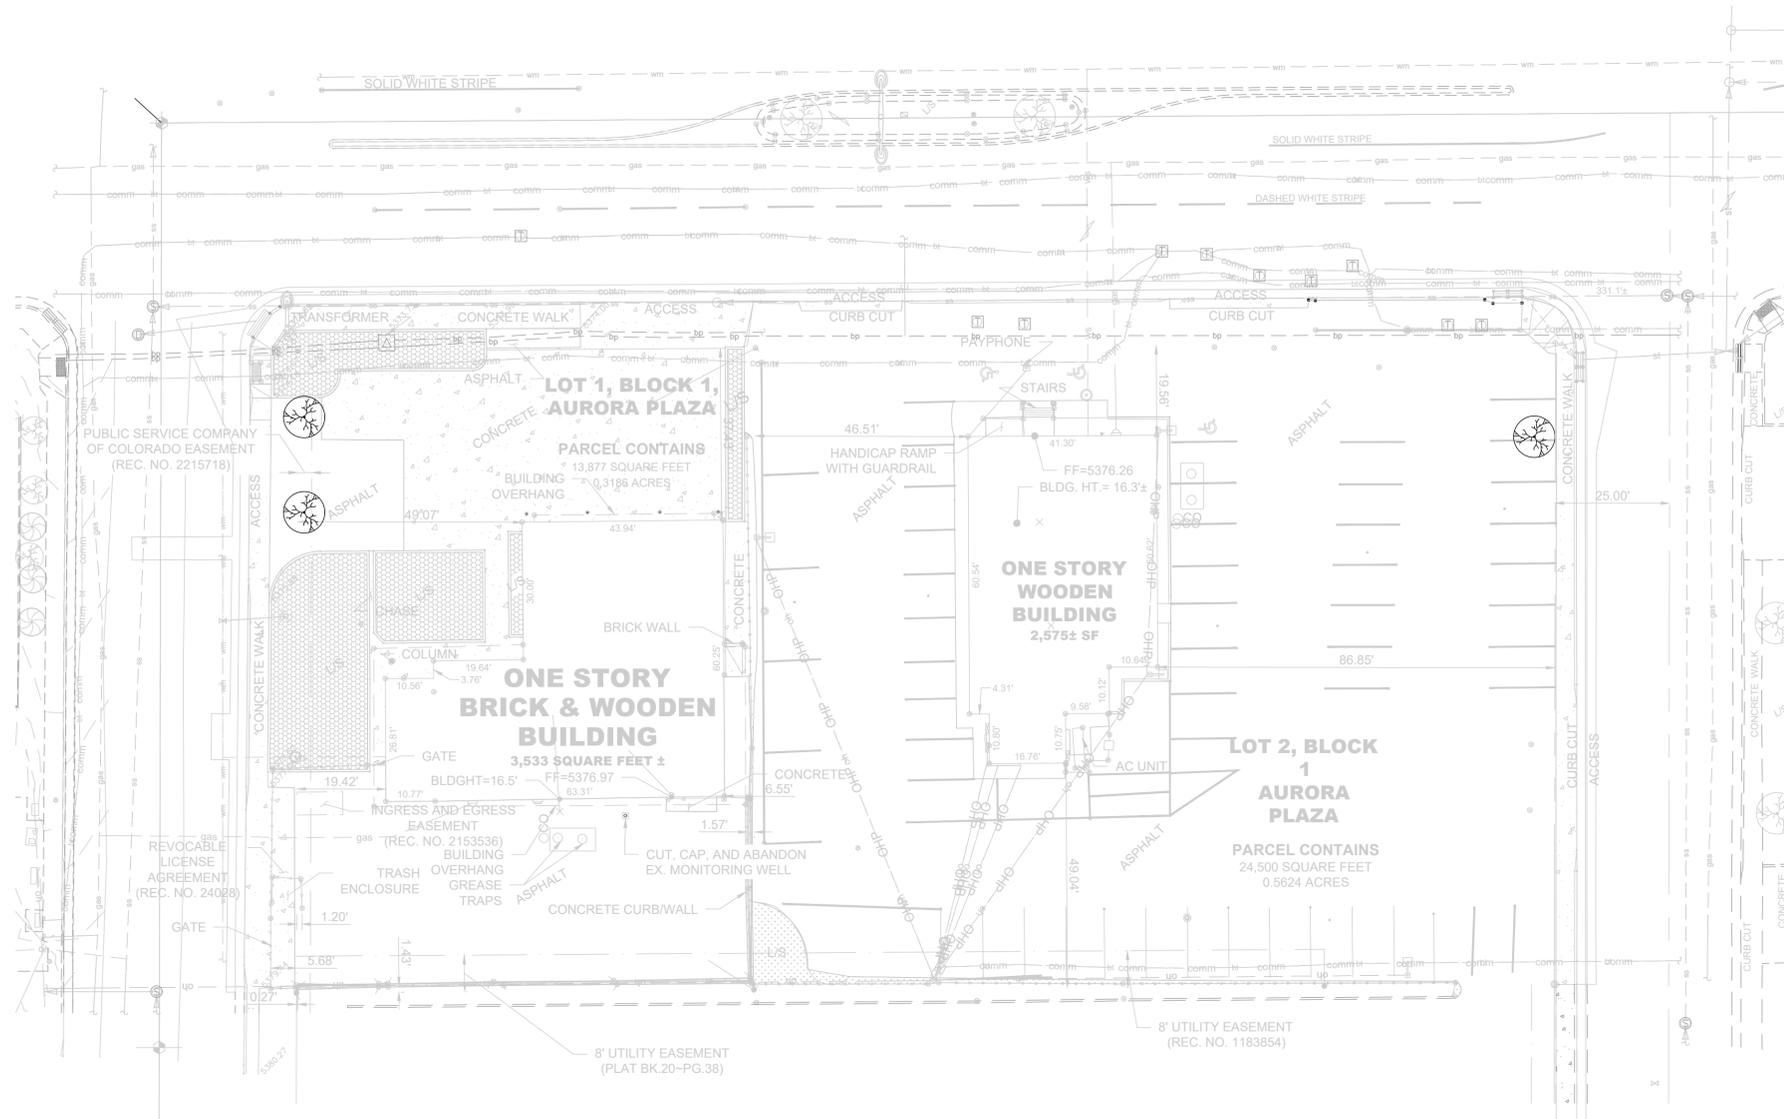

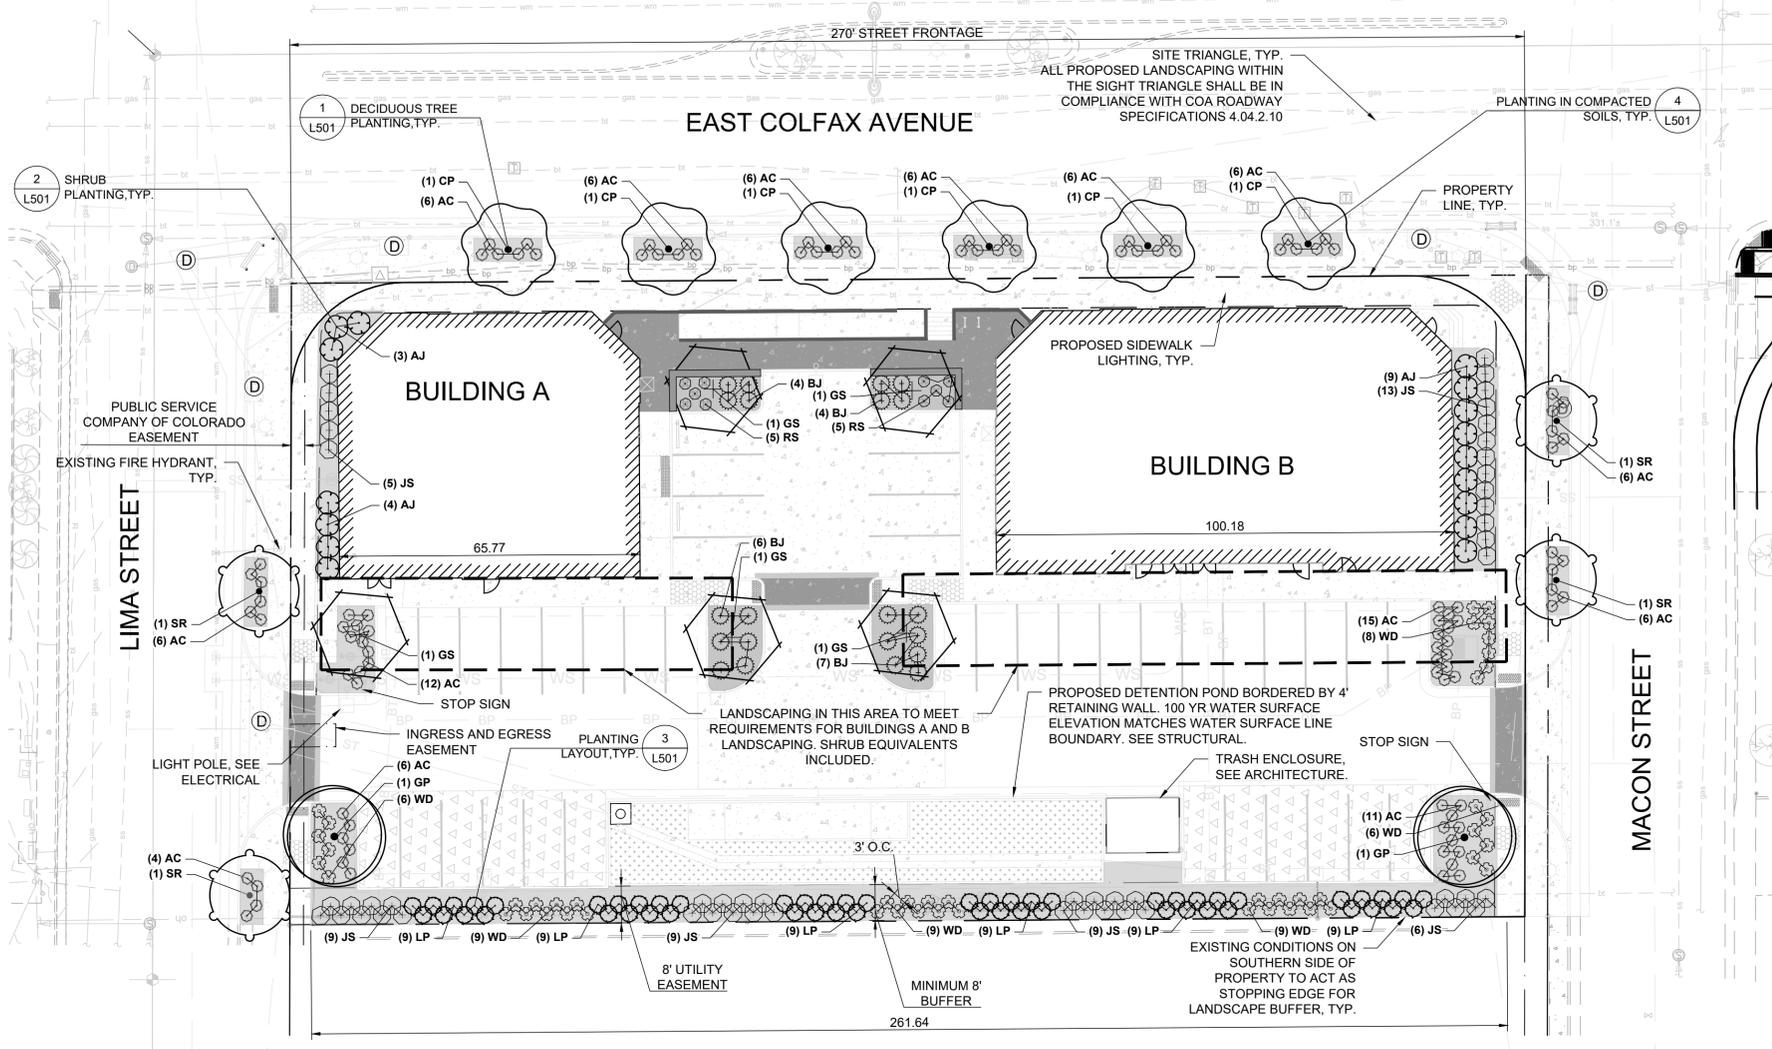

GENERAL NOTES

- A. SOIL AMENDMENTS WILL BE REQUIRED IN ACCORDANCE WITH SOIL TESTING ON-SITE.
- B. SITE LIGHTING WILL BE INCLUDED IN THIS PROJECT. THE TYPE OF LIGHTING TO BE INCLUDED WILL BE PEDESTRIAN LIGHTING, BUILDING MOUNTED LIGHTING, AND ROADWAY LIGHTING. SEE ELECTRICAL FOR MORE INFORMATION.
- C. SIDEWALKS ON-SITE WILL BE A STANDARD POLISHED CONCRETE. SPECIALTY PAVING WILL BE USED IN THE OUTDOOR PATIO AREA; THIS PAVING WILL BE A COLORED POLISHED CONCRETE. DRIVE ISLES AND PARKING AREAS ON-SITE TO BE STANDARD ASPHALT MATERIAL.
- D. ALL UTILITY EASEMENTS SHALL REMAIN UNOBSTRUCTED AND FULLY ACCESSIBLE ALONG THEIR ENTIRE LENGTH FOR MAINTENANCE EQUIPMENT ENTRY.
- E. THE DEVELOPER, HIS SUCCESSORS AND ASSIGNS, SHALL BE RESPONSIBLE FOR INSTALLATION, MAINTENANCE AND REPLACEMENT OF ALL LANDSCAPING MATERIALS SHOWN OR INDICATED ON THE APPROVED SITE PLAN OR LANDSCAPE PLAN ON FILE IN THE PLANNING DEPARTMENT. ALL LANDSCAPING WILL BE INSTALLED AS DELINEATED ON THE PLAN, PRIOR TO ISSUANCE OF CERTIFICATES OF OCCUPANCY.
- F. ALL PLANTING BEDS WILL BE TREATED WITH ORGANIC MULCH. MATERIAL TO BE 1"-2" SHREDDED WOOD AT A DEPTH OF 4".
- G. THE LANDSCAPE PLAN MUST REFLECT THE LOCATION OF ALL FIRE HYDRANTS, KNOX HARDWARE, AND FIRE DEPARTMENT CONNECTIONS TO ENSURE THAT THESE DEVICES ARE NOT PHYSICALLY OR VISUALLY OBSTRUCTED FROM RESPONDING FIRE CREWS. THE SEPARATION REQUIREMENTS FROM FIRE DEPARTMENT CONNECTIONS AND FIRE HYDRANTS MUST MEET BOTH FIRE LINE SAFETY (TYPICALLY 5 FEET AND NO MATERIAL GREATER THAN 2 FEET IN HEIGHT) AND LANDSCAPING REQUIREMENTS. LANDSCAPING MATERIAL CANNOT BE OMITTED OR REDUCED BASED ON THE INSTALLATION OF A FIRE HYDRANT(S) WITHIN A PARKING LOT ISLAND OR PLANT BED. IT IS RECOMMENDED THAT THE ISLAND OR PLANT BED BE CONSTRUCTED LARGE ENOUGH TO ADEQUATELY ACCOMMODATE BOTH LANDSCAPING MATERIAL AND FIRE HYDRANTS IN ORDER TO COMPLY WITH ALL CITY STANDARDS.
- H. A 5 FOOT CLEAR SPACE SHALL BE MAINTAINED AROUND THE CIRCUMFERENCE OF FIRE HYDRANTS.
- I. LANDSCAPING MATERIAL SHOWN WITHIN THE SITE PLAN CANNOT ENCROACH INTO ROADWAYS THAT ARE DEDICATED (OR DESIGNATED) AS FIRE LANE EASEMENTS (OR CORRIDORS).
- J. TREES WITHIN SITE TRIANGLES/DISTANCE TRIANGLES SHALL BE LIMBED UP TO 8' AS THE TREES MATURE.

STREET TREE TABLE				
STREET NAME	LF OF PROPERTY LINE ALONG STREET	CODE REQUIREMENT	# OF TREES REQUIRED	# OF TREES PROVIDED
EAST COLFAX AVENUE	235 LF	1 TREE PER 35 LF	235/35 = 6.7 = 7 TOTAL TREES REQUIRED	6 TREES PROVIDED*
LIMA STREET	140 LF	1 TREE PER 35 LF	64/35 = 2 TOTAL TREES REQUIRED	2 TREES PROVIDED
MACON STREET	140 LF	1 TREE PER 35 LF	58/35 = 2 TOTAL TREES REQUIRED	2 TREE PROVIDED

* = UTILITIES PREVENT INSTALLATION OF REQUIRED AMOUNT OF TREES

BUILDING PERIMETER LANDSCAPE TABLE			
BUILDING	LF OF BUILDING FACING SOUTH	CODE REQUIREMENT	# OF TREES PROVIDED
A	65.77 LF	1 TREE PER 40' OF BUILDING FACE	65.77/40 = 1.64 = 2 TOTAL TREES REQUIRED 1 TREES PROVIDED
B	100.18 LF	1 TREE PER 40' OF BUILDING FACE	100.18/40 = 2.50 = 2 TOTAL TREES REQUIRED 0 TREE PROVIDED


BUILDING PERIMETER SHRUB EQUIVALENTS			
BUILDING	CODE EQUIVALENT	# OF TREES PROVIDED	# OF SHRUBS PROVIDED
A	10 SHRUBS = 1 TREE EQUIVALENT	1 TREES PROVIDED	1 x 10 = 10 SHRUBS REQUIRED 12 SHRUBS PROVIDED*
B	10 SHRUBS = 1 TREE EQUIVALENT	0 TREE PROVIDED	2 x 10 = 20 SHRUBS REQUIRED 23 SHRUBS PROVIDED*

* = SHRUBS OUTSIDE OF EQUIVALENT BOUNDARY HAVE BEEN APPROVED TO COUNT TOWARDS TOTAL EQUIVALENT NUMBER

ABUTTING STREETS TABLE	
STREET NAME	SIDE OF PROPERTY IT ABUTS
LIMA STREET	WESTERN PROPERTY BOUNDARY
EAST COLFAX AVENUE	NORTHERN PROPERTY BOUNDARY
MACON STREET	EASTERN PROPERTY BOUNDARY


AURORA STANDARD SEED MIX FOR DETENTION PONDS

Common Name	Botanical Name	Growth Season	Growth Form	Seeds/Pound	Pounds of PLS/acre
Buffalograss	<i>Buchloe dactyloides</i>	Warm	Sod	52,000	2.0
Blue grama	<i>Bouteloua gracilis</i> (<i>Chondrosium gracilis</i>) 'Hachita'	Warm	Sod-forming bunch grass	825,000	3.0
Switchgrass	<i>Panicum virgatum</i> 'Blackwell'	Warm	Sod	389,000	6.0
Western Wheatgrass	<i>Pascopyrum smithii</i>	Cool	Sod	110,000	6.0
Sand dropseed	<i>Sporobolus cryptandrus</i>	Warm	Bunch	5,298,000	1.0
Inland saltgrass	<i>Distichlis stricta</i>	Warm	Sod	613,200	3.0
Prairie cordgrass	<i>Spartina pectinata</i>	Warm	Sod	183,000	1.0
Little Bluestem	<i>Schizachyrium scoparium</i> 'Blaze'	Warm	Bunch	260,000	2.0
Sideoats Grama	<i>Bouteloua curtipendula</i>	Warm	Sod	191,000	3.0
Green Needlegrass	<i>Stipa viridula</i> 'Lodorn'	Cool	Bunch	181,000	1.0
Big Bluestem	<i>Andropogon gerardi</i> 'Pawnee'	Warm	Bunch	144,240	1.0
Yellow Indiangrass	<i>Sorghastrum nutans</i> 'Holt'	Warm	Bunch	174,720	1.0
Total					30.0

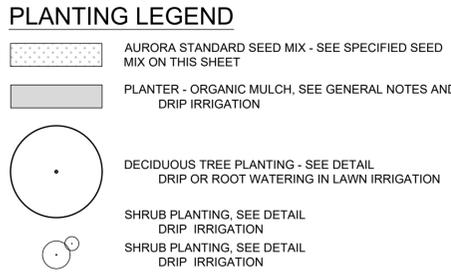


PLANT SCHEDULE

CODE	QTY	BOTANICAL NAME	COMMON NAME	INSTALL SIZE	PKG.	MATURE SIZE
TREES						
CP	6	CELTIS OCCIDENTALIS 'PRAIRIE PRIDE'	PRAIRIE PRIDE HACKBERRY	2.5" CAL.	B&B	40-50' H X 30-40' W
GP	2	GINKGO BILOBA 'PRINCETON SENTRY'	PRINCETON SENTRY	2" CAL.	B&B	30-50' H X 15-30' W
GS	5	GLEDITSIA TRIACANTHOS 'INERMIS' 'SHADEMASTER'	SHADEMASTER HONEY LOCUST	2" CAL.	B&B	40-60' H X 20-40' W
SR	4	SYRINGA RETICULATA	JAPANESE TREE LILAC	2" CAL.	B&B	25' H X 25' W
SHRUBS						
WD	47	DAPHNE ODORA 'REBECCA'	REBECCA WINTER DAPHNE	5 GAL.	POT	3-4' H X 3-4' W
BJ	21	JUNIPERUS SABINA 'BROADMOOR'	BROADMOOR JUNIPER	5 GAL.	POT	2-3' H X 4-6' W
LP	54	LIGUSTRUM VULGARE 'LODENSE'	LODENSE PRIVET	5 GAL.	POT	2-3' H X 2-3' W
RS	10	PEROVSKIA ATRIPLICIFOLIA 'BLUE SPIRES'	BLUE SPIRES RUSSIAN SAGE	5 GAL.	POT	2-3' H X 2-3' W
AJ	16	PHYSOCARPUS OPULIFOLIUS 'JEFAM' TM	AMBER JUBILEE NINEBARK	5 GAL.	POT	5'-6' H X 5'-6' W
AC	102	RIBES ALPINUM 'GREEN MOUND'	GREEN MOUND ALPINE CURRANT	5 GAL.	POT	2-3' H X 2-3' W
JS	51	SPIRAEA JAPONICA 'FROEBELII'	FROEBELII JAPANESE SPIREA	5 GAL.	POT	3-6' H X 3-6' W

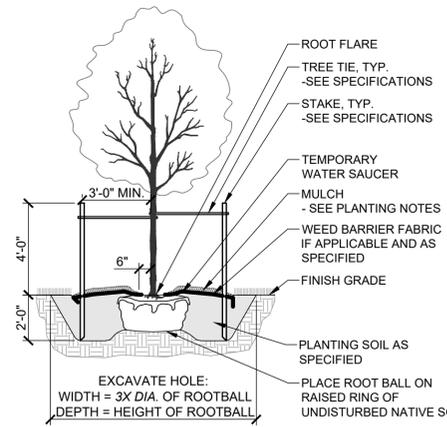


- NOTES:**
1. SEE PLANTING GENERAL NOTES AND SPECIFICATIONS FOR MORE INFORMATION.
 2. REMOVE ALL TWINE, STRING, AND WIRE FROM ROOTBALL. REMOVE BURLAP FROM TOP THIRD OF ROOTBALL.
 3. THE ROOT FLARE OF ALL TREES SHALL BE LEVEL WITH OR UP TO 1" ABOVE GRADE.
 4. ALL TREES SHALL BE INSTALLED WITH A TEMPORARY SAUCER OF RAISED SOIL AT THE EDGE OF ROOT BALL TO CONTAIN WATER. REMOVE OR BREACH WATER SAUCER BEFORE WINTER. PULL MULCH AWAY FROM TRUNK A MINIMUM OF 6".

1
9 DECIDUOUS TREE PLANTING 1/4" = 1'-0"

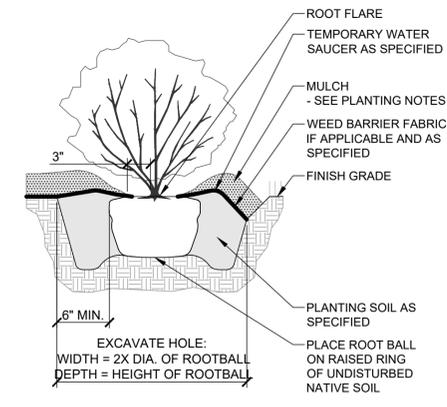


- NOTES:**
1. SEE PLANTING GENERAL NOTES AND SPECIFICATIONS FOR MORE INFORMATION.
 2. REMOVE ALL ROOT CONTAINMENT MATERIALS FROM ROOTBALL.
 3. THE ROOT FLARE OF ALL SHRUBS SHALL BE LEVEL WITH OR UP TO 1" ABOVE GRADE.
 4. ALL SHRUBS SHALL BE INSTALLED WITH A TEMPORARY SAUCER OF RAISED SOIL AT THE EDGE OF ROOT BALL TO CONTAIN WATER. REMOVE OR BREACH WATER SAUCER BEFORE WINTER.
 5. PULL MULCH AWAY FROM TRUNK A MINIMUM OF 6".

2
9 SHRUB PLANTING 1/4" = 1'-0"

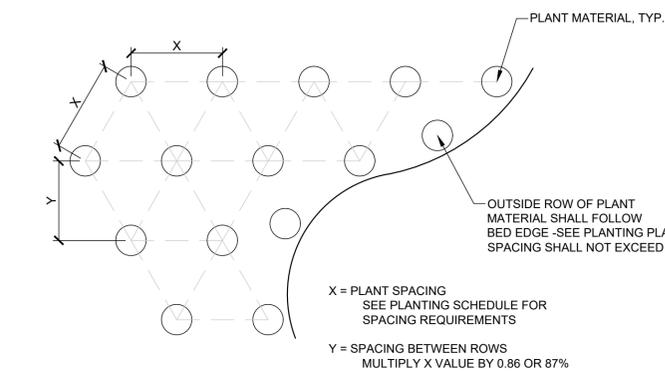

3
9 PLANTING LAYOUT 1/4" = 1'-0"

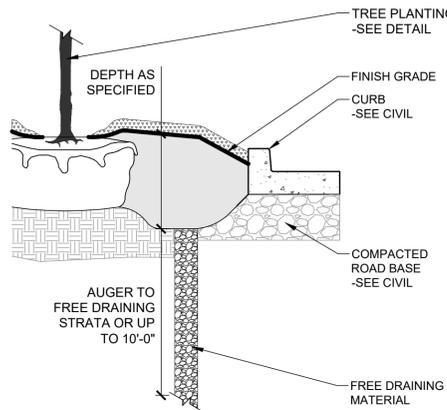


- NOTES:**
1. INSTALL DRAINAGE FOR EACH TREE WITHIN ALL COMPACTED OR HARDPAN AREAS. COMPACTED AREAS MAY INCLUDE SURFACES PREVIOUSLY PAVED AND/OR ADJACENT FOUNDATIONS.
 2. PLACE HOLE WITHIN EXCAVATED AREA AT LOWEST POINT - NOT UNDER ROOT BALL.
 3. AUGER 6" MIN. DIAMETER HOLE TO FREE DRAINING STRATA UP TO 10' DEEP.
 4. FOR MULTIPLE TREES - AUGERED HOLES WILL BE A MINIMUM OF 24" APART.

4
9 PLANTING IN COMPACTED SOILS 1/4" = 1'-0"

AFC URGENT CARE - SITE PLAN

NOT FOR CONSTRUCTION

EAST COLFAX AVENUE

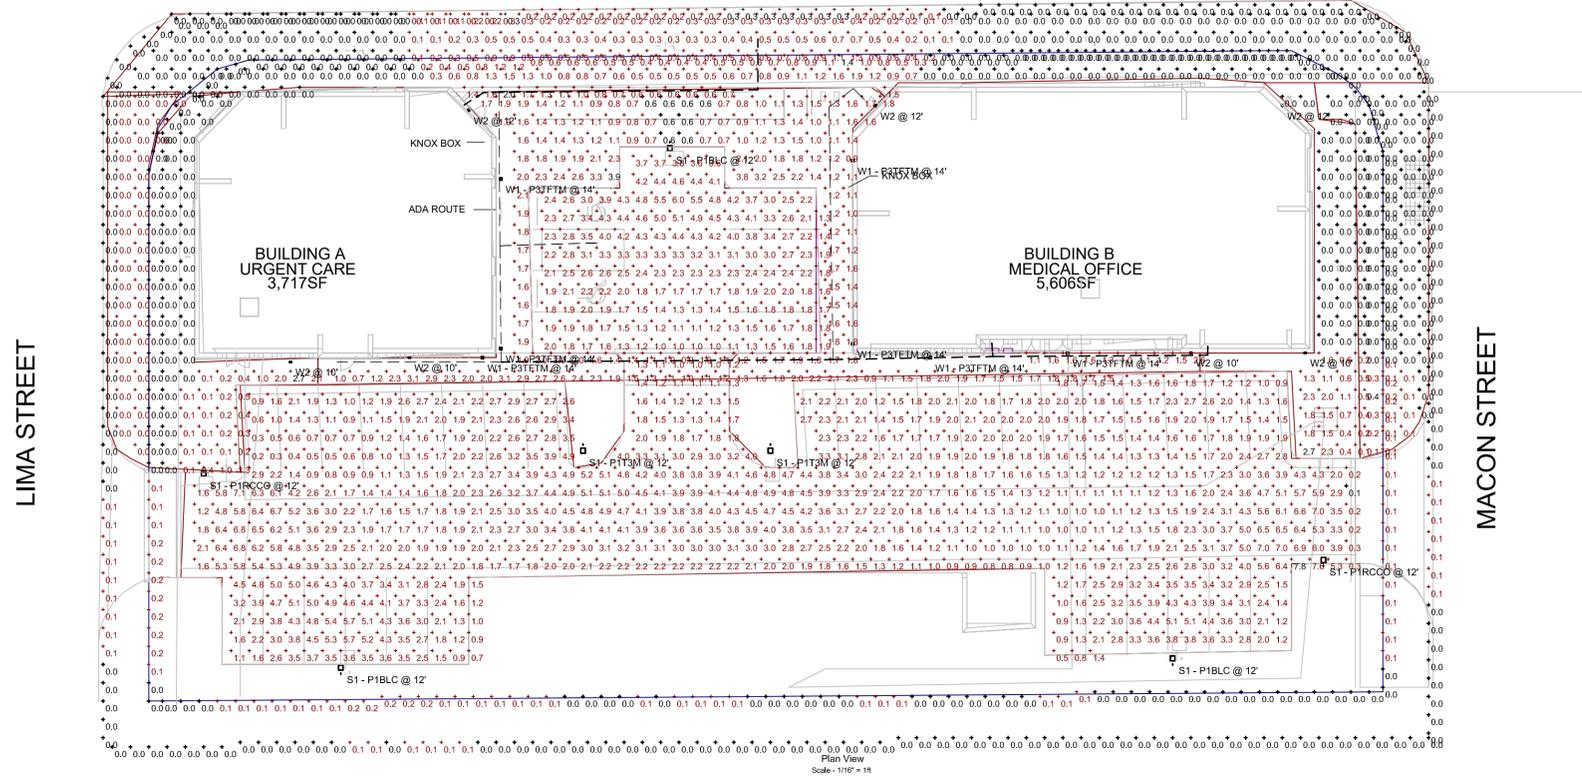

Symbol	Label	Quantity	Manufacturer	Catalog Number	Description	Number Lamps	Lumens Per Lamp	Light Loss Factor
□	S1 - P1BL C	3	Lithonia Lighting	DSX1 LED P1 30K 80CRI BLC3	D-Series Size 1 Area Luminaire P1 Performance Package 3000K CCT 80 CRI Type 3 Extreme Backlight Control	1	4811	0.85
□	W1 - P3TF TM	7	Lithonia Lighting	WDGE2 LED P3 30K 80CRI TFTM	WDGE2 LED WITH P3 - PERFORMANCE PACKAGE, 3000K, 80CRI, TYPE FORWARD THROW MEDIUM OPTIC	1	3015	0.85
□	S1 - P1T3 M	2	Lithonia Lighting	DSX1 LED P1 30K 80CRI T3M	D-Series Size 1 Area Luminaire P1 Performance Package 3000K CCT 80 CRI Type 3 Medium	1	6615	0.85
□	S1 - P1LC CO	0	Lithonia Lighting	DSX1 LED P1 30K 80CRI LCCO	D-Series Size 1 Area Luminaire P1 Performance Package 3000K CCT 80 CRI Left Corner Cutoff Extreme Backlight Control	1	4855	0.85
□	S1 - P1RC CO	2	Lithonia Lighting	DSX1 LED P1 30K 80CRI RCCO	D-Series Size 1 Area Luminaire P1 Performance Package 3000K CCT 80 CRI Right Corner Cutoff Extreme Backlight Control	1	4855	0.85
□	W2	7	Lithonia Lighting	WDGE1 LED P0 30K 80CRI VF	WDGE1 LED WITH P0 - PERFORMANCE PACKAGE, 3000K, 80CRI, VISUAL COMFORT FORWARD OPTIC	1	718	0.85

Description	Symbol	Avg	Max	Min	MaxMin	AvgMin
Colfax Sidewalk	+	0.3 fc	2.0 fc	0.0 fc	N/A	N/A
Lima Bkgs. Adj. Sidewalk	+	0.2 fc	2.7 fc	0.0 fc	N/A	N/A
Lima Sidewalk	+	0.0 fc	0.0 fc	0.0 fc	N/A	N/A
Macdon Bkgs. Adj. Sidewalk	+	0.4 fc	2.7 fc	0.0 fc	N/A	N/A
Macdon Sidewalk	+	0.0 fc	0.4 fc	0.0 fc	N/A	N/A
Parking Area	+	2.8 fc	7.5 fc	0.1 fc	78.9 ft	29.2 ft
Property Line	+	0.1 fc	1.4 fc	0.0 fc	N/A	N/A
Property Line +10'	+	0.0 fc	0.3 fc	0.0 fc	N/A	N/A
ADA ACCESSIBLE ROUTE	+	1.5 fc	3.9 fc	0.6 fc	6.5 ft	2.5 ft



STREET NAME	ROADWAY CLASSIFICATION	NUMBER OF LANES	BACK-TO-BACK CURB WIDTH	ADJACENT LAND USE CATEGORY	PEDESTRIAN ACTIVITY LEVEL	PAVEMENT TYPE
COLFAX	MAJOR ARTERIAL	4	79'	URBAN	HIGH	R3
LIMA	LOCAL	2	32'	URBAN	HIGH	R3
MACON	LOCAL	2	32'	URBAN	HIGH	R3



AFC URGENT CARE - SITE PLAN


NOT FOR CONSTRUCTION

© 2023 | ALL RIGHTS RESERVED

SITE PLAN

04.26.2024
DRAWN BY | FAULKNER
CHECKED BY | MORANVILLE
REVISIONS

PHOTOMETRIC SITE PLAN

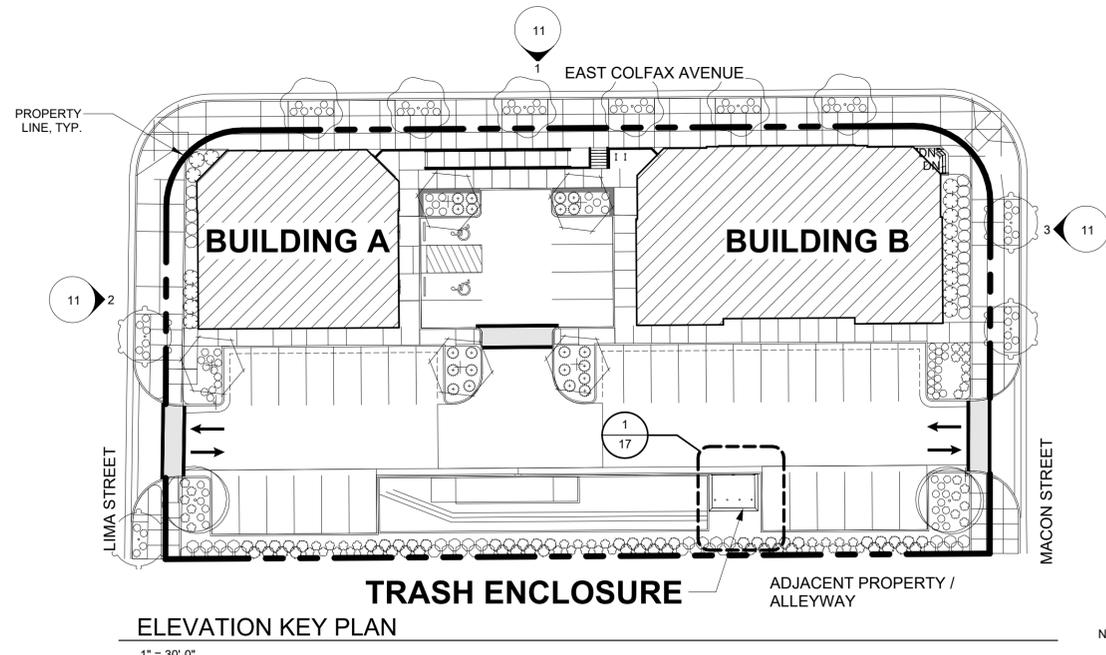


KEY PLAN LEGEND

- ELEVATION VIEW NUMBER
- DIRECTION OF VIEW, IF APPLICABLE
- A101 SHEET WHERE ELEVATION VIEW IS LOCATED ON


ELEVATION FINISHES	
SYMBOL	DESCRIPTION
CMU-1	CMU, RUNNING BOND BASALITE: 720WR
CMU-2	CMU, RUNNING BOND BASALITE: 807WR
CMU-3	CMU, RUNNING BOND, 2" PROTRUDING WATERTABLE SILL BASALITE: 605WR
CMU-4	2" PROTRUDING SINGLE COURSE CMU, RUNNING BOND BASALITE: 807WR (SAME MATERIAL AS CMU-2)
FC-1	CEMENT BOARD PANEL NICHIHA: VINTAGEWOOD - ASH
ST-1	STUCCO WITH MOISTURE DRAINAGE. COLOR: BENJAMIN MOORE, OC-130 - CLOUD WHITE
AL-1	ALUMINUM STOREFRONT, TYPICAL

BUILDING ELEVATIONS LEGEND


CG CLEAR GLAZING STOREFRONT ASSEMBLY

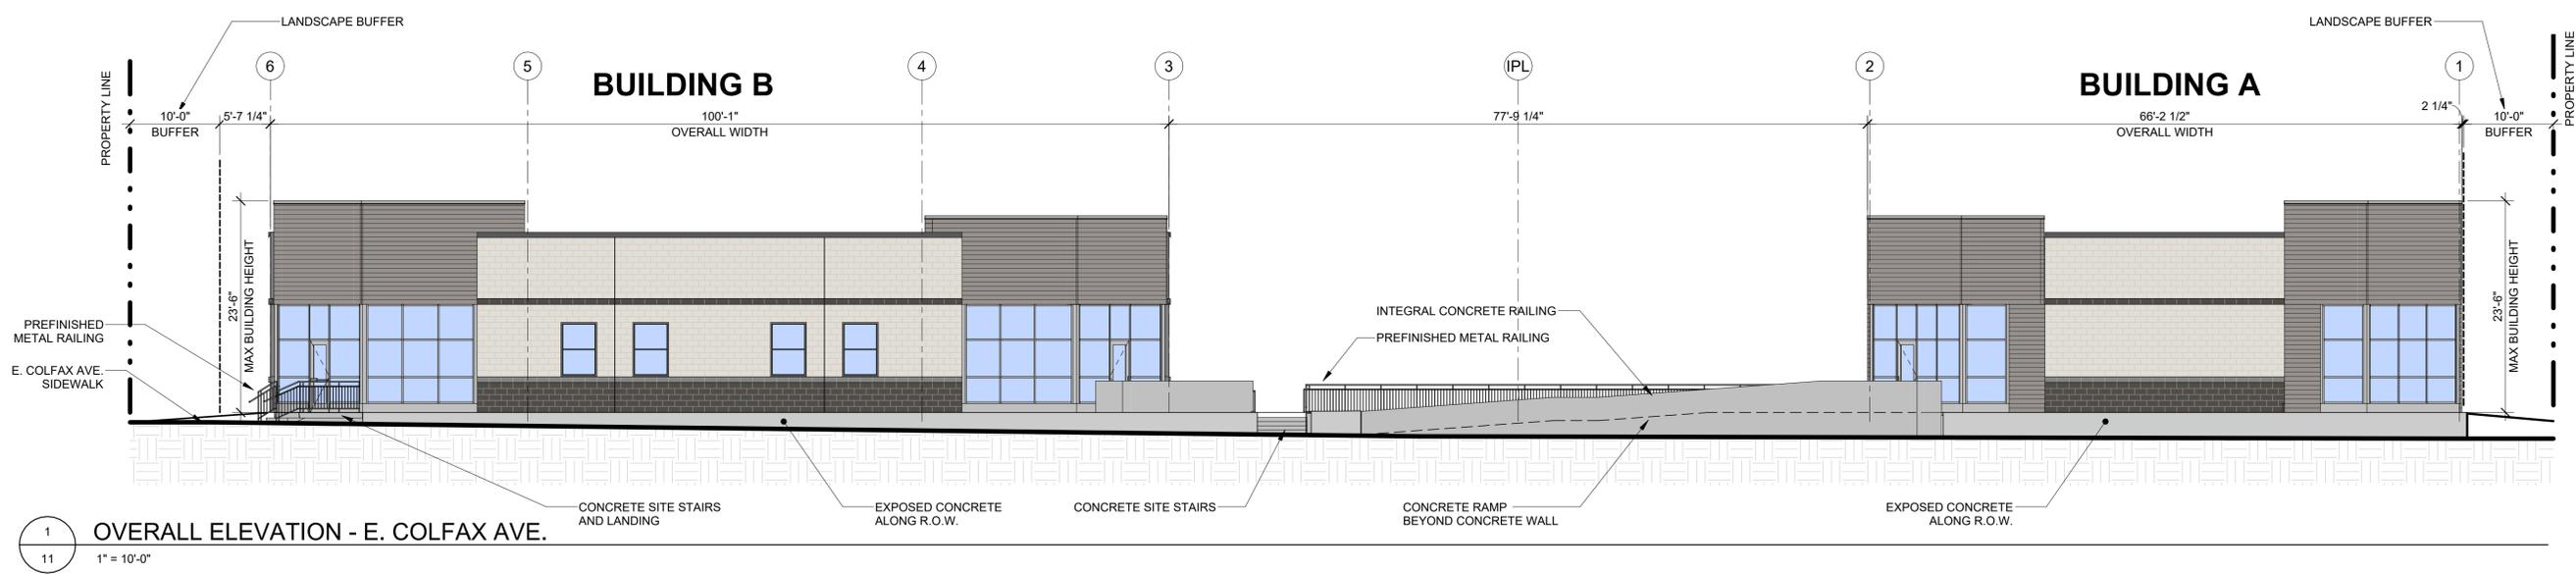

1 OVERALL ELEVATION - E. COLFAX AVE.
 11 1" = 10'-0"

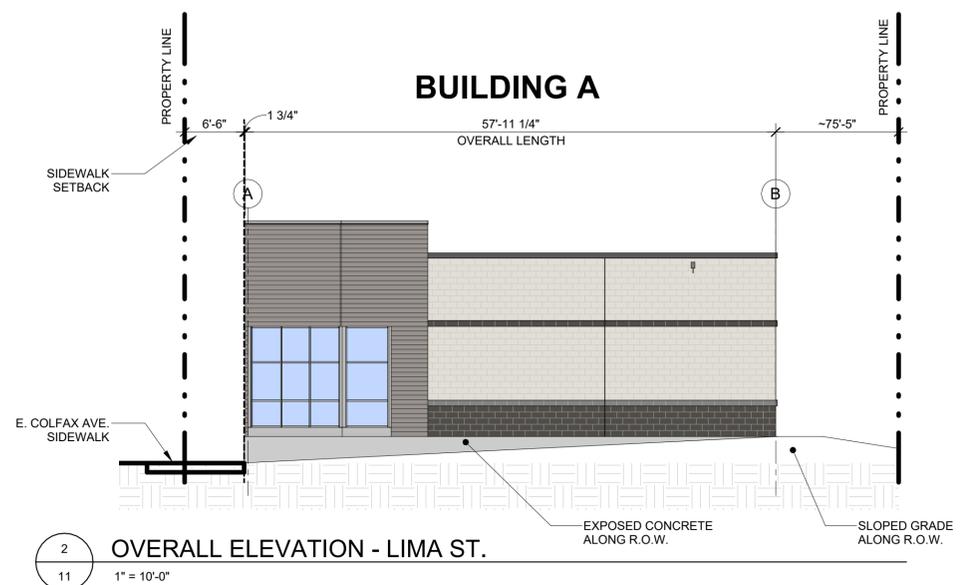

2 OVERALL ELEVATION - LIMA ST.
 11 1" = 10'-0"

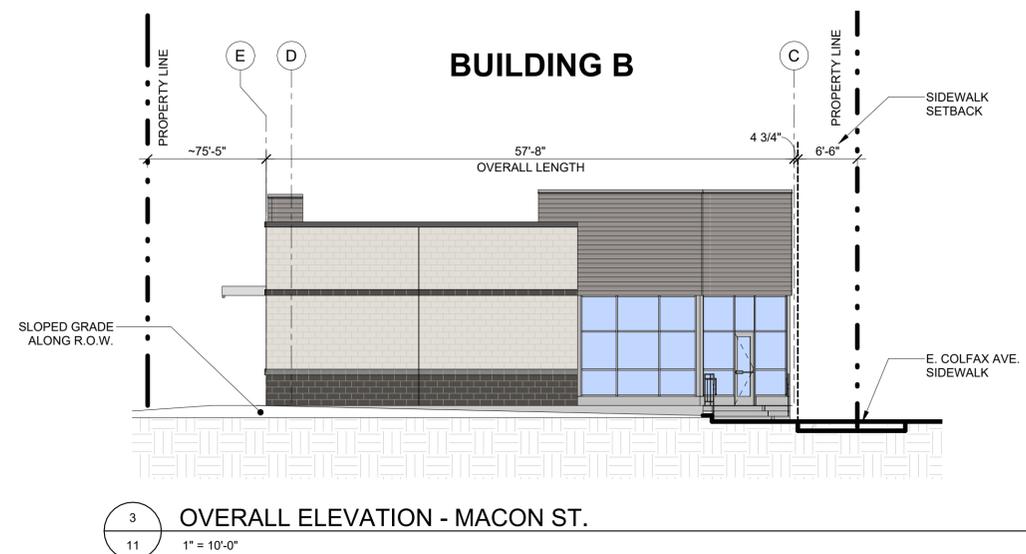

3 OVERALL ELEVATION - MACON ST.
 11 1" = 10'-0"

AFC URGENT CARE - SITE PLAN


© 2024 | ALL RIGHTS RESERVED

SITE PLAN


04.26.2024
 PROJECT# | AFC_EASTCOLFAX2
 DESIGNED BY | DOUGHERTY
 DRAWN BY | SCHMALHORST
 REVISIONS

NOT FOR CONSTRUCTION

OVERALL STREET ELEVATIONS

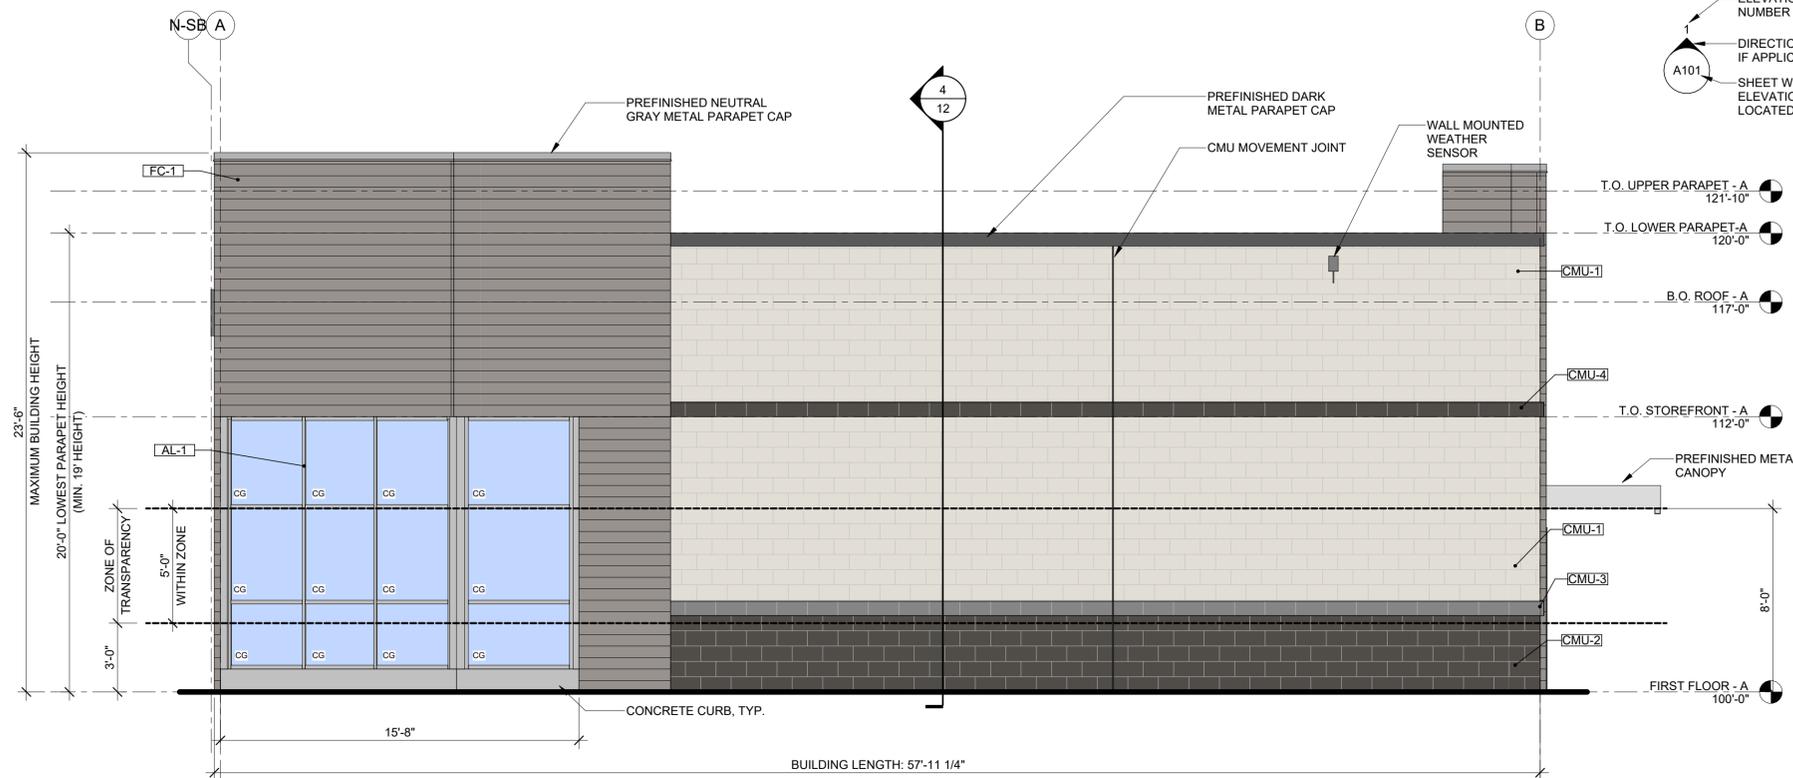


1 BUILDING A WEST ELEVATION (LIMA ST.) - PRIMARY BUILDING FACE
1/4" = 1'-0"

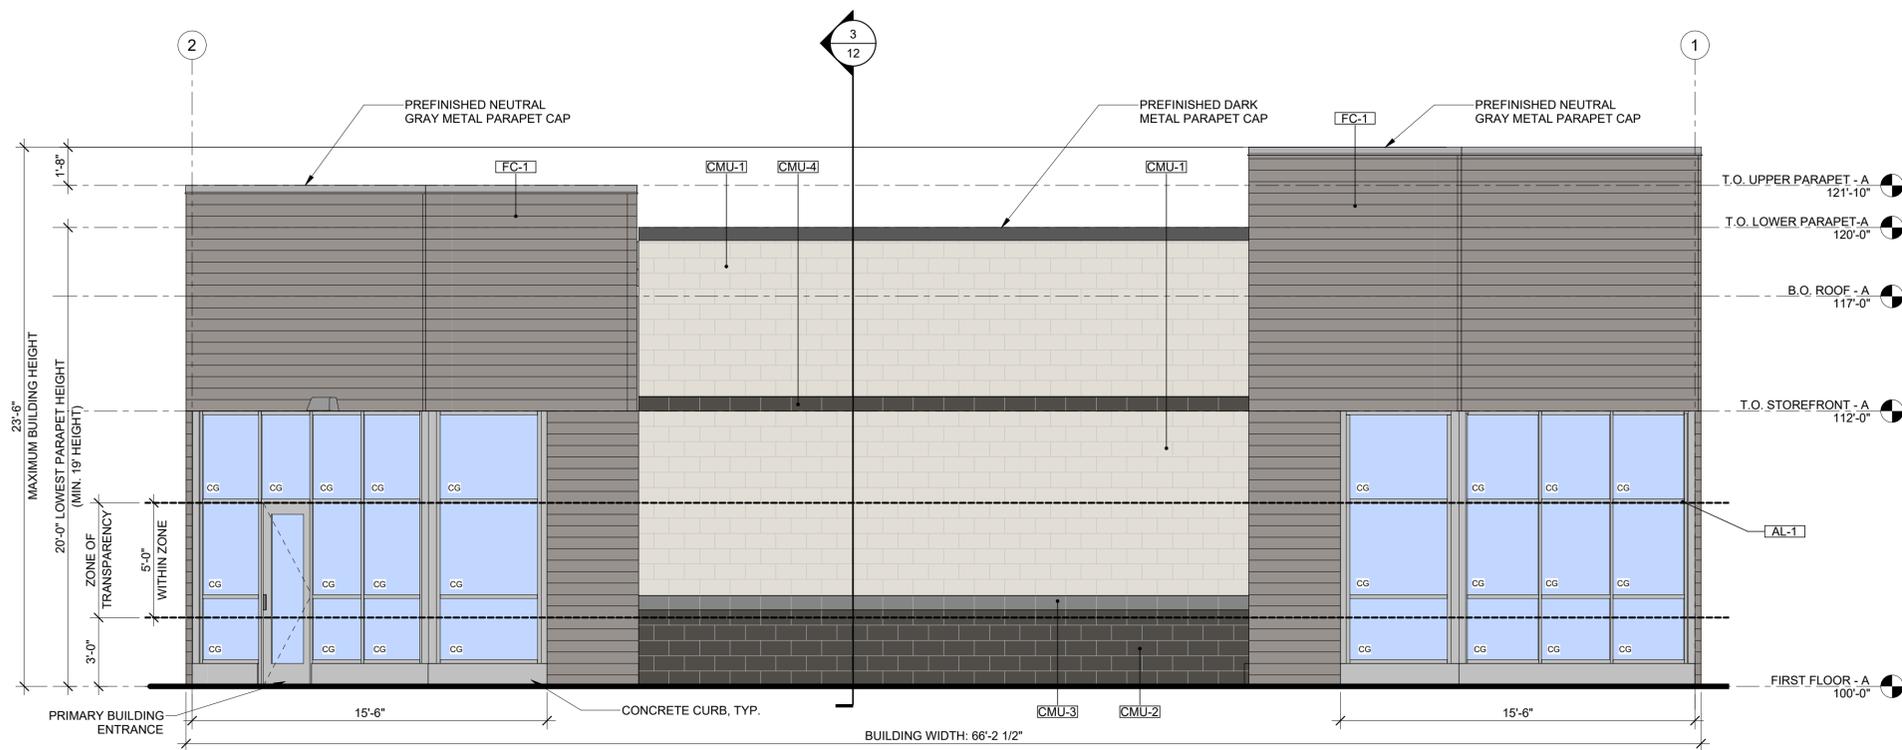

2 BUILDING A - NORTH EXTERIOR ELEVATION (E.COLFAX AVE.) - PRIMARY BUILDING FACE
1/4" = 1'-0"

KEY PLAN LEGEND

- ELEVATION VIEW NUMBER
- DIRECTION OF VIEW, IF APPLICABLE
- SHEET WHERE ELEVATION VIEW IS LOCATED ON

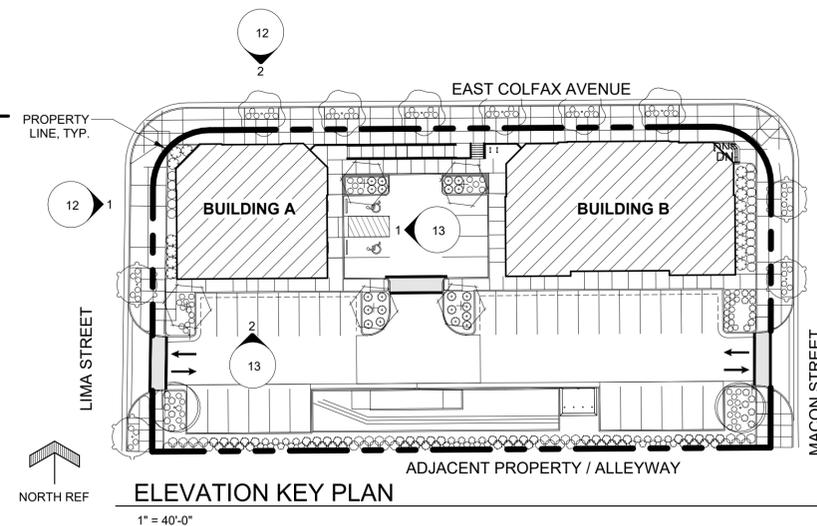


ELEVATION KEY PLAN
1" = 40'-0"

ELEVATION FINISHES	
SYMBOL	DESCRIPTION
CMU-1	CMU, RUNNING BOND BASALITE: 720WR
CMU-2	CMU, RUNNING BOND BASALITE: 807WR
CMU-3	CMU, RUNNING BOND, 2" PROTRUDING WATERTABLE SILL BASALITE: 605WR
CMU-4	2" PROTRUDING SINGLE COURSE CMU, RUNNING BOND BASALITE: 807WR (SAME MATERIAL AS CMU-2)
FC-1	CEMENT BOARD PANEL NICHHA: VINTAGEWOOD - ASH
ST-1	STUCCO WITH MOISTURE DRAINAGE. COLOR: BENJAMIN MOORE, OC-130 - CLOUD WHITE
AL-1	ALUMINUM STOREFRONT, TYPICAL


BUILDING ELEVATIONS LEGEND

CG CLEAR GLAZING STOREFRONT ASSEMBLY

GROUND STORY ACTIVATION (TRANSPARENCY) - BUILDING A	REQUIRED (MIN)	PROVIDED
PRIMARY STREET - COLFAX AVE.		
TOTAL TRANSPARENCY (%) BUILDING WIDTH CLEAR GLAZING	66'-2 1/2" 31'-0"	40% 47%
SIDE STREET - LIMA ST.		
TOTAL TRANSPARENCY (%) BUILDING LENGTH CLEAR GLAZING	57'-11 1/4" 15'-8"	N/A 27%

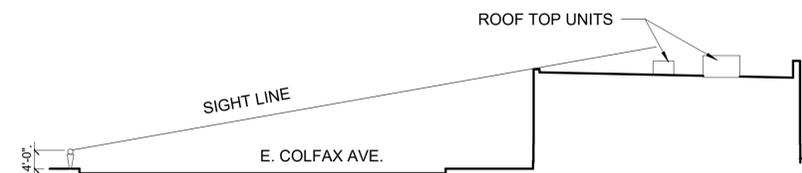


3 BUILDING A - E. COLFAX AVE. RTU VIEW SDP
1" = 20'-0"

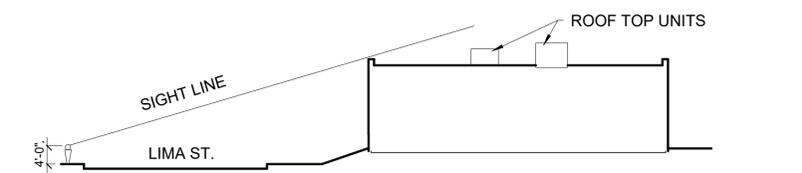

4 BUILDING A - LIMA ST. RTU VIEW SDP
1" = 20'-0"

KEY PLAN LEGEND

- ELEVATION VIEW NUMBER
- DIRECTION OF VIEW, IF APPLICABLE
- SHEET WHERE ELEVATION VIEW IS LOCATED ON


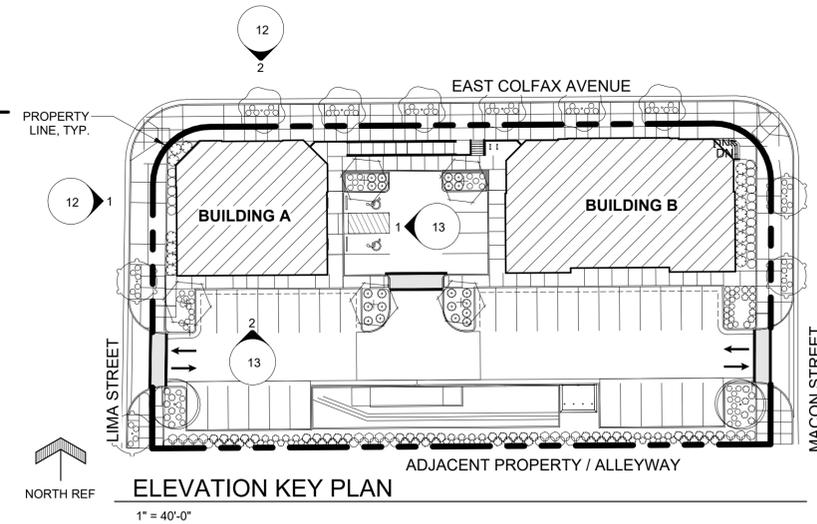


ELEVATION FINISHES

SYMBOL	DESCRIPTION
CMU-1	CMU, RUNNING BOND BASALITE: 720WR
CMU-2	CMU, RUNNING BOND BASALITE: 807WR
CMU-3	CMU, RUNNING BOND, 2" PROTRUDING WATERTABLE SILL BASALITE: 605WR
CMU-4	2" PROTRUDING SINGLE COURSE CMU, RUNNING BOND BASALITE: 807WR (SAME MATERIAL AS CMU-2)
FC-1	CEMENT BOARD PANEL NICHHA: VINTAGEWOOD - ASH
ST-1	STUCCO WITH MOISTURE DRAINAGE. COLOR: BENJAMIN MOORE, OC-130 - CLOUD WHITE
AL-1	ALUMINUM STOREFRONT, TYPICAL

BUILDING ELEVATIONS LEGEND

CG CLEAR GLAZING STOREFRONT ASSEMBLY

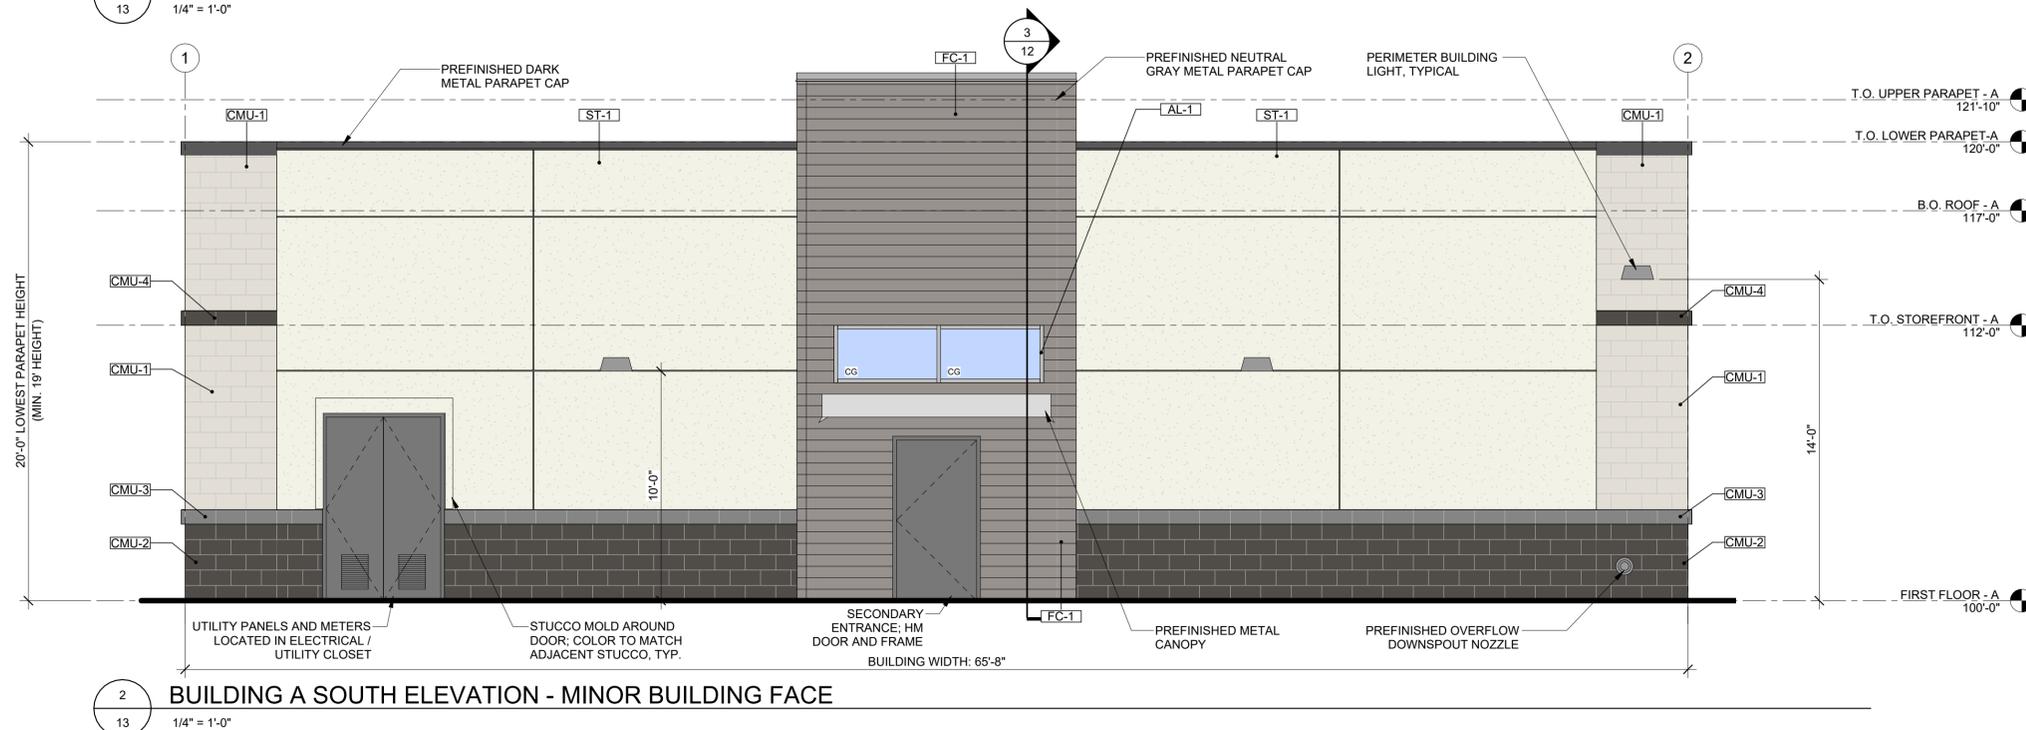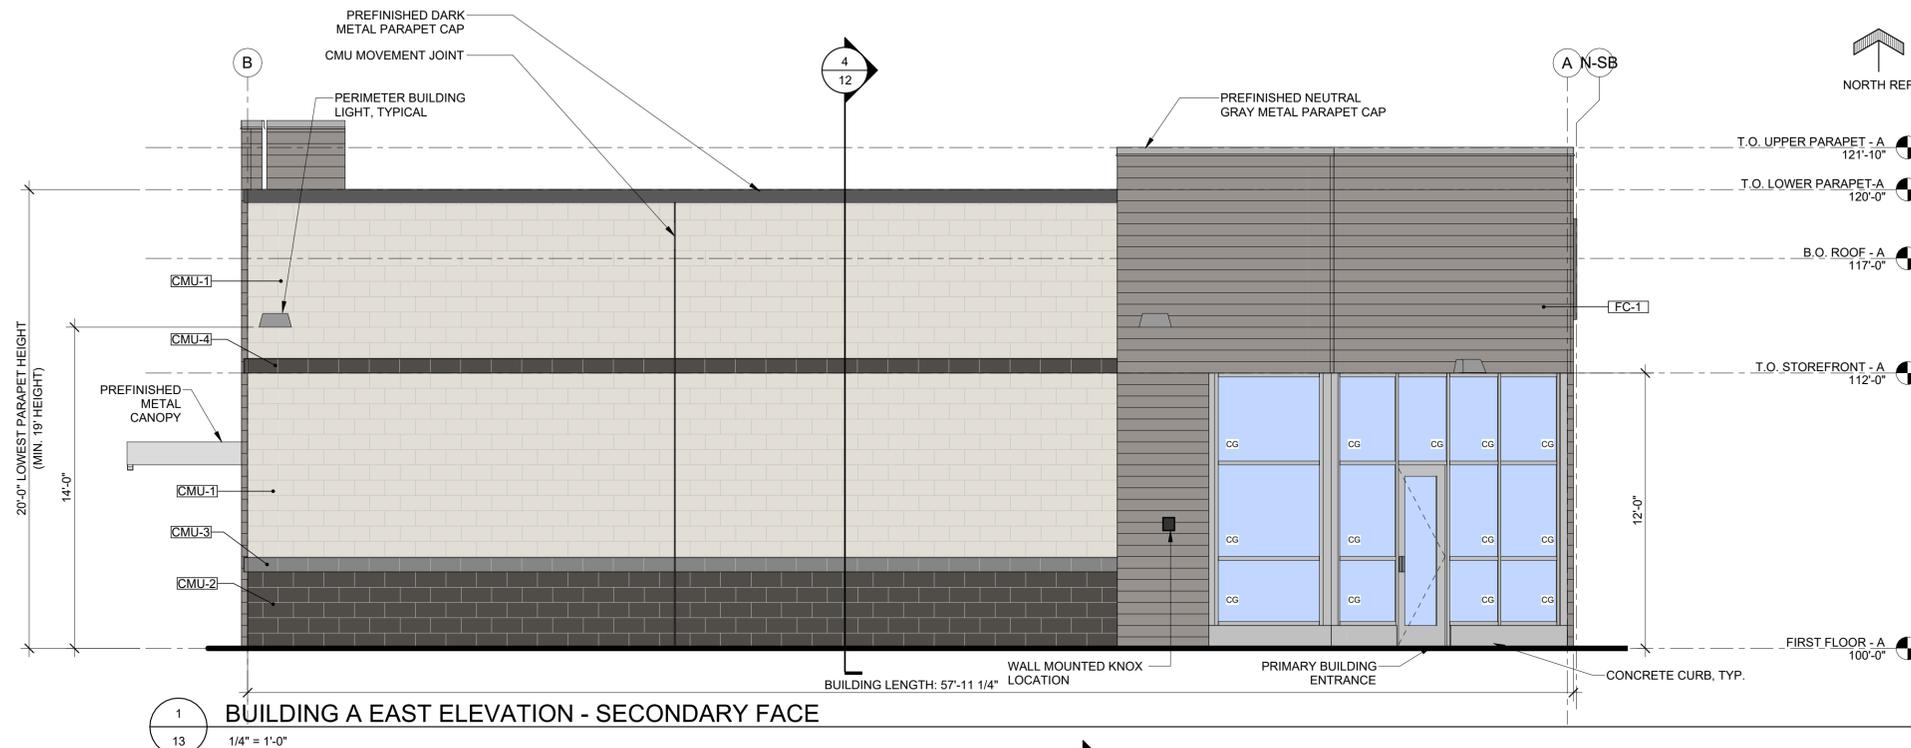

AFC URGENT CARE - SITE PLAN

© 2024 | ALL RIGHTS RESERVED


SITE PLAN

04.26.2024
PROJECT# | AFC, EASTCOLFAX2
DESIGNED BY | DOUGHERTY
DRAWN BY | SCHMALHORST
REVISIONS


NOT FOR CONSTRUCTION

BUILDING A ELEVATIONS

13

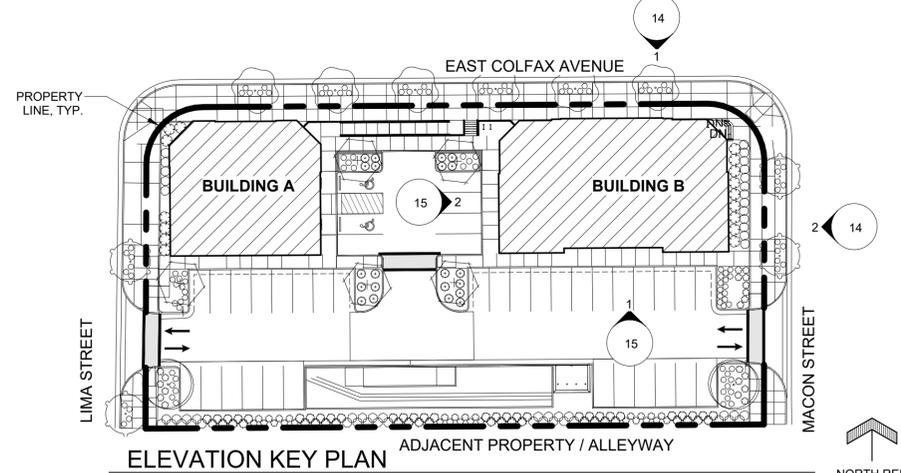

KEY PLAN LEGEND

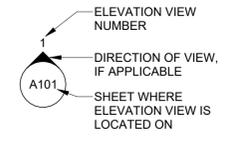


GROUND STORY ACTIVATION (TRANSPARENCY) - BUILDING B		REQUIRED (MIN)	PROVIDED
PRIMARY STREET - COLFAX AVE.			
TOTAL TRANSPARENCY (%)		40%	61%
BUILDING WIDTH	100'-1"		
CLEAR GLAZING	61'-2"		
SIDE STREET - MACON ST.			
TOTAL TRANSPARENCY (%)		N/A	40%
BUILDING LENGTH	57'-8"		
CLEAR GLAZING	23'-3 1/2"		


ELEVATION FINISHES	
SYMBOL	DESCRIPTION
CMU-1	CMU, RUNNING BOND BASALITE: 720WR
CMU-2	CMU, RUNNING BOND BASALITE: 807WR
CMU-3	CMU, RUNNING BOND, 2" PROTRUDING WATERTABLE SILL BASALITE: 605WR
CMU-4	2" PROTRUDING SINGLE COURSE CMU, RUNNING BOND BASALITE: 807WR (SAME MATERIAL AS CMU-2)
FC-1	CEMENT BOARD PANEL NICHHA: VINTAGEWOOD - ASH
ST-1	STUCCO WITH MOISTURE DRAINAGE, COLOR: BENJAMIN MOORE, OC-130 - CLOUD WHITE
AL-1	ALUMINUM STOREFRONT, TYPICAL

BUILDING ELEVATIONS LEGEND


CG CLEAR GLAZING STOREFRONT ASSEMBLY

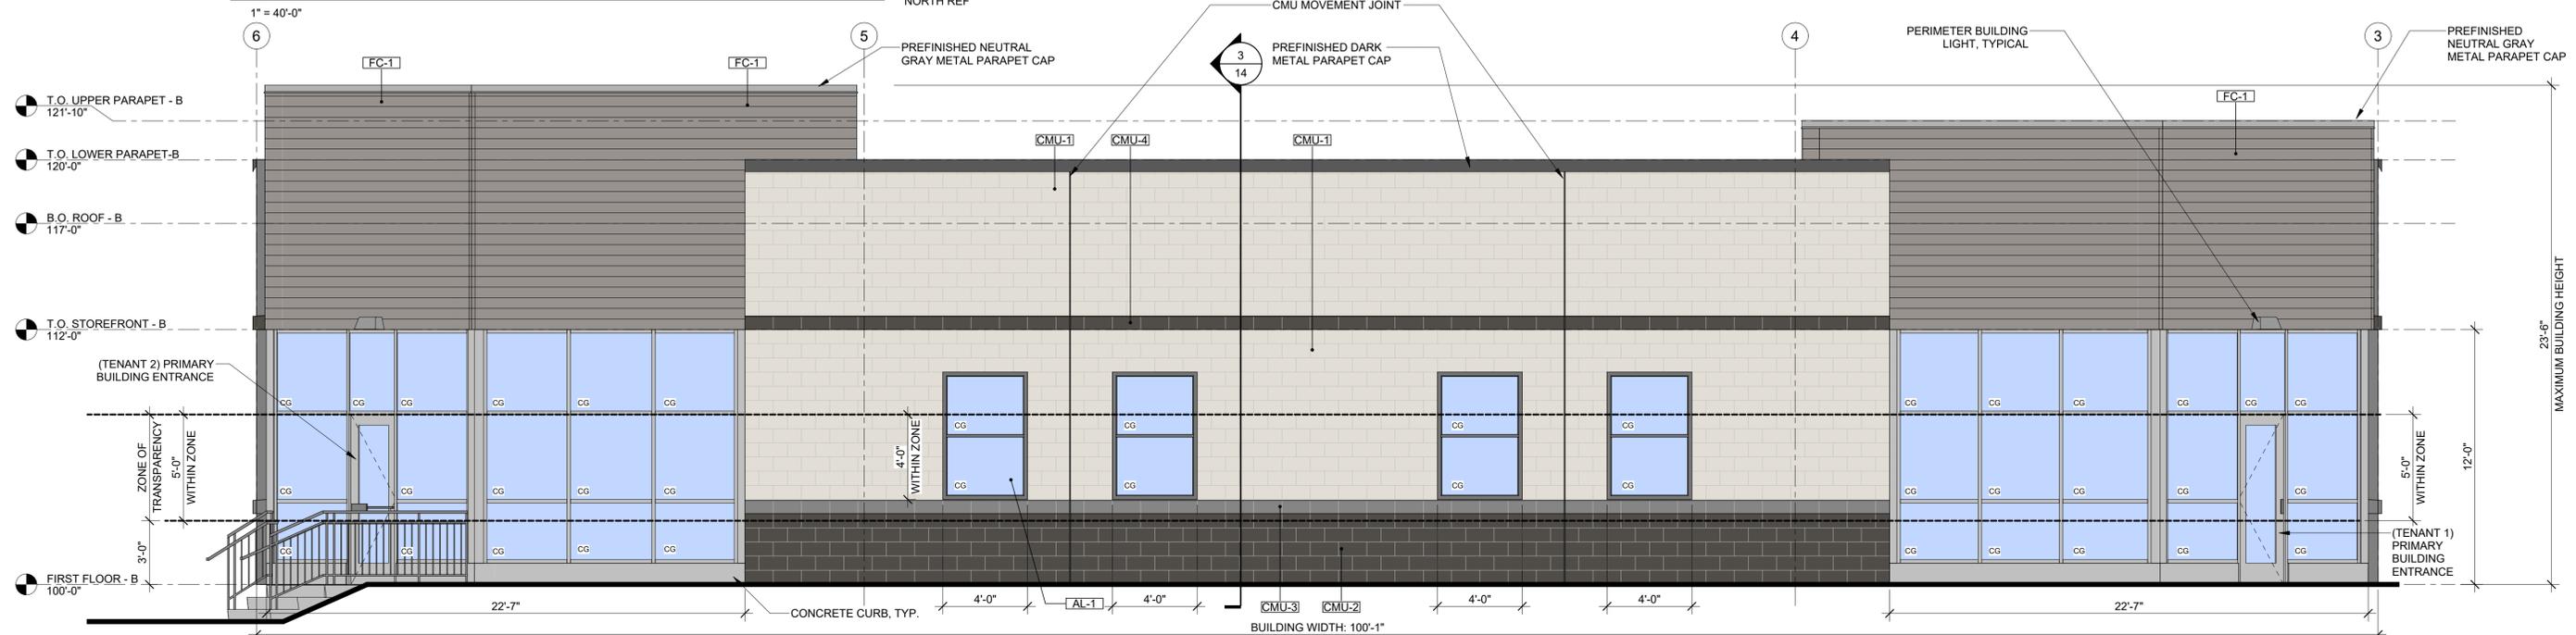


1 BUILDING B NORTH ELEVATION (E. COLFAX AVE.) - PRIMARY BUILDING FACE

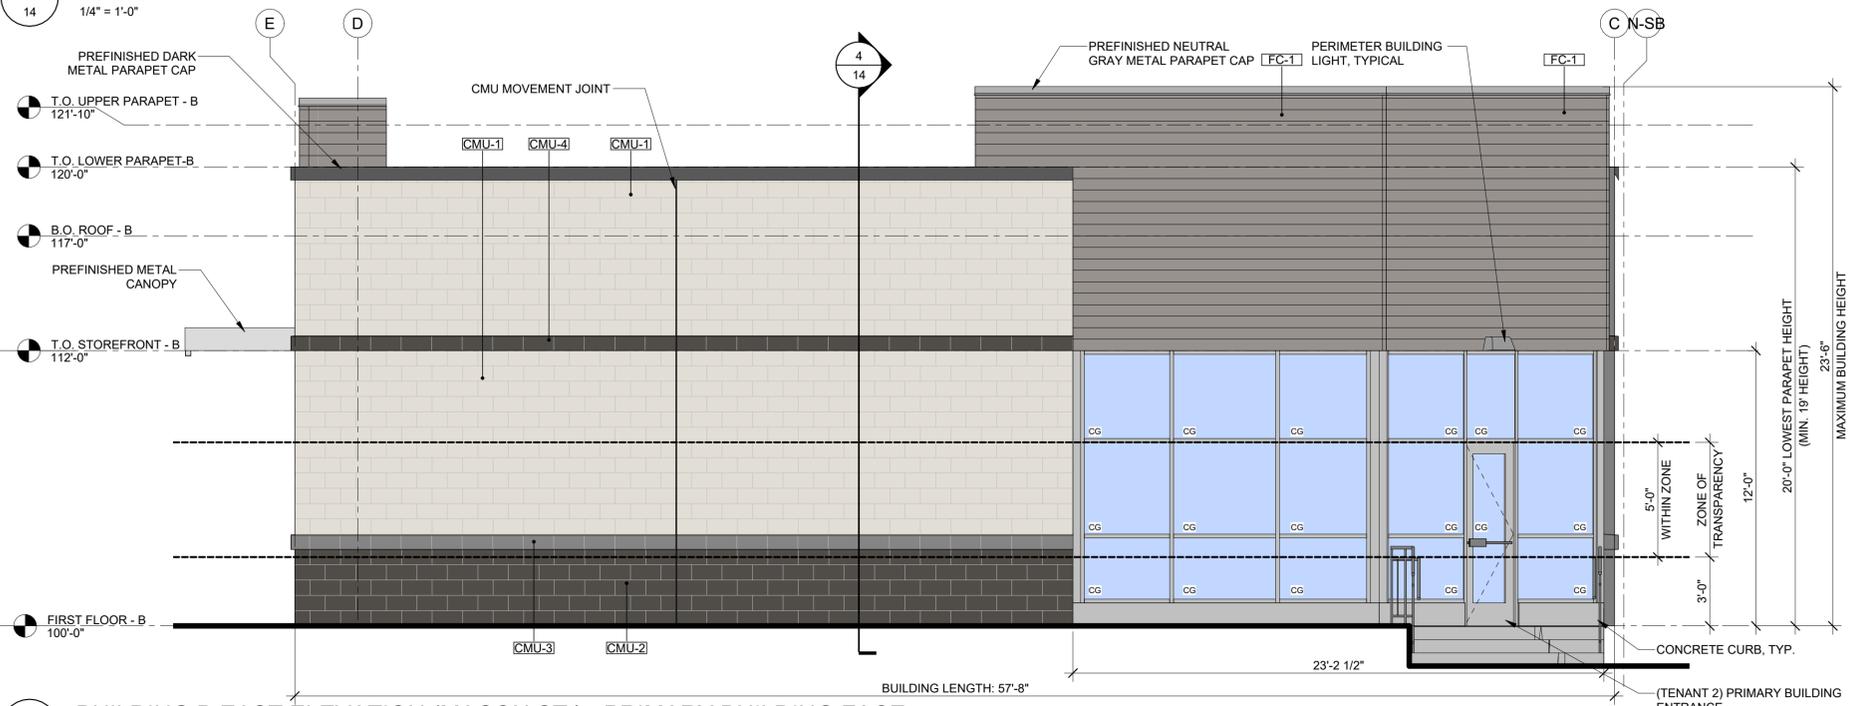

2 BUILDING B EAST ELEVATION (MACON ST.) - PRIMARY BUILDING FACE

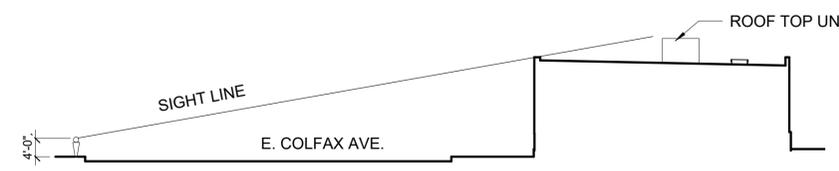

3 BUILDING B - E. COLFAX AVE. RTU VIEW

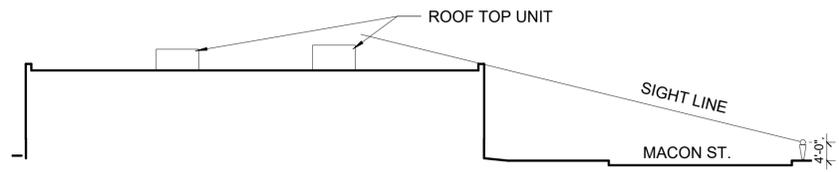

4 BUILDING B - MACON ST. RTU VIEW

AFC URGENT CARE - SITE PLAN

© 2024 | ALL RIGHTS RESERVED

SITE PLAN

04.26.2024
PROJECT# | AFC_EASTCOLFAX2
DESIGNED BY | DOUGHERTY
DRAWN BY | SCHMALHORST
REVISIONS

NOT FOR CONSTRUCTION

BUILDING B ELEVATIONS

ELEVATION FINISHES	
SYMBOL	DESCRIPTION
CMU-1	CMU, RUNNING BOND BASALITE: 720WR
CMU-2	CMU, RUNNING BOND BASALITE: 807WR
CMU-3	CMU, RUNNING BOND, 2" PROTRUDING WATERTABLE SILL BASALITE: 605WR
CMU-4	2" PROTRUDING SINGLE COURSE CMU, RUNNING BOND BASALITE: 807WR (SAME MATERIAL AS CMU-2)
FC-1	CEMENT BOARD PANEL NICHHA: VINTAGEWOOD - ASH
ST-1	STUCCO WITH MOISTURE DRAINAGE, COLOR: BENJAMIN MOORE, OC-130 - CLOUD WHITE
AL-1	ALUMINUM STOREFRONT, TYPICAL

BUILDING ELEVATIONS LEGEND

CG CLEAR GLAZING STOREFRONT ASSEMBLY

FC-1 PREFINISHED NEUTRAL GRAY METAL PARAPET CAP

CMU-1 CMU, RUNNING BOND BASALITE: 720WR

CMU-2 CMU, RUNNING BOND BASALITE: 807WR

CMU-3 CMU, RUNNING BOND, 2" PROTRUDING WATERTABLE SILL BASALITE: 605WR

CMU-4 2" PROTRUDING SINGLE COURSE CMU, RUNNING BOND BASALITE: 807WR (SAME MATERIAL AS CMU-2)

FC-1 CEMENT BOARD PANEL NICHHA: VINTAGEWOOD - ASH

ST-1 STUCCO WITH MOISTURE DRAINAGE, COLOR: BENJAMIN MOORE, OC-130 - CLOUD WHITE

AL-1 ALUMINUM STOREFRONT, TYPICAL

CG CLEAR GLAZING STOREFRONT ASSEMBLY

FC-1 PREFINISHED NEUTRAL GRAY METAL PARAPET CAP

CMU-1 CMU, RUNNING BOND BASALITE: 720WR

CMU-2 CMU, RUNNING BOND BASALITE: 807WR

CMU-3 CMU, RUNNING BOND, 2" PROTRUDING WATERTABLE SILL BASALITE: 605WR

CMU-4 2" PROTRUDING SINGLE COURSE CMU, RUNNING BOND BASALITE: 807WR (SAME MATERIAL AS CMU-2)

FC-1 CEMENT BOARD PANEL NICHHA: VINTAGEWOOD - ASH

ST-1 STUCCO WITH MOISTURE DRAINAGE, COLOR: BENJAMIN MOORE, OC-130 - CLOUD WHITE

AL-1 ALUMINUM STOREFRONT, TYPICAL

CG CLEAR GLAZING STOREFRONT ASSEMBLY

FC-1 PREFINISHED NEUTRAL GRAY METAL PARAPET CAP

CMU-1 CMU, RUNNING BOND BASALITE: 720WR

CMU-2 CMU, RUNNING BOND BASALITE: 807WR

CMU-3 CMU, RUNNING BOND, 2" PROTRUDING WATERTABLE SILL BASALITE: 605WR

CMU-4 2" PROTRUDING SINGLE COURSE CMU, RUNNING BOND BASALITE: 807WR (SAME MATERIAL AS CMU-2)

FC-1 CEMENT BOARD PANEL NICHHA: VINTAGEWOOD - ASH

ST-1 STUCCO WITH MOISTURE DRAINAGE, COLOR: BENJAMIN MOORE, OC-130 - CLOUD WHITE

AL-1 ALUMINUM STOREFRONT, TYPICAL

CG CLEAR GLAZING STOREFRONT ASSEMBLY

FC-1 PREFINISHED NEUTRAL GRAY METAL PARAPET CAP

CMU-1 CMU, RUNNING BOND BASALITE: 720WR

CMU-2 CMU, RUNNING BOND BASALITE: 807WR

CMU-3 CMU, RUNNING BOND, 2" PROTRUDING WATERTABLE SILL BASALITE: 605WR

CMU-4 2" PROTRUDING SINGLE COURSE CMU, RUNNING BOND BASALITE: 807WR (SAME MATERIAL AS CMU-2)

FC-1 CEMENT BOARD PANEL NICHHA: VINTAGEWOOD - ASH

ST-1 STUCCO WITH MOISTURE DRAINAGE, COLOR: BENJAMIN MOORE, OC-130 - CLOUD WHITE

AL-1 ALUMINUM STOREFRONT, TYPICAL

CG CLEAR GLAZING STOREFRONT ASSEMBLY

FC-1 PREFINISHED NEUTRAL GRAY METAL PARAPET CAP

CMU-1 CMU, RUNNING BOND BASALITE: 720WR

CMU-2 CMU, RUNNING BOND BASALITE: 807WR

CMU-3 CMU, RUNNING BOND, 2" PROTRUDING WATERTABLE SILL BASALITE: 605WR

CMU-4 2" PROTRUDING SINGLE COURSE CMU, RUNNING BOND BASALITE: 807WR (SAME MATERIAL AS CMU-2)

FC-1 CEMENT BOARD PANEL NICHHA: VINTAGEWOOD - ASH

ST-1 STUCCO WITH MOISTURE DRAINAGE, COLOR: BENJAMIN MOORE, OC-130 - CLOUD WHITE

AL-1 ALUMINUM STOREFRONT, TYPICAL

CG CLEAR GLAZING STOREFRONT ASSEMBLY

FC-1 PREFINISHED NEUTRAL GRAY METAL PARAPET CAP

CMU-1 CMU, RUNNING BOND BASALITE: 720WR

CMU-2 CMU, RUNNING BOND BASALITE: 807WR

CMU-3 CMU, RUNNING BOND, 2" PROTRUDING WATERTABLE SILL BASALITE: 605WR


CMU-4 2" PROTRUDING SINGLE COURSE CMU, RUNNING BOND BASALITE: 807WR (SAME MATERIAL AS CMU-2)

FC-1 CEMENT BOARD PANEL NICHHA: VINTAGEWOOD - ASH

ST-1 STUCCO WITH MOISTURE DRAINAGE, COLOR: BENJAMIN MOORE, OC-130 - CLOUD WHITE

AL-1 ALUMINUM STOREFRONT, TYPICAL

CG CLEAR GLAZING STOREFRONT ASSEMBLY

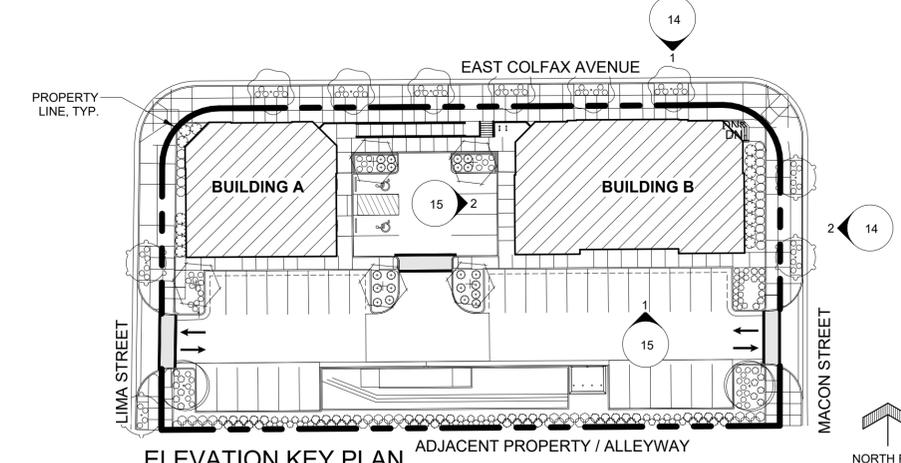

KEY PLAN LEGEND


- ELEVATION VIEW NUMBER
- DIRECTION OF VIEW, IF APPLICABLE
- SHEET WHERE ELEVATION VIEW IS LOCATED ON

ELEVATION KEY PLAN

1" = 40'-0"


NORTH REF

PORTION OF WALL NOTCHED BACK ~2' ~43'-7"

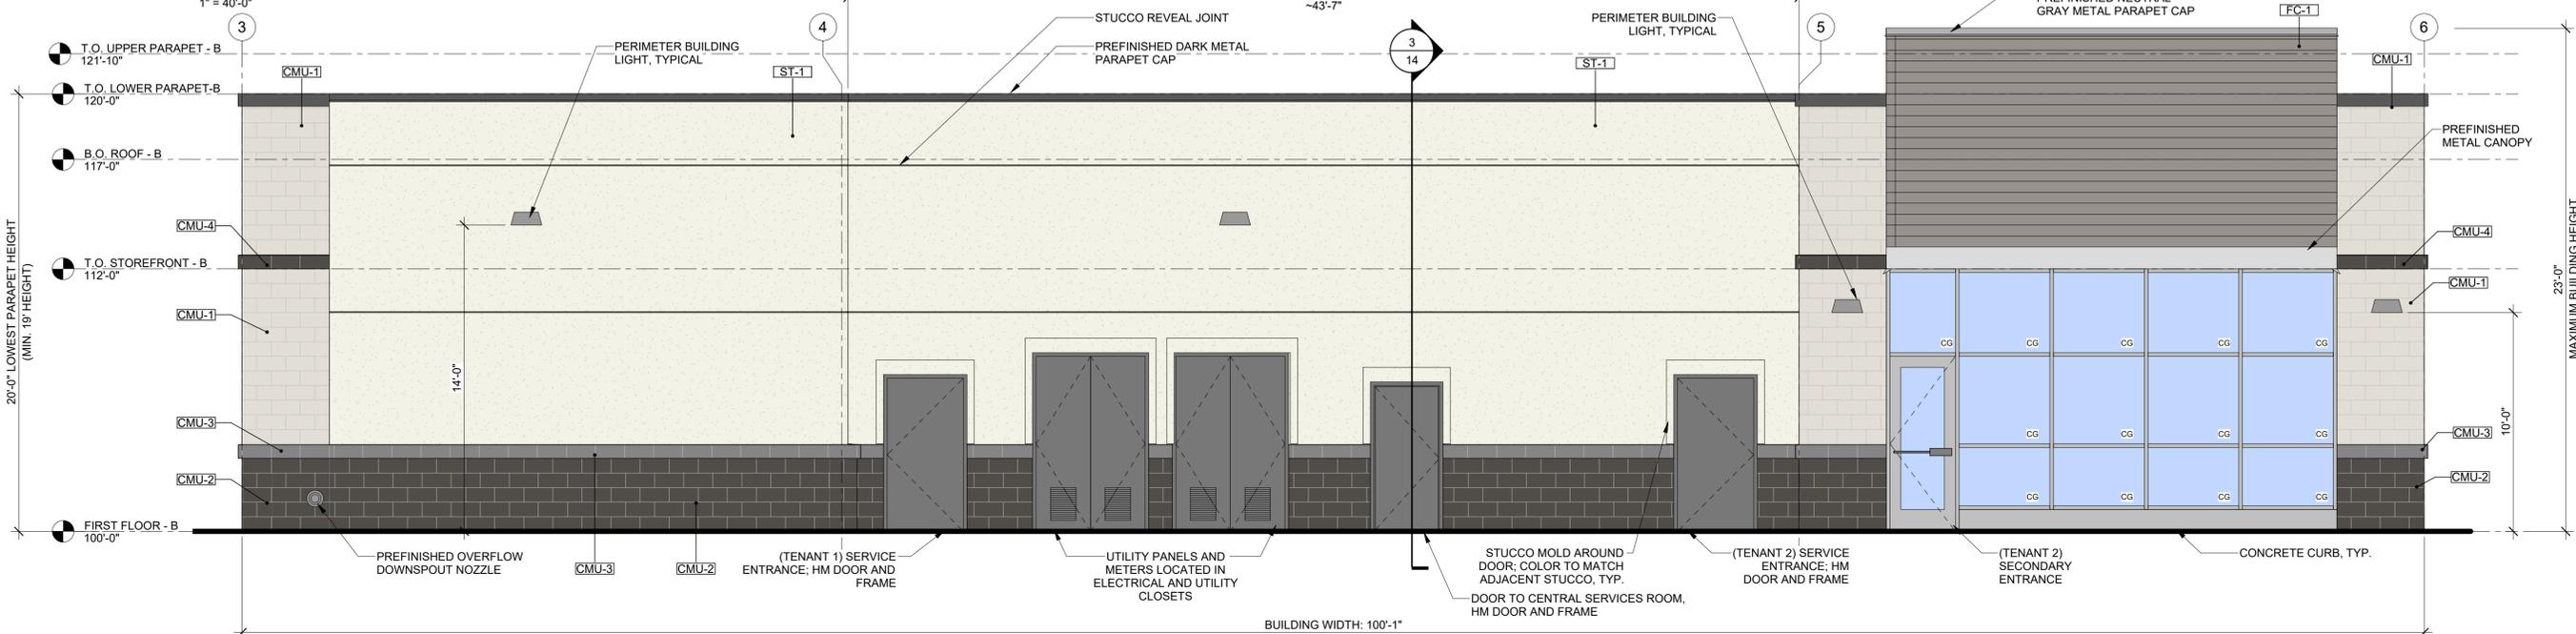

1 BUILDING B SOUTH ELEVATION - SECONDARY BUILDING FACE

1/4" = 1'-0"

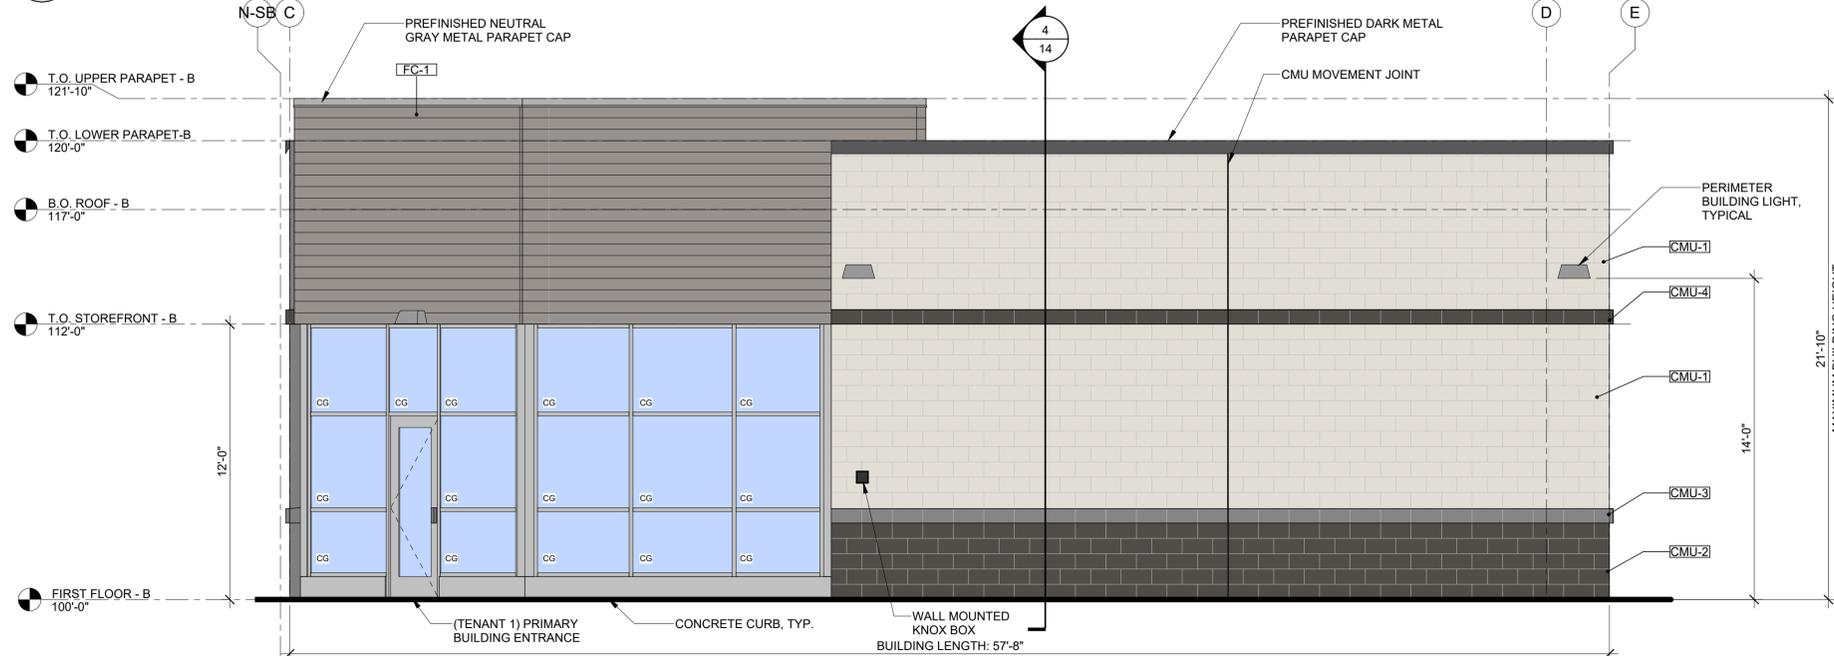

2 BUILDING B WEST ELEVATION - SECONDARY BUILDING FACE

1/4" = 1'-0"

AFC URGENT CARE - SITE PLAN

© 2024 | ALL RIGHTS RESERVED

SITE PLAN

04.26.2024
PROJECT# | AFC_EASTCOLFAX2
DESIGNED BY | DOUGHERTY
DRAWN BY | SCHMALHORST
REVISIONS

BUILDING B ELEVATIONS

15

NOT FOR CONSTRUCTION



CONCRETE MASONRY UNIT (CMU-1)
BASALITE
FINISH: 720WR
TEXTURE: PRECISION
SIZE: 8"(H) X 16"(W)



CONCRETE MASONRY UNIT (CMU-2)
BASALITE
FINISH: 807WR
TEXTURE: PRECISION
SIZE: 8"(H) X 16"(W)




CONCRETE MASONRY UNIT (CMU-3)
BASALITE
FINISH: 605WR
TEXTURE: PRECISION
SIZE: 8"(H) X 16"(W)



CEMENT BOARD PANEL (FC-1)
NICHIIA
SERIES: VINTAGEWOOD
FINISH: ASH



STUCCO (ST-1)
PAINT COLOR: BENJAMIN MOORE
OC-130 CLOUD WHITE
(COLOR PER PALETTE 8 OF ROADSIDE DISTRICT)

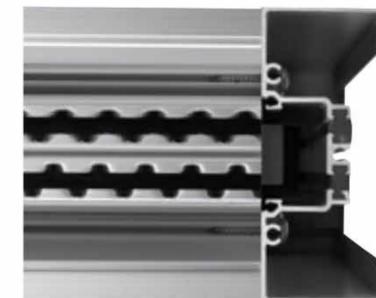

ALUMINUM STOREFRONT (AL-1)
KAWNEER
COLOR: ALUMINUM ANODIZED


ZONE INFORMATION:
COLFAX MAIN ST OVERLAY DISTRICT - ROADSIDE SUBDISTRICT

CHOSEN PALETTE:
PALETTE 8 (ROADSIDE DISTRICT)







NOT FOR CONSTRUCTION

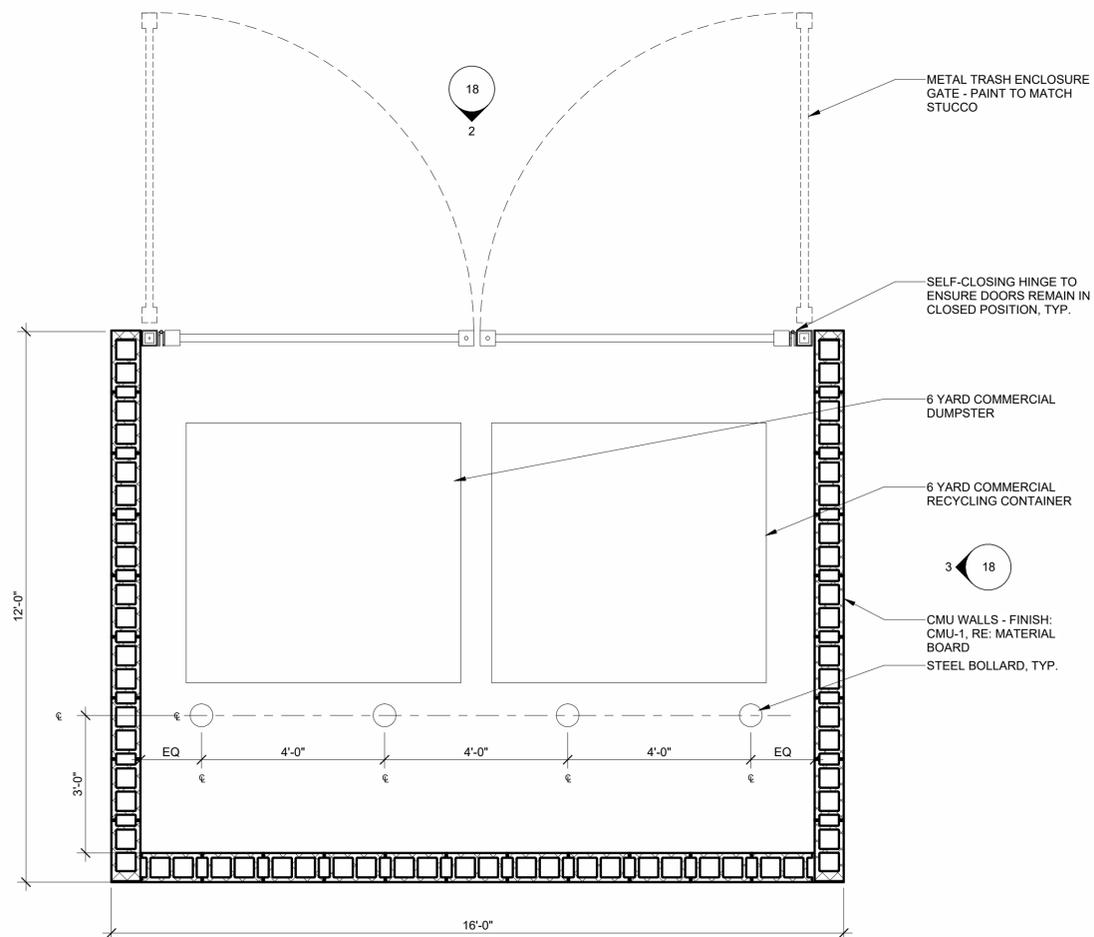


1 TRASH ENCLOSURE PLAN
1/2" = 1'-0"

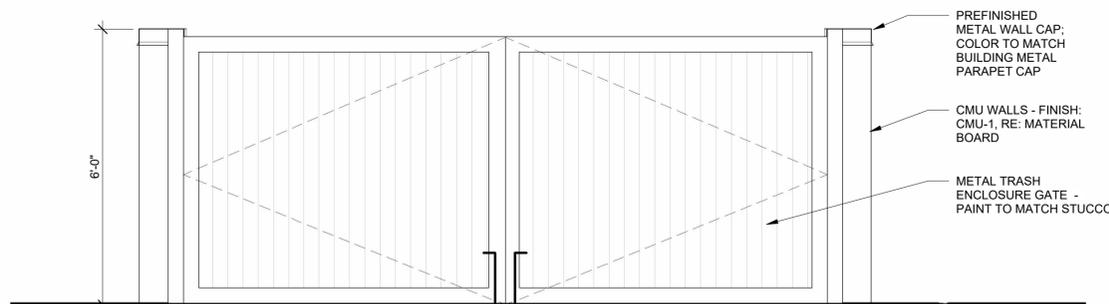

2 TRASH ENCLOSURE ELEVATION - FRONT
1/2" = 1'-0"

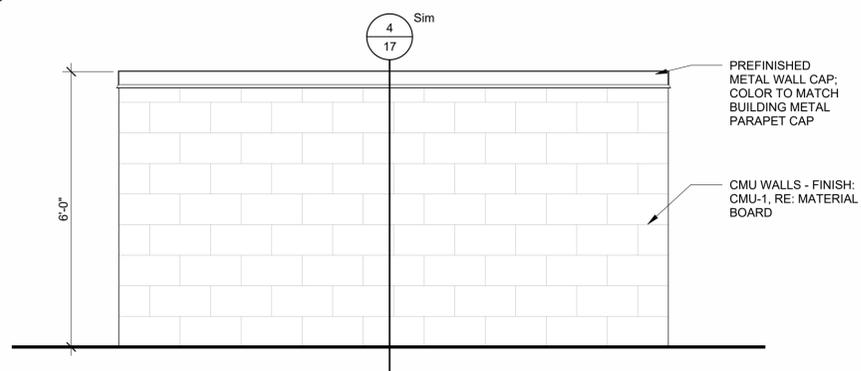

3 TRASH ENCLOSURE ELEVATION - SIDE
1/2" = 1'-0"

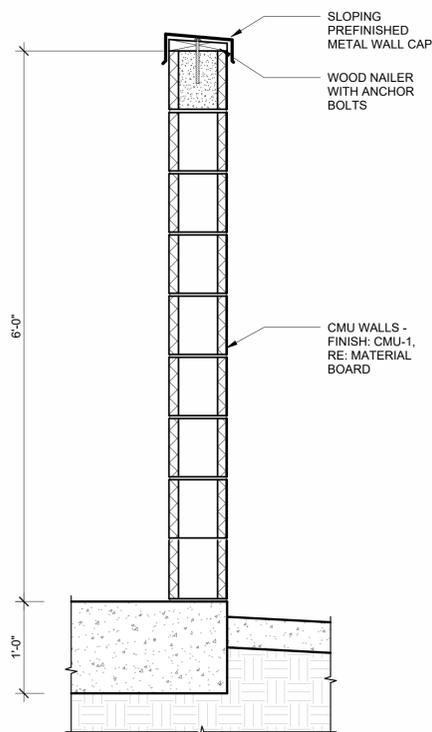

4 TRASH ENCLOSURE WALL DETAIL
1" = 1'-0"