



Aurora Fire Station Fencing

FIRE STATION #6


PROJECT TEAM




ARCHITECTURE:
HB&A, LLC
102 East Moreno Avenue
Colorado Springs, CO 80903
Ph: 719-473-7063
www.hbaa.com




STRUCTURAL:
MGA STRUCTURAL ENGINEERS, INC.
115 S. Weber Street, Suite 101
Colorado Springs, CO 80903
Ph: 719-635-4473
Fax: 719-635-4795



ELECTRICAL & TECHNOLOGY:
BRIDGERS & PAXTON
1365 Garden of the Gods Rd., Suite 260
Colorado Springs, CO 80907
Ph: 719-630-3350
www.bpce.com



CIVIL:
DREXEL, BARRELL & CO.
1376 Miners Drive, Suite 107
Lafayette, CO 80026
Ph: 303-442-4338



LANDSCAPE:
DHM DESIGN
900 S. Broadway, Suite 300
Denver, CO 80209
Ph: 303-892-5566
www.dhmdesign.com

BUILDING CODES & SCOPE OF WORK

APPLICABLE CODES & REGULATIONS:
2021 International Building Code (IBC)
2021 International Existing Building Code (IEBC)
2021 International Fire Code (IFC)
2021 International Energy Conservation Code (IECC)
2021 International Mechanical Code (IMC)
2021 International Fuel Gas Code (IFGC)
2021 International Plumbing Code (IPC)
2023 National Electrical Code (NEC)
2017 ICC/ANSI A117.1 Accessibility Standard
City of Aurora Amendments

SCOPE OF WORK
Construct new 6 ft. high metal security fence, automatic vehicular gates, and pedestrian gates at locations indicated in the plans. New vehicular access gates shall be either cantilevered sliding gate, or vertical pivot gate, as indicated. Install automatic gate operators with all accessories and appertenances as required to meet applicable safety regulations and fire department requirements. Provide Knox key fire department access to all new vehicular and pedestrian gates.

Perform selective demolition and repair of landscaping, concrete, and asphalt as needed to install new fencing and gates, and as shown in the plans. Install new bollards and pedestals, pavement markings, and signage where indicated

Make all connections to existing electrical and low-volt services as required for a fully functional system. Install access controls for vehicular and pedestrian gates and connect to existing access control system.

Patch and repair existing building surfaces at all new penetrations through walls, floors, or ceilings. Seal all penetrations through exterior walls to maintain integrity of building envelope. Conceal new conduits as much as possible. Where new conduit and junction boxes are left exposed, paint to match adjacent surfaces.

2021 IBC, Section 3110.1 - *Automatic vehicular gates* shall comply with the requirements of Sections 3110.2 and 3110.3 and other applicable sections of this code.
3110.2 Vehicular gates intended for automation shall be designed, constructed and installed to comply with the requirements of ASTM F2200.
3110.3 Vehicular gate openers, where provided, shall be *listed* in accordance with UL 325.

INDEX TO DRAWINGS

FS06	COVER SHEET
C1	SITE PLAN
L1	LANDSCAPE PLAN
L2	LANDSCAPE PLAN
SD-1	SITE DETAILS
SD-2	SITE DETAILS
S-F	FENCING FOUNDATION PLAN
E-001	ELECTRICAL LEGEND
ES101	ELECTRICAL SITE PLAN
E-601	ELECTRICAL DIAGRAMS

BUILDING INFORMATION

BUILDING OCCUPANCY TYPES:
Group S-1 (Motor Vehicle Repair Garage)
Group R-2 (Congregate Living Facility with more than 16 occupants)
Group B (Assembly spaces with an area less than 750 SF)

BUILDING HEIGHT AND AREA:
Overall Building Area = 6860 SF
Building Height = One Story, 21 FT.

Building Construction Type: V-B

BUILDING OCCUPANT LOAD:
Total Occupant Load = 34
(Group S-1 = 13)
(Group R-2 = 21)
(Group B = N/A)

PARKING SPACES PROVIDED
Existing = 22
Proposed = 21
Required= 9 (34 O.L. / 1 space per 4 persons)

GENERAL NOTES

- DO NOT SCALE DRAWINGS.
- PROSPECTIVE BIDDERS MUST EXAMINE THE CONTRACT DOCUMENTS (DRAWINGS AND SPECIFICATIONS) CAREFULLY AND, BEFORE BIDDING, MUST REQUEST CLARIFICATION FROM THE ARCHITECT IN WRITING AT LEAST 14 DAYS PRIOR TO THE TIME SET FOR OPENING THE BIDS. AN INTERPRETATION OR CORRECTION OF EVERY PATENT AMBIGUITY, INCONSISTENCY, OR ERROR THEREIN. SUCH INTERPRETATION OR CORRECTION, AS WELL AS ANY ADDITIONAL CONTRACT PROVISIONS THE ARCHITECT MAY DECIDE TO INCLUDE, WILL BE ISSUED IN WRITING BY THE ARCHITECT AS AN ADDENDUM TO THE CONTRACT, WHICH WILL BE MAILED OR DELIVERED TO EACH PERSON RECORDED AS HAVING RECEIVED A COPY OF THE CONTRACT DOCUMENTS FROM THE ARCHITECT, AND WHICH WILL ALSO BE POSTED AT THE PLACE WHERE THE CONTRACT DOCUMENTS ARE AVAILABLE FOR INSPECTION OF PROSPECTIVE BIDDERS. UPON SUCH MAILING OR DELIVERY AND POSTING, SUCH ADDENDUM SHALL BECOME A PART OF THE CONTRACT DOCUMENTS, AND BINDING ON ALL BIDDERS. WHERE CLARIFICATIONS ARE NOT MADE PRIOR TO BIDDING THE CONTRACTOR SHALL PROVIDE THE BETTER QUALITY OR GREATER QUANTITY OF WORK WITH NO COST TO THE OWNER.
- DIMENSIONS SHOWN ARE TO FACE OF FOUNDATION WALL, FACE OF MASONRY, FACE OF STUD UNLESS OTHERWISE INDICATED. ALL DIMENSIONS MUST BE VERIFIED TO CONFORM TO EXISTING CONDITIONS.
- ALL BLOCK IS 8" NOMINAL WIDE UNLESS OTHERWISE NOTED BY DIMENSION OR PARTITION TYPES. MASONRY AND STUD WALL DIMENSIONS ARE NOMINAL.
- ALL ANGLES ARE 90 DEGREES OR 45 DEGREES UNLESS OTHERWISE NOTED.
- SITE PLAN DIMENSIONS ARE TO FACE OF CURB UNLESS OTHERWISE NOTED.
- ALL SPOT ELEVATIONS OUTSIDE OF THE BUILDING RELATE TO SURVEY DATUM AT THE BENCHMARK. ALL SPOT ELEVATIONS INSIDE THE BUILDING REFER TO REFERENCE ELEVATION.
- NOTIFY ARCHITECT IMMEDIATELY SHOULD CONDITIONS BE FOUND CONTRADICTIONARY TO THESE DRAWINGS.
- PROVIDE BULLNOSE C.M.U. WHERE INDICATED ON DRAWINGS AND/OR AT ALL 90 DEGREE OUTSIDE CORNERS WITHIN THE PROJECT.
- ALL WORK TO BE BASED ON 2021 IBC AND LOCAL CODE REQUIREMENTS.
- CONTRACTOR SHALL HAVE ONE STAMPED PERMIT SET OF DRAWINGS AND SPECIFICATIONS ON SITE AT ALL TIMES.
- WATER RESISTANT (GREEN) GYP. BD. SHALL BE USED IN ALL WET OR EXTERIOR AREAS
- ALL REFERENCES TO SPECIFIC MANUFACTURERS ARE FOR REFERENCE ONLY AND CAN BE SUBSTITUTED BY AN APPROVED EQUAL. SUBMIT REQUESTS FOR SUBSTITUTIONS TO ARCHITECT.
- G.C. TO PROVIDE A FULLY INSULATED BLDG. ENVELOPE.
- THE CONTRACT DOCUMENTS INCLUDE THE PROJECT MANUAL AND SPECIFICATIONS AS ONE COMPLETE PACKAGE. IF THE CONTRACTOR CHOOSES TO SPLIT APART THE DRAWINGS OR SPECIFICATIONS DURING BIDDING TO PROCURE BIDS FROM SUBS HE SHALL BE RESPONSIBLE FOR COORDINATION WITH OTHER WORK SHOWN ON OTHER DRAWING SHEETS OR SPECIFICATION SECTIONS. IN NO WAY SHALL THIS RELIEVE THE SUB OR GENERAL CONTRACTOR FROM HIS RESPONSIBILITY TO PROVIDE ITEMS DESIGNATED ELSEWHERE."
- IN ALL OCCURRENCES OF PLANAR ALIGNMENTS (I.E. WALL TO SOFFIT, WALL TO MILLWORK, ETC.) UNLESS OTHERWISE SHOWN OR NOTED, PROVIDE A MINIMUM OF A 3" OFFSET. CLARIFY ANY AMBIGUITIES WITH ARCHITECT.
- PATCH, REPAIR, AND REFINISH EXISTING ITEMS TO REMAIN, TO THE SPECIFIED CONDITIONS FOR EACH MATERIAL, WITH A WORKMANLIKE TRANSITION TO ADJACENT NEW ITEMS OF CONSTRUCTION. WHERE NEW WORK ABUTS OR FINISHES FLUSH WITH EXISTING FINISH SURFACES WITH THE INTENT TO MATCH, REFINISH THE ENTIRE SURFACES AS NECESSARY TO PROVIDE AN EVEN FINISH.

ARCHITECTURAL ABBREVIATIONS

AB	ANCHOR BOLTS	EA	EAST	LAV	LAVATORY	R&R	REMOVE AND REPLACE
ABV	ABOVE	ED	EACH	LD BRG	LOAD BEARING	RD	ROOF DRAIN
AC	ACOUSTICAL	EL	ELECTRICAL CONTRACTOR	LMC	LIBRARY MEDIA CENTER	RDL	ROOF DRAIN LEADER
AD	ADDITION	EM	EXHAUST FAN	LOUV	LOUVER	RM	ROOM
ADD	ADJUSTABLE/ADJACENT	ENC	EXPANSION JOINT	LT	LIGHT	RO	ROUGH OPENING
ADJ	ADJUSTABLE/ADJACENT	ENG	ELECTRIC	MANUF/MANF	MANUFACTURER	RE	REFER. REFERENCE
AFF	ALTERNATIVE, ALTERNATE	EMER	ELEVATION/ELEVATOR	MAS	MASONRY	RS	RISERS
ALT	ALTERNATIVE, ALTERNATE	ELEV	ENCLOSURE	MAT'L	MATERIAL	SAG	SUSPENDED ACOUSTICAL GRID
ALUM/AL	ALUMINUM	ENCL	ENGINEER/ENGINEERING	MAX	MAXIMUM	SAG	SUSPENDED ACOUSTICAL TILE
AP	ACCESS PANEL	ENG	ELECTRIC PANEL	MC	MECHANICAL CONTRACTOR	SALV	SALVAGE
AP	ANGLE	EQ	EQUAL	MECH	MECHANICAL	SCH	SCHEDULES
APPROX	APPROXIMATE	ETC/ETC	ELECTRIC WATER COOLER	MIL / MM	MILL / MILLIMETER	SEPAR	SEPARATE
ARCH	ARCHITECTURAL/ARCHITECT	ETC/ETC	ELECTRIC WATER COOLER	MIN	MINIMUM	SHT	SHEET
AUTO	AUTOMATIC	EW	EACH WAY	MINUS	MINUS	SIM	SIMILAR
A.V.	AUDIO VIDEO	EX	EXISTING	NO	NUMBER	SQ	SPECIFICATIONS/SPECIFIED/
		EX. EXIST	EXISTING	MISC	MISCELLANEOUS	SQ FT/SF	SQUARE
		EXT	EXTERIOR	MT	MOUNTING / MOUNTING	SQ IN	SQUARE INCH
				MT/MNT	MOUNTING / MOUNTING	SQ YD	SQUARE YARD
				MTL/MT	MOUNTING / MOUNTING	SS	STAINLESS STEEL
BD	BOARD	FB	FIBERGLASS	NIC	NOT IN CONTRACT	STD	STANDARD
BLK	BLOCK	FD	FLOOR DRAIN	NO	NUMBER	STL	STEEL
BLKG	BLOCKING	FEC	FIRE EXTINGUISHER CABINET	NTS	NOT TO SCALE	STOR	STORAGE
BLDG	BUILDING	FF	FINISH FLOOR			STRUC	STRUCTURAL
BM	BEAM	FIN	FINISH			ST	STRAIGHT
B.M.	BENCH MARK	FLASH	FLASHING			TELE	TELEPHONE
BR	BACKER ROD	FLR	FLOOR			TB	TACK BOARD
BRG	BEARING	FLU	FLUORESCENT			THK	THICK
		F.M.	FLOOR MAT			T&B	TOP AND BOTTOM
CABT	CABINET	F.O.M.	FACE OF MASONRY			T&G	TONGUE & GROOVE
CB	CEMENT	FRP	FIBER-REINFORCED PLASTIC			TOILET	TOILET
CEM PLAS	CEMENT PLASTER	F.R.	FIRE RESISTANT			T/L / TOIL	TOP OF
CI	CAST IRON	FS	FLOOR SINK			T.O.	TOP OF MASONRY
CJ	CAST IN PLACE	FT	FEET/FOOT			TS	TURE STEEL
C	CENTER LINE	FTG	FOOTING			Ts	TREADS
CL	CLOSE	FUR	FURRING			TOW	TOP OF WALL
CLG	CEILING	F.V.	FIELD VERIFY			TRANSF	TRANSFORMER
CLR	CLEAR	GALV	GALVANIZED			TYP	TYPICAL
CMU	CONCRETE MASONRY UNIT	GL	GALVANIZED IRON/STEEL			URC	UNIFORM BUILDING CODE
COL	COLUMN	GA	GAUGE/GAGE			UNF	UNFINISHED
COMP	COMPOSITE	GYP BD	GYP/BOARD			UNO	UNLESS NOTED OTHERWISE
CONF	CONFERENCE	HC	HANDICAPPED				
CONSTR	CONSTRUCTION	HDWE	HARDWARE				
CONTR	CONTRACTOR	HR	HOUR				
CORR	CORRIDOR	HT	HEIGHT				
CORR	CORRIDOR	HT	HEIGHT				
CP	CENTER POINT	HDR	HOLLOW METAL				
CR	CLASSROOM	HORIZ	HORIZONTAL				
CTSK	COUNTERSINK	INCL	INCLUSIVE				
		ID	INSIDE DIAMETER				
		INST	INSTRUMENT				
		INSUL	INSULATION				
		INT	INTERIOR				
		JAN	JANITOR				
		JST	JOINT				
		KO	KNOCK OUT				
DBL	DOUBLE						
DEMO	DEMOLITION						
DEG	DEGREE						
DET/OTL	DETAIL						
DF	DRINKING FOUNTAIN						
DIA	DIAMETER						
DIAG	DIAGONAL						
DIM	DIMENSION						
CONTR	CONTRACTOR						
DO	DOOR OPENING						
DN	DOWN						
DS	DOWNSPOUT						
DWG	DRAWING						

18. THE DEVELOPER, HIS OR HER SUCCESSORS, AND ASSIGNS SHALL BE RESPONSIBLE FOR INSTALLATION, MAINTENANCE, AND REPLACEMENT OF THE ACCESS CONTROL GATE OR BARRIER SYSTEM TO ENSURE EMERGENCY VEHICLE ACCESS TO WITHIN THE SITE. IF THE ABOVE CONDITIONS ARE NOT MET, THE OWNERS, HIS OR HER SUCCESSORS, AND ASSIGNS, SHALL BE REQUIRED BY FIRE DEPARTMENT ORDER NOTICE THAT ALL AFFECTED GATES WILL BE CHAINED AND LOCKED IN THE OPEN POSITION UNTIL REPAIRED OR REPLACED, AND RETESTED. IF THE GATING SYSTEM IS NOT MAINTAINED TO THE SATISFACTION OF THE FIRE DEPARTMENT, THE LICENSE AGREEMENT FOR THE EMERGENCY VEHICLE GATE OPENING SYSTEM WILL BE REVOKED AND THE GATING SYSTEM MUST BE REMOVED. THE GATING SYSTEM WILL INCLUDE AN EMERGENCY VEHICLE GATE OPENING SYSTEM UTILIZING A REDUNDANCY BACK-UP SYSTEM THAT CONSISTS OF: A) SIREN OPERATED SYSTEM; B) AUTOMATIC KNOX KEY SWITCH; AND C) MANUAL OVERRIDE (IN THE EVENT OF SYSTEM FAILURE). GATING SYSTEMS WILL BE INSTALLED IN ACCORDANCE WITH THE "GATING SYSTEMS CROSSING FIRE APPARATUS ACCESS ROADS CHECKLIST". A SEPARATE BUILDING PERMIT THROUGH THE BUILDING DIVISION IS REQUIRED TO BE OBTAINED BY THE CONTRACTOR PRIOR TO THE INSTALLATION OF ANY GATING/BARRIER SYSTEM THAT CROSSES A DEDICATED FIRE LANE EASEMENT.

19. A LICENSED CONTRACTOR IS REQUIRED TO OBTAIN A VALID BUILDING PERMIT THROUGH THE AURORA BUILDING DIVISION PRIOR TO THE INSTALLATION OF ANY GATING SYSTEM UTILIZED BY EMERGENCY RESPONDERS TO ENTER THE SITE. CALL 303-739-7420 TO BEGIN THE PLAN REVIEW, PERMITTING AND INSPECTION PROCESSES.

1. The applicant has the obligation to comply with all applicable requirements of the American with Disabilities Act.

2. The approval of this document does not constitute final approval of grading, drainage, utility, public improvements and building plans. Construction plans must be reviewed and approved by the appropriate agency prior to the issuance of building permits.

3. Errors in approved Site Plans resulting from computations or inconsistencies in the drawings made by the applicant are the responsibility of the property owner of record. Where found, the current minimum Code requirements will apply at the time of building permit. Please be sure that all plan computations are correct.

CITY OF AURORA - COORDINATION SIGNATURES

PUBLIC WORKS-FACILITIES / SIGNATURE	TITLE	DATE
DEPARTMENT / SIGNATURE	TITLE	DATE

BLDG #1312

FIRE STATION #6



Aurora Fire Rescue
15588 E. Hampden Cir.
Aurora, Colorado 80013

PROJ. NO. R-2287

DRAWN: CR

CHECKED: TL

CADD FILE:

DATE: 02/22/2024

NO.	DATE	DESCRIPTION
11/08/23		Construction Documents
01/12/24		Bid Documents
02/22/24		Building Permit Set

FIRE STATION #6
AURORA FIRE RESCUE
CONSTRUCTION DRAWING SET

SHEET TITLE:


COVER SHEET

SCALE: As indicated

SHEET NUMBER:

FS06

PROJECT BENCHMARK:
CITY OF AURORA BENCHMARK ID NO. S-040
PUBLISHED ELEVATION = 5685.81
(BASED ON NAVD, 88 DATUM)

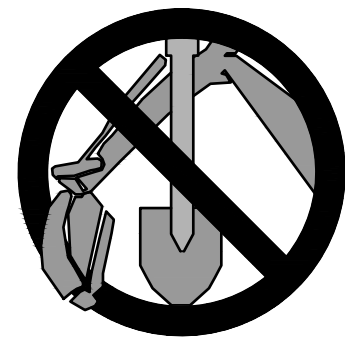

CALL UTILITY NOTIFICATION
CENTER OF COLORADO
811
CALL 3-BUSINESS DAYS IN ADVANCE
BEFORE YOU DIG, GRADE, OR EXCAVATE
FOR THE MARKING OF UNDERGROUND
MEMBER UTILITIES.

10 5 0 10 20
ORIGINAL SCALE: 1"=10'

LEGEND


- PROPERTY LINE.....
EX. FENCE.....
EX. FIRE HYDRANT.....
EX. WATER VALVE.....
EX. SIGN.....
EX. TREE.....
EX. WATER METER.....
EX. MANHOLE.....
EX. CABLE TV LINE.....
EX. GAS LINE.....
EX. WATER LINE.....
EX. BURIED ELECTRIC LINE.....
EX. POWER POLE.....
EX. STREET LIGHT.....
EX. LANDSCAPE.....
EX. CONCRETE.....
EX. GRAVEL.....
EX. INTERMEDIATE CONTOUR.....
EX. INDEX CONTOUR.....
PROPOSED FENCE.....
EX. SPOT ELEVATIONS.....
TOP OF CONCRETE PAD.....
PROPOSED SPOT ELEVATION.....
NOTE:
1. ADD 5600 TO ALL SPOT ELEVATIONS

CONSTRUCTION NOTES


1. INSTALL 6-INCH DIA. STEEL BOLLARD. (REFER TO LANDSCAPE PLANS FOR DETAIL.)
2. INSTALL TWO-TIERED KEY PAD/CARD READER. (REFER TO ELECTRICAL PLANS FOR DETAIL.)
3. INSTALL 6-FOOT HIGH METAL SECURITY FENCE. (REFER TO LANDSCAPE PLANS FOR DETAIL.)
4. INSTALL RIGHT-HAND VERTICAL PIVOT GATE OPERATOR & 4'x7' CONCRETE PAD. (REFER TO ELECTRICAL & STRUCTURAL PLANS FOR DETAILS.)
5. SAW CUT ASPHALT, INSTALL UNDERGROUND REVERSING LOOP (STANDARD SIZE 6'x10') & ADD SEALANT. REFER TO MANUFACTURER'S SPECIFICATIONS.
6. SAW CUT ASPHALT, INSTALL UNDERGROUND FREE EXIT LOOP (STANDARD SIZE 6'x10') & ADD SEALANT. REFER TO MANUFACTURER'S SPECIFICATIONS.
7. SAWCUT ASPHALT, INSTALL LOOP HOMERUNS, & ADD SEALANT. REFER TO MANUFACTURER'S SPECIFICATIONS.
8. INSTALL 4-FOOT WIDE PEDESTRIAN SECURITY GATE W/PANIC BAR. (REFER TO LANDSCAPE PLANS FOR DETAIL.)
9. INSTALL KEY PAD/CARD READER. (REFER TO ELECTRICAL PLANS FOR DETAIL.)
10. CONSTRUCT 13"x18" CONCRETE YOKE PAD. (REFER TO STRUCTURAL PLANS FOR DETAIL.)
11. REMOVE EX. CONCRETE PAVEMENT AND SIDEWALK, CURB & GUTTER AS NECESSARY (TO NEAREST JOINT OR SAWCUT TO MINIMIZE AREA) TO FACILITATE PROPOSED CONSTRUCTION. RECONSTRUCT TO MATCH EXISTING GRADES & MATERIAL TYPE/THICKNESS/SIZE.

HB&A
Architecture
& Planning

102 E. Moreno Avenue
Colorado Springs, CO 80903
719.473.7063
www.hbaa.com

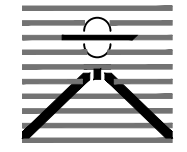

DREXEL, BARRELL & CO.
Engineers & Surveyors
1376 MINERS DRIVE, SUITE 107
LAFAYETTE, COLORADO 80026
(303) 442-4338
LAFAYETTE
COLORADO SPRINGS

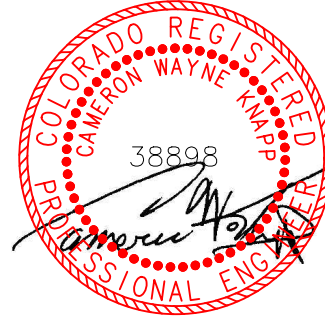

BLDG #1312

FIRE STATION #6

Aurora Fire Rescue
15588 E. Hampden Circle
Aurora, Colorado 80013

PROJ. NO. R-2287

DRAWN: MTO

CHECKED: CWK

CADD FILE:

DATE: 02/22/2024

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02/22/24		Building Permit Set


FIRE STATION #6
AURORA FIRE RESCUE
CONSTRUCTION DRAWING SET

SHEET TITLE:
SITE PLAN

SCALE: 1"=10'

SHEET NUMBER:

C1



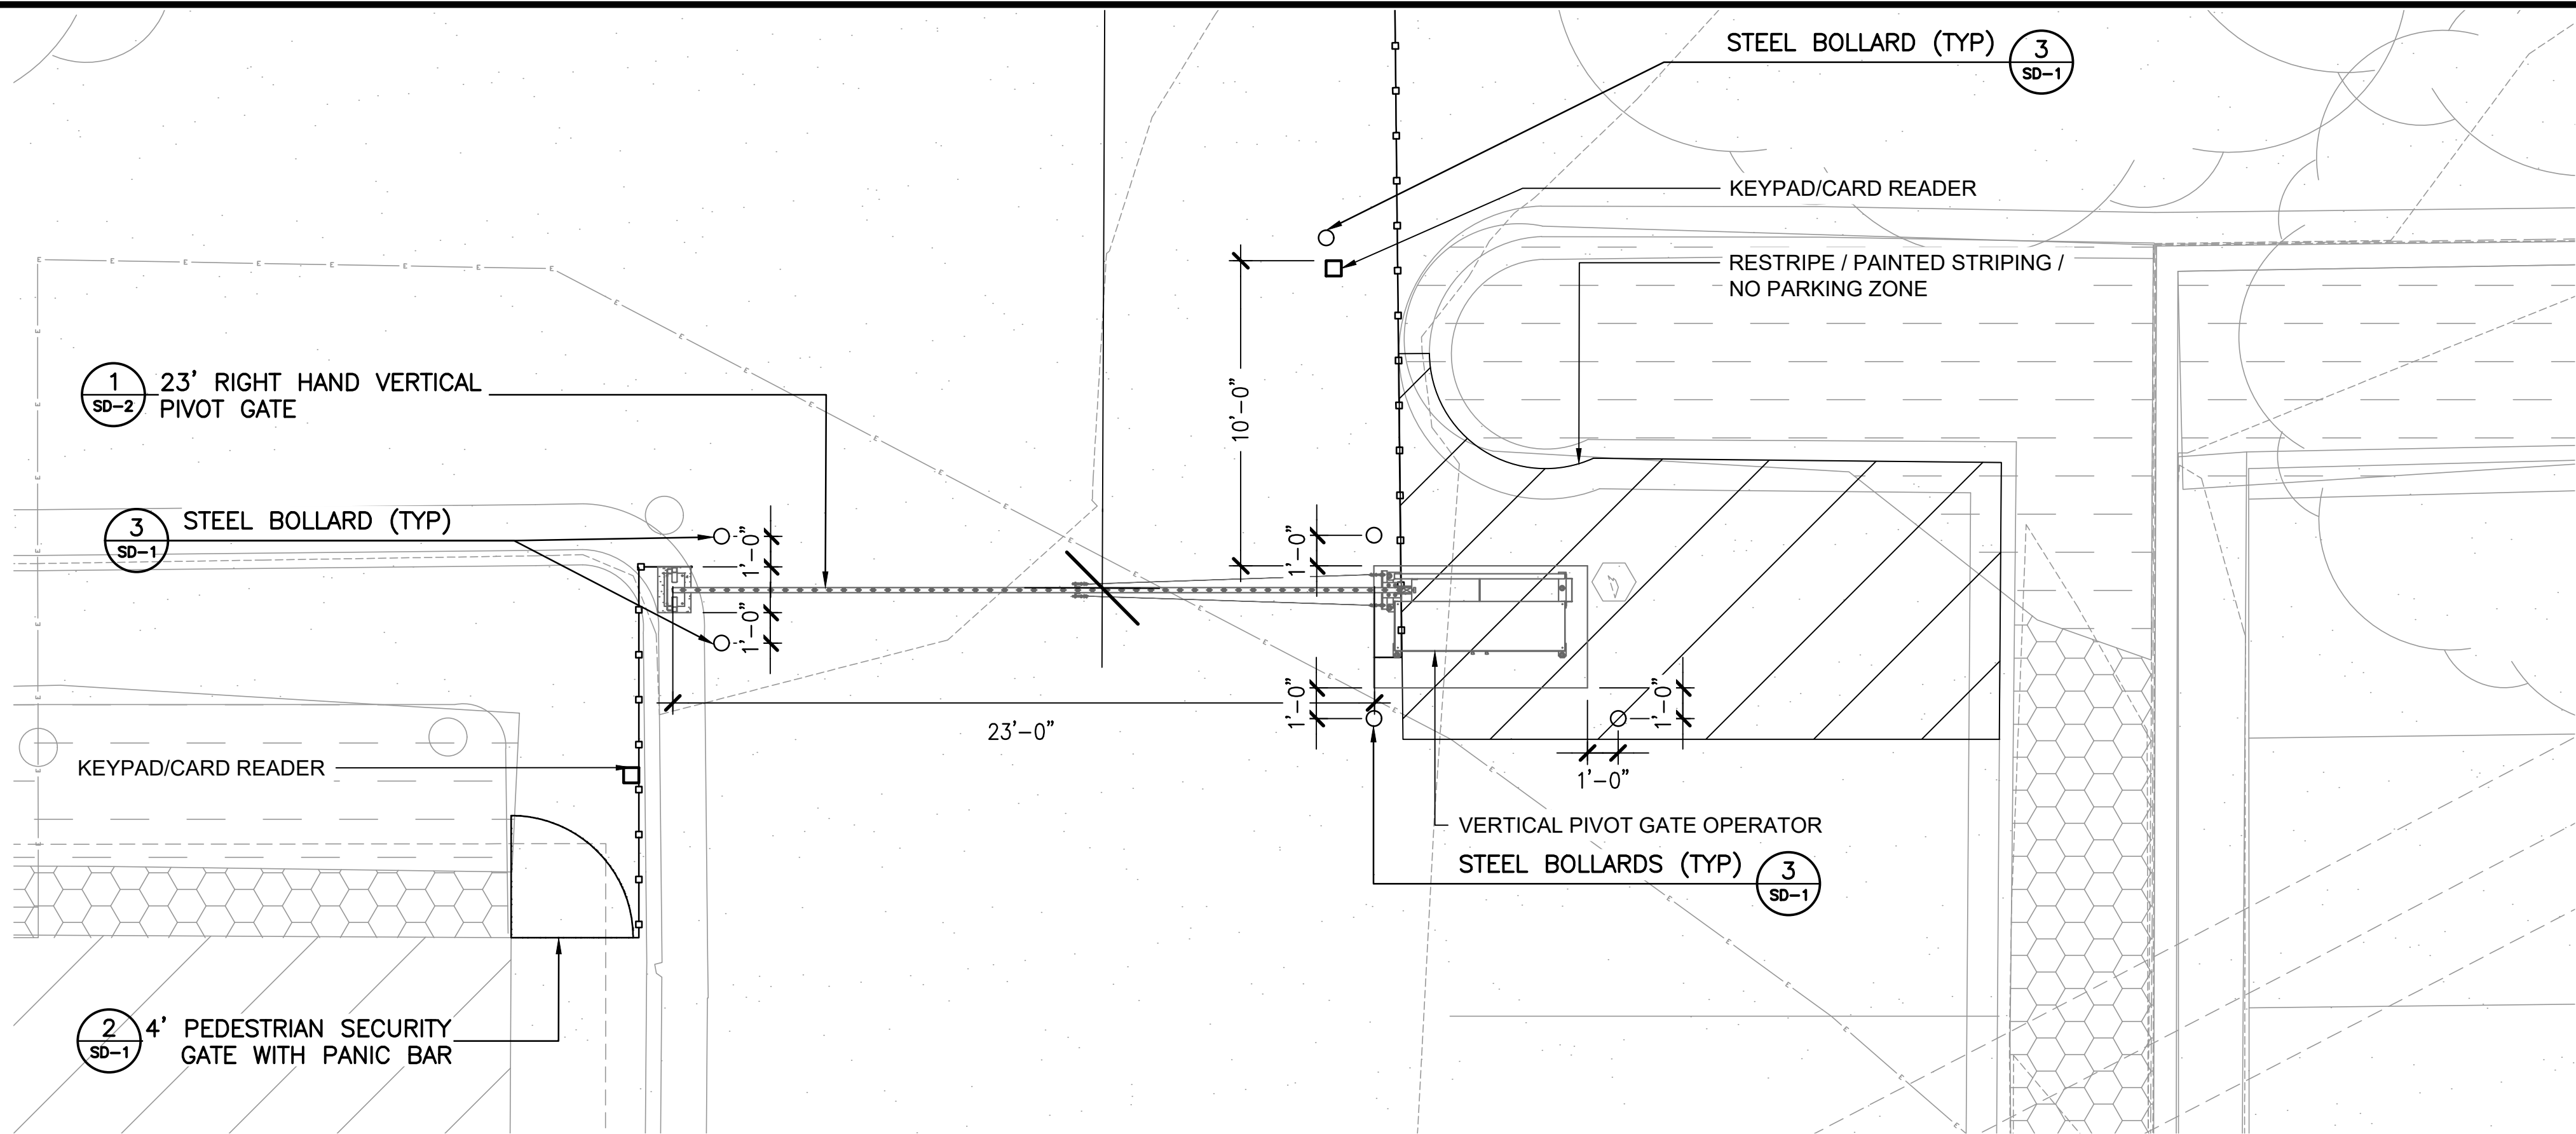


VERTICAL PIVOT GATE ENLARGEMENT



LEGEND

- RIVER ROCK MULCH
- SECURITY FENCE
- SECURITY GATE
- STEEL EDGER


NOTE:
THE DEVELOPER, HIS OR HER SUCCESSORS, AND ASSIGNS SHALL BE RESPONSIBLE FOR INSTALLATION, MAINTENANCE, AND REPLACEMENT OF THE ACCESS CONTROL GATE OR BARRIER SYSTEM TO ENSURE EMERGENCY VEHICLE ACCESS TO WITHIN THE SITE. IF THE ABOVE CONDITIONS ARE NOT MET, THE OWNERS, HIS OR HER SUCCESSORS, AND ASSIGNS, SHALL BE REQUIRED BY FIRE DEPARTMENT ORDER NOTICE THAT ALL AFFECTED GATES BE CHAINED AND LOCKED IN THE OPEN POSITION UNTIL REPAIRED OR REPLACED, AND RETESTED TO ALL CITY OF AURORA STANDARDS AT THE TIME OF THE VIOLATION. IF THE GATING SYSTEM IS NOT MAINTAINED TO THE SATISFACTION OF THE FIRE DEPARTMENT, THE LICENSE FOR THE EMERGENCY VEHICLE GATE OPENING SYSTEM WILL BE REVOKED AND THE GATING SYSTEM MUST BE REMOVED. THE GATING SYSTEM WILL INCLUDE AN EMERGENCY VEHICLE GATE OPENING SYSTEM UTILIZING A REDUNDANCY BACK-UP SYSTEM THAT CONSISTS OF; A) SIREN OPERATED SYSTEM; B) AUTOMATIC KNOX KEY SWITCH; C) AN ELECTRICAL OR BATTERY BACK UP SYSTEM THAT OPENS THE GATE ON THE LOSS OF THE PRIMARY ELECTRICAL POWER; AND D) MANUAL OVERRIDE IN THE EVENT OF SYSTEM FAILURE).

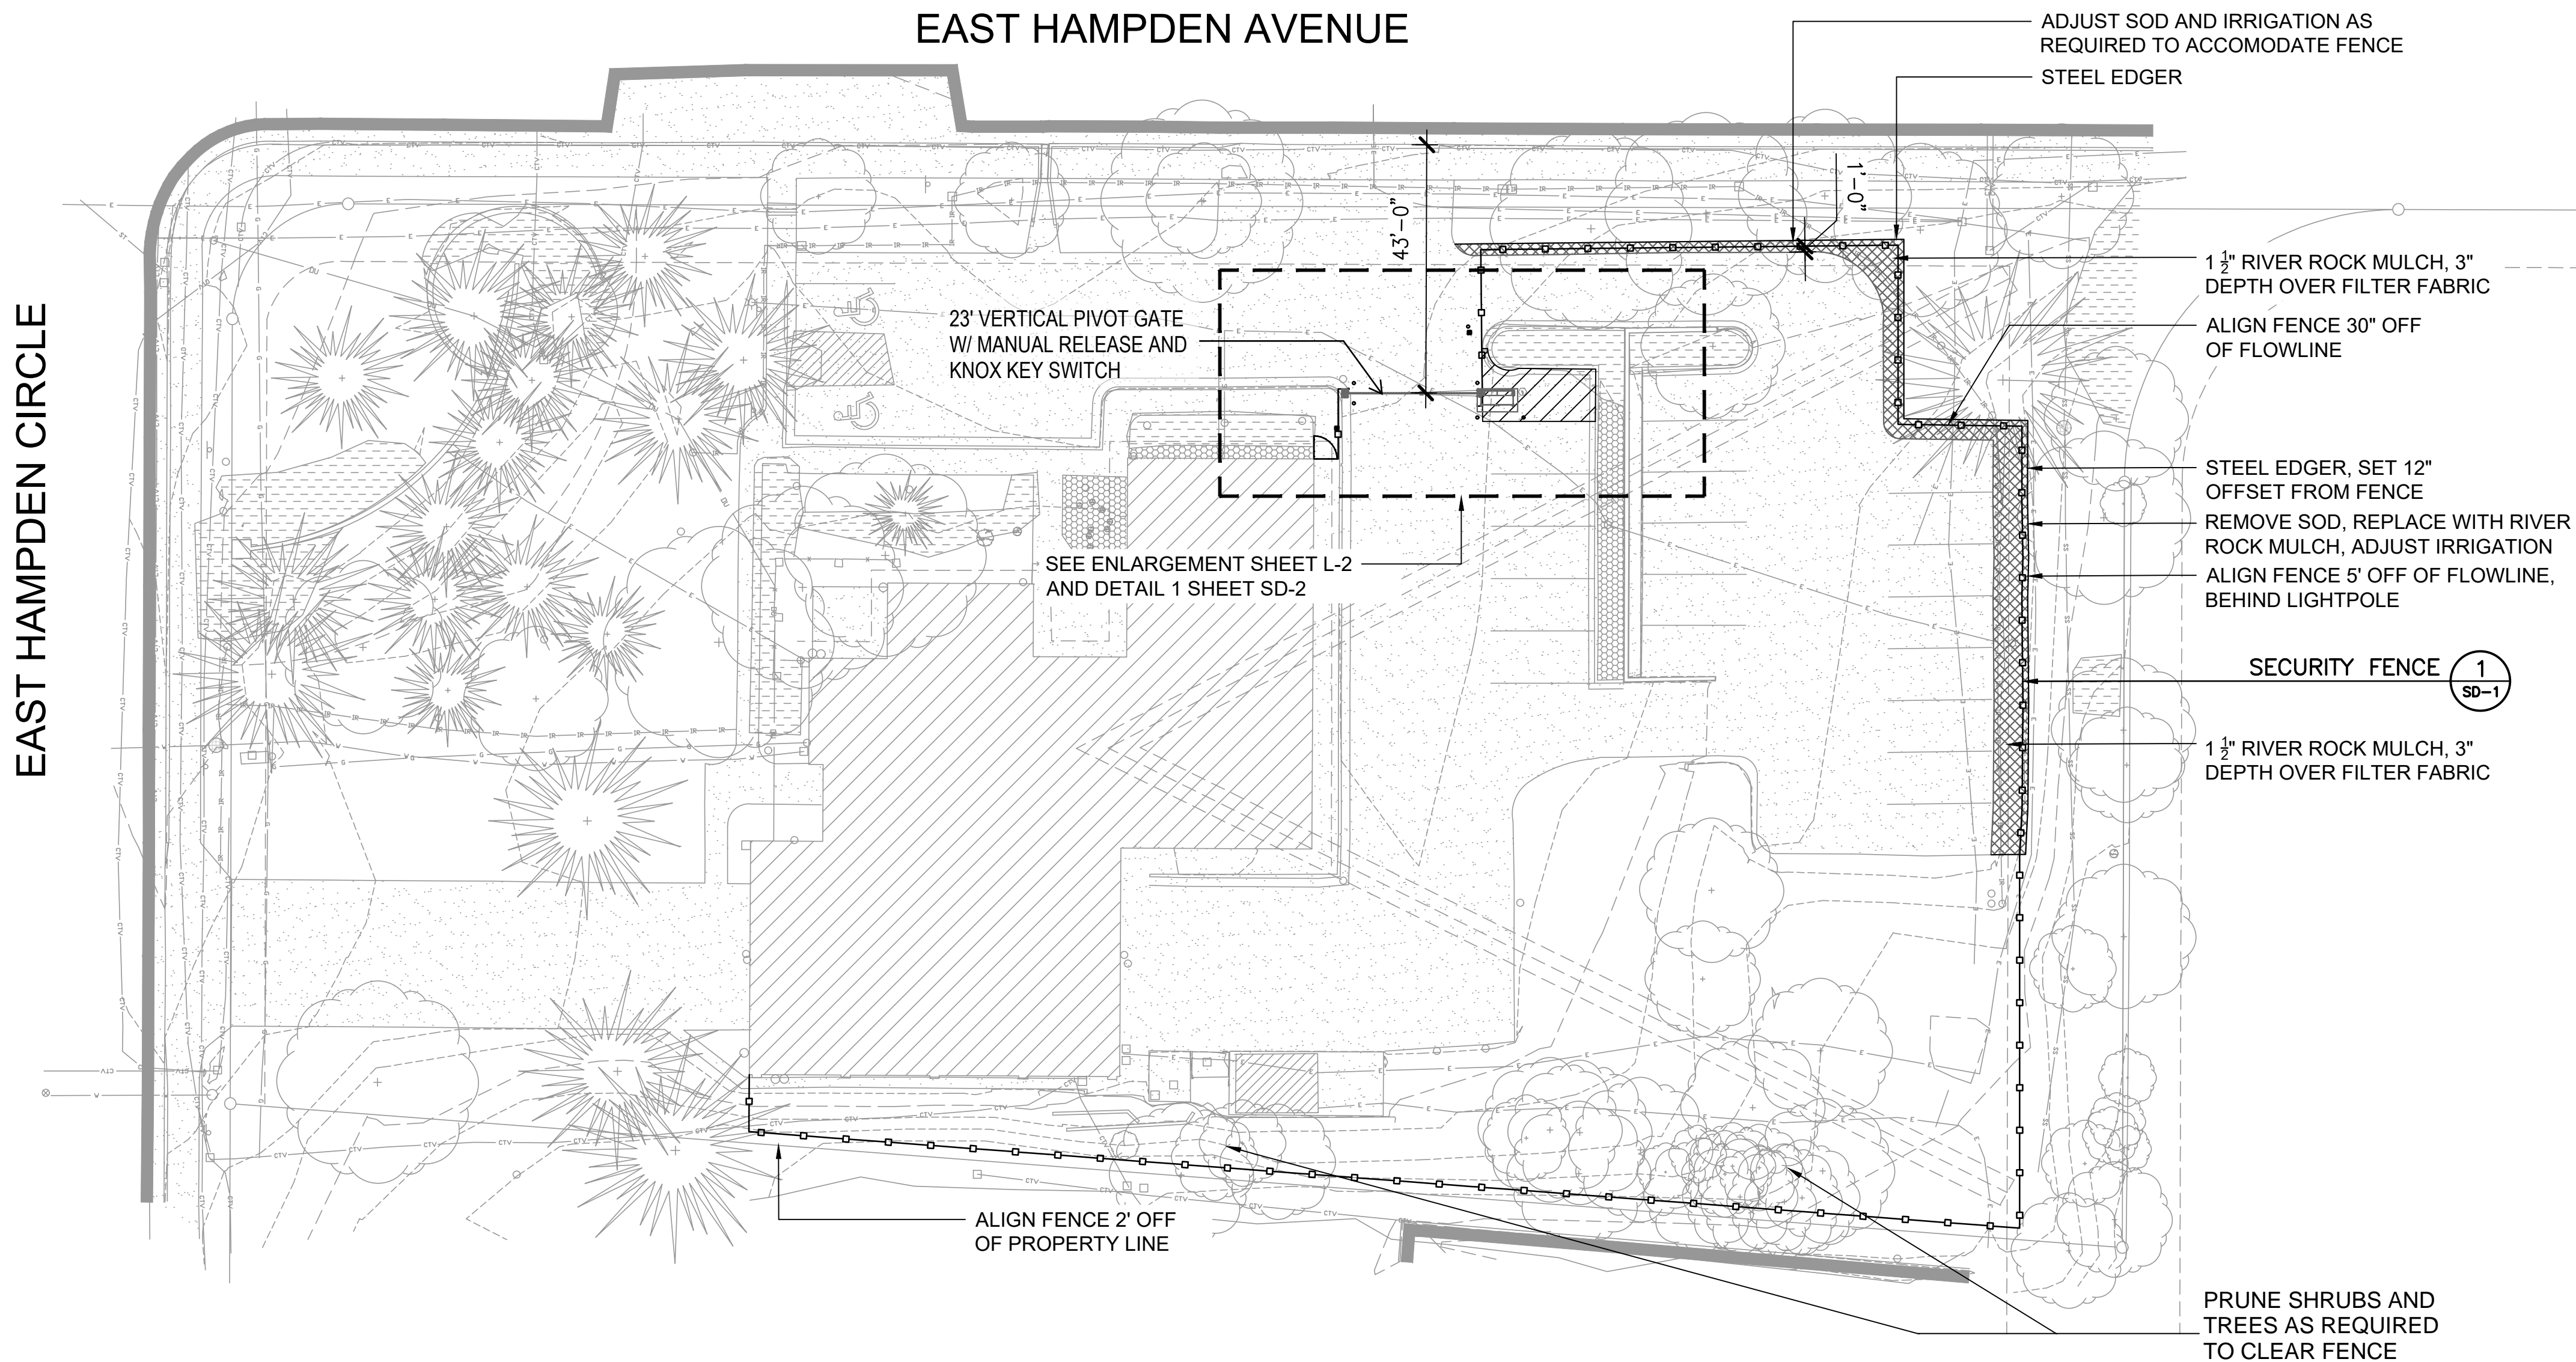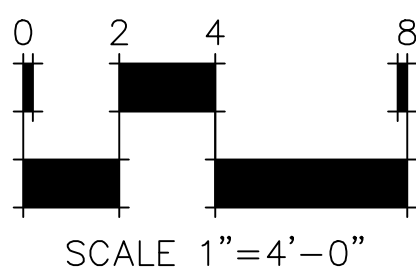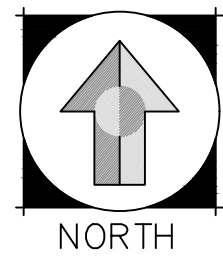


NOTE:
WHERE THEY ARE UNABLE TO BE SAVED, EXISTING PLANTINGS SHALL BE RELOCATED OR REPLACED IN KIND, AS NEEDED, DURING CONSTRUCTION OF THE FENCE.

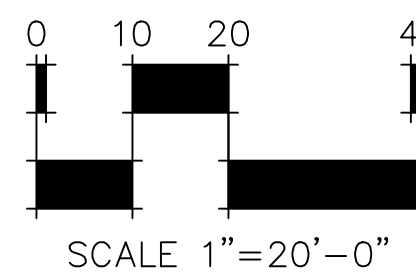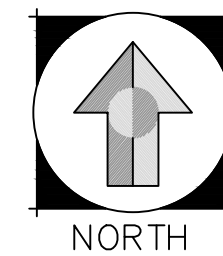

NO.	DATE	DESCRIPTION
11/08/23		Construction Documents
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02/22/24		Building Permit Set

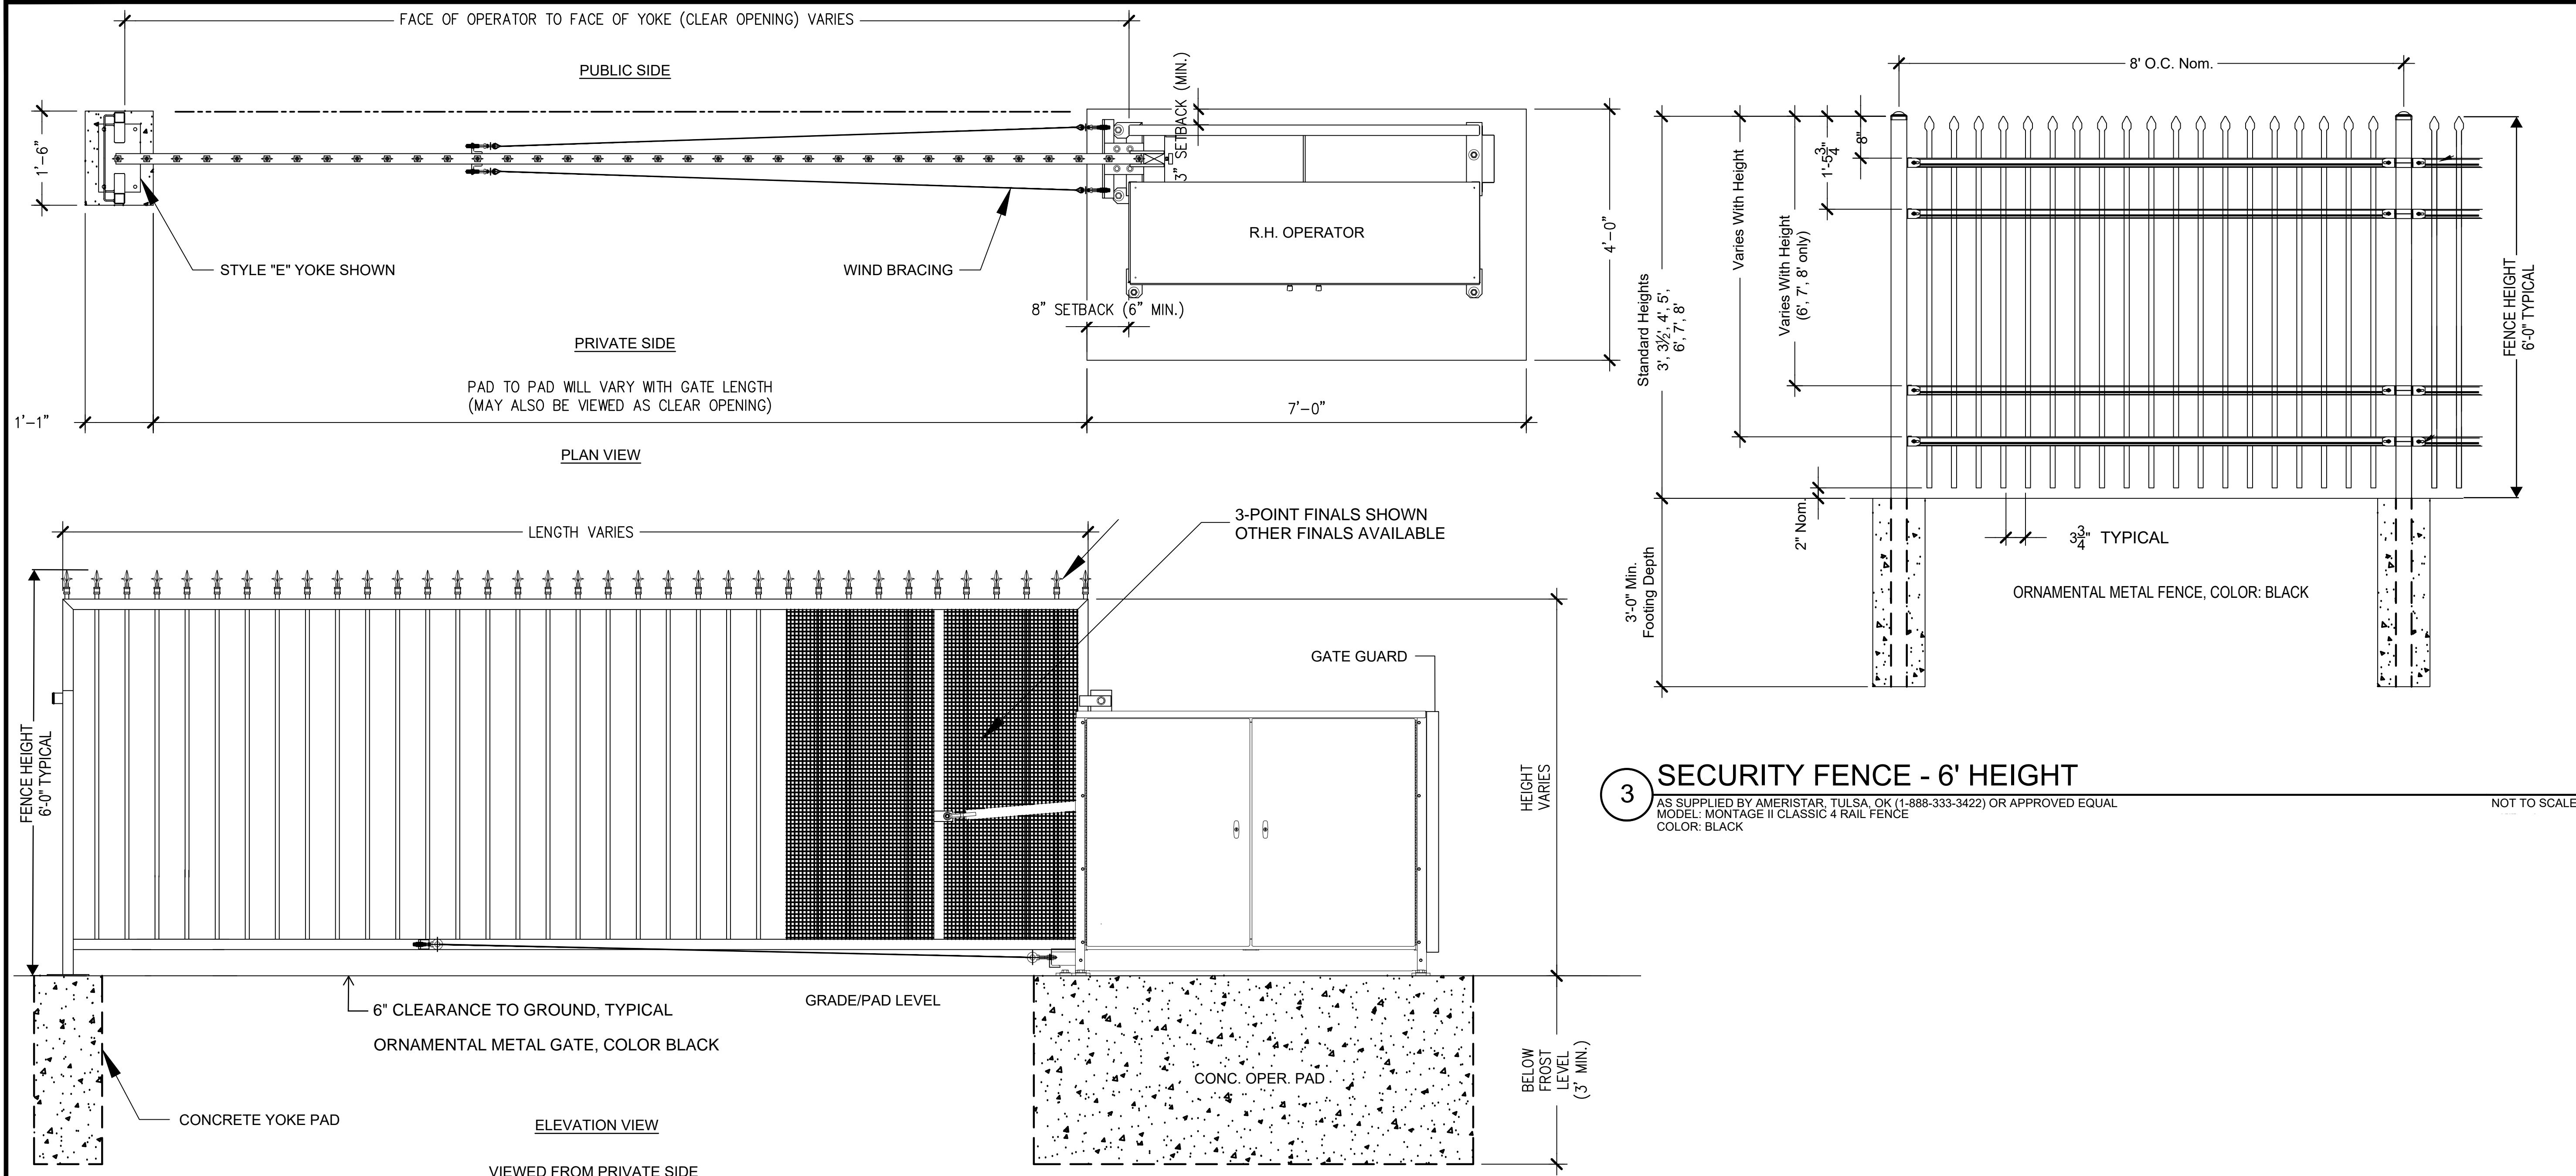


4 23' VERTICAL PIVOT GATE
AS SUPPLIED BY AUTOGATE, BERLIN HEIGHTS, OHIO FAX: 419-588-3514
MODEL: LEFTHAND BUCKEYE 500
NOT TO SCALE

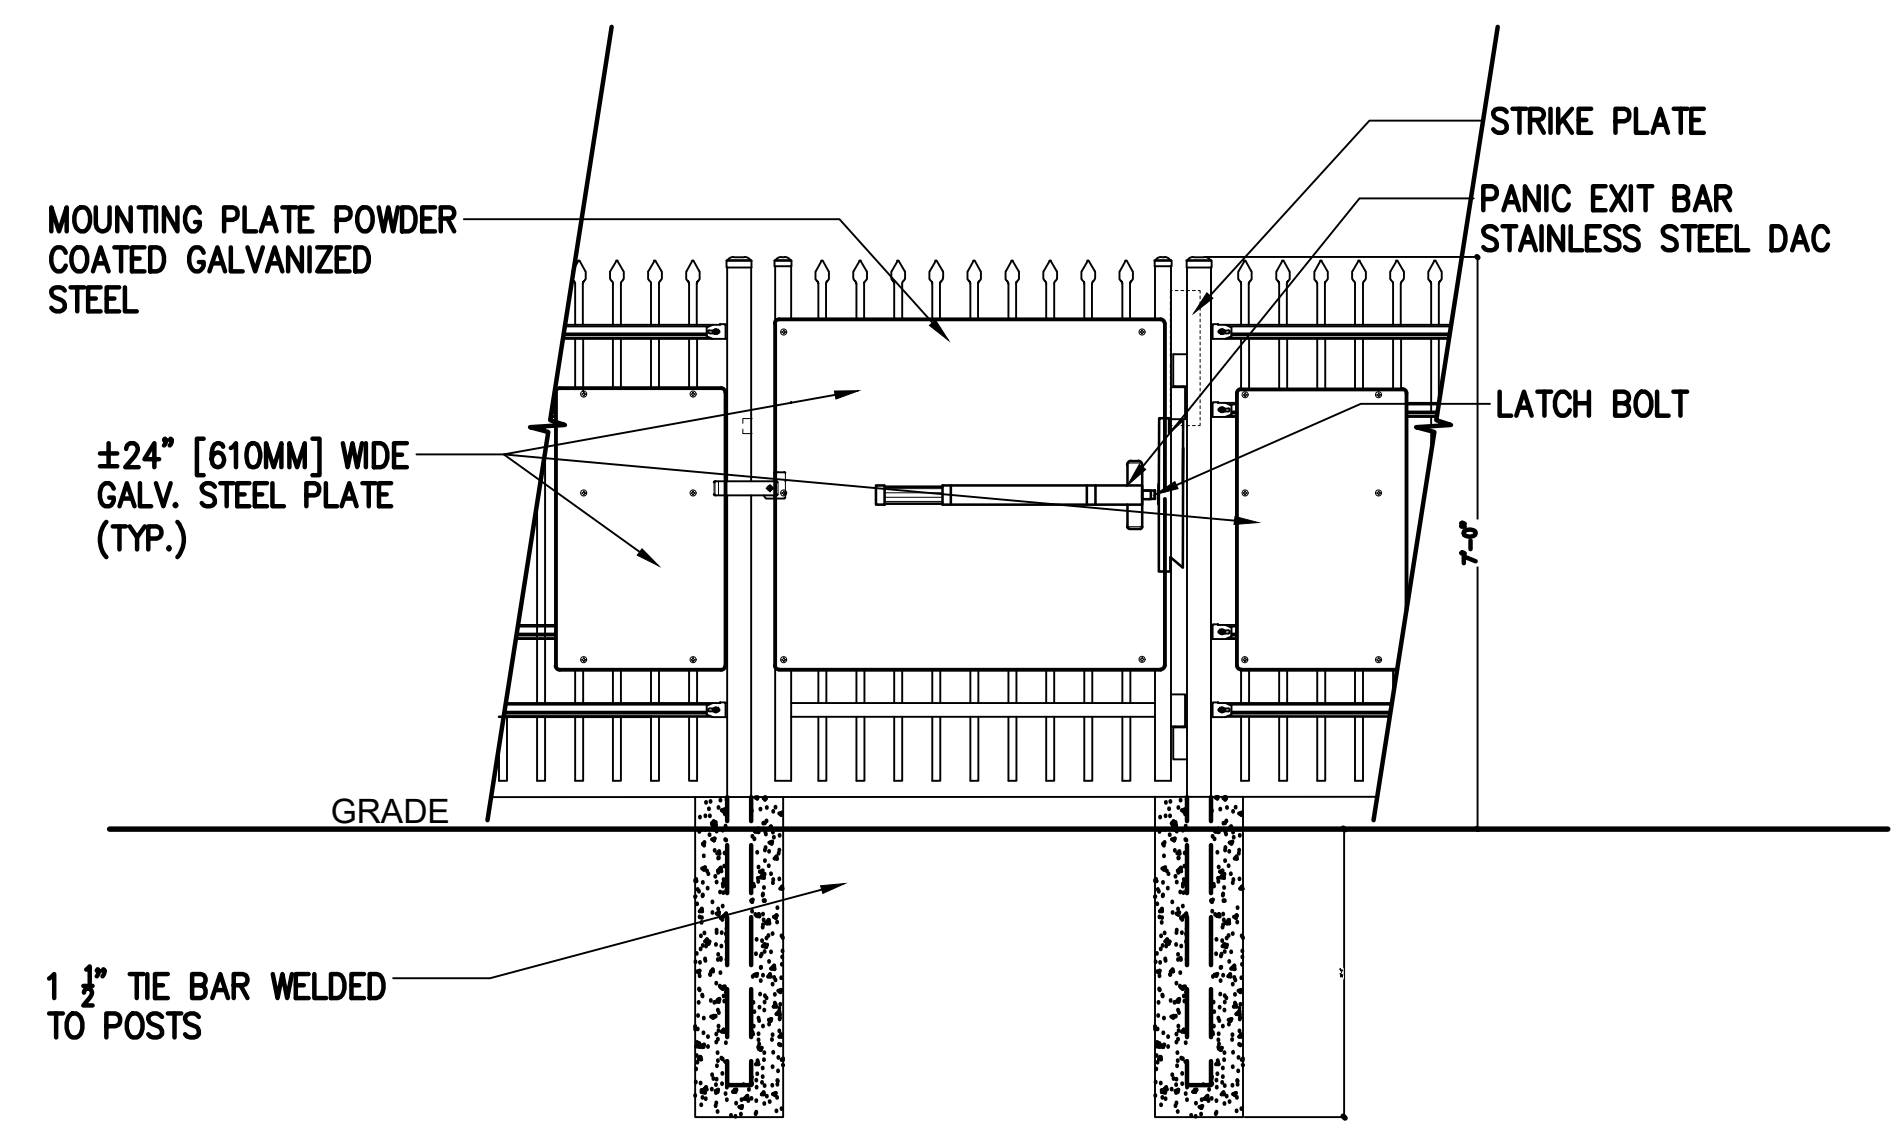


NOTES:
1. SPECIFICATIONS CAN BE CHANGED BY MERCHANT METALS ONLY
2. PANEL TO BE +/-24" PERFORATED GALVANIZED STEEL
3. ULTRA HEAVY DUTY MAMMOTH HYDRAULIC GATE CLOSER AND RAPTOR HINGES (TOP & BOTTOM) AS PROVIDED BY LOGINOX, GENDALE HEIGHTS, IL, USA (877).562.4669 OR APPROVED EQUAL

2 4' PEDESTRIAN GATE WITH PANIC BAR
AS SUPPLIED BY AMERISTAR, TULSA, OK (1-888-333-3422) OR APPROVED EQUAL
MODEL: 6' HEIGHT MONTAGE II CLASSIC 3 RAIL SINGLE
NOT TO SCALE

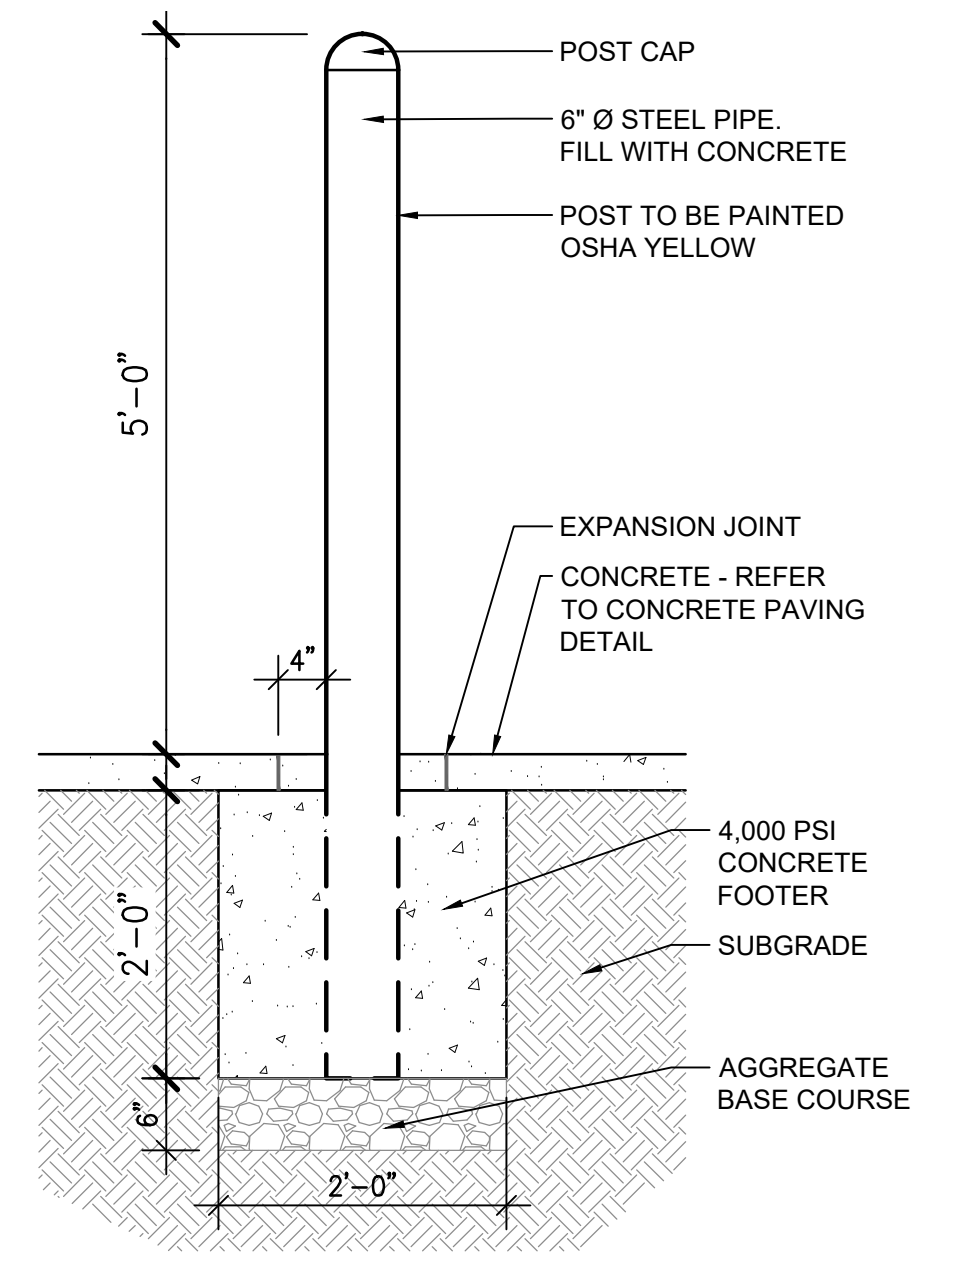

1 STEEL BOLLARD
SCALE: 3/4" = 1'-0"

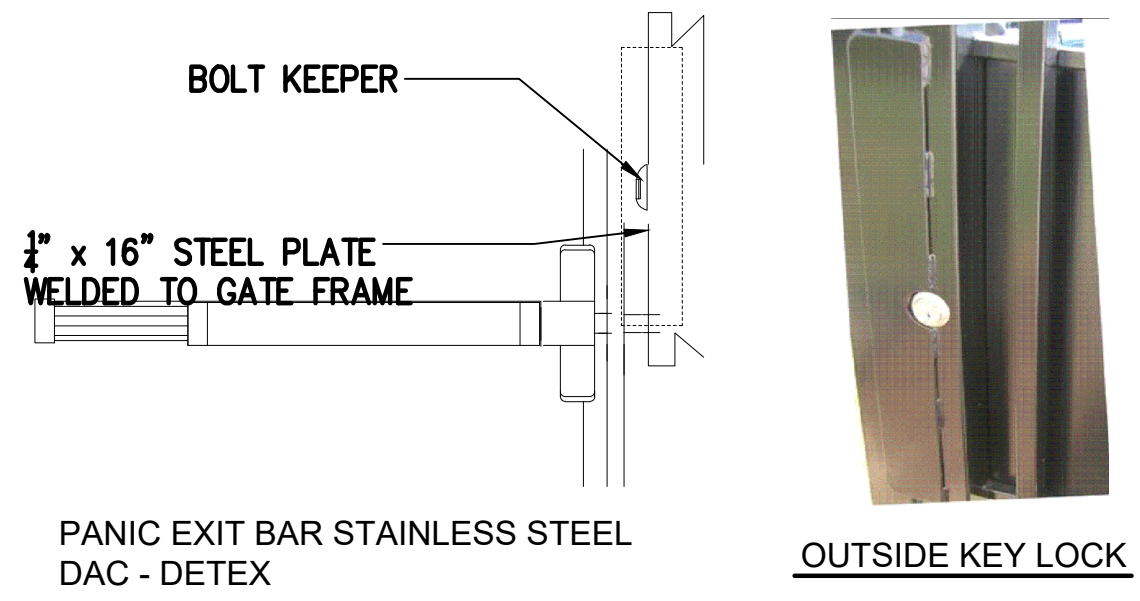

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BLDG #1312

FIRE STATION #6
Aurora Fire Rescue
15588 E. Hampden Cir.
Aurora, Colorado 80013

PROJECT #R-2287

PROJ. NO. R-2287
DRAWN: CS
CHECKED: MW
CADD FILE:
DATE: 02/22/2024

NO.	DATE	DESCRIPTION
11/08/23		Construction Documents
01/12/24		Bid Documents
02/22/24		Building Permit Set

FIRE STATION #6
AURORA FIRE RESCUE
CONSTRUCTION DRAWING SET

SHEET TITLE:
SITE DETAILS

SCALE: NTS
SHEET NUMBER:

1

SD-1