

CITY OF AURORA SITE PLAN NOTES

1.

THE DEVELOPER, HIS SUCCESSORS AND ASSIGNS, INCLUDING THE HOMEOWNERS OR MERCHANTS ASSOCIATION, SHALL BE RESPONSIBLE FOR INSTALLATION, MAINTENANCE, AND REPLACEMENT OF ALL FIRE LANE SIGNS AS REQUIRED BY THE CITY OF AURORA.
2.

ALL SIGNS SHALL CONFORM TO THE CITY OF AURORA SIGN CODE.
3.

RIGHT OF WAY FOR INGRESS AND EGRESS FOR SERVICE AND EMERGENCY VEHICLES IS GRANTED OVER, ACROSS, ON AND THROUGH ANY AND ALL PRIVATE ROADS AND WAYS NO OR HEREAFTER ESTABLISHED ON THE DESCRIBED PROPERTY, AND THE SAME ARE HEREBY DESIGNATED AS "SERVICE/EMERGENCY AND UTILITY EASEMENTS" AND SHALL BE POSTED "NO PARKING - FIRE LANE."
4.

ACCESSIBLE EXTERIOR ROUTES" SHALL BE PROVIDED FROM PUBLIC TRANSPORTATION STOPS, ACCESSIBLE PARKING AND ACCESSIBLE PASSENGER LOADING ZONES AND PUBLIC SIDEWALKS TO 60% OF THE ACCESSIBLE BUILDING ENTRANCE THEY SERVE. THE ACCESSIBLE ROUTE BETWEEN ACCESSIBLE PARKING AND ACCESSIBLE BUILDING ENTRANCES SHALL BE THE MOST PRACTICAL DIRECT ROUTE. THE ACCESSIBLE ROUTE MUST BE LOCATED WITHIN A SIDEWALK. NO SLOPE ALONG THIS ROUTE MAY EXCEED 1:20 WITHOUT PROVIDING A RAMP WITH A MAXIMUM SLOPE OF 1:12 AND HANDRAILS. CROSSWALKS ALONG THIS ROUTE SHALL BE WIDE ENOUGH TO WHOLLY CONTAIN THE CURB RAMP WITH A MINIMUM WIDTH OF 36" AND SHALL BE PAINTED WITH WHITE STRIPES. THE CITY OF AURORA ENFORCES HANDICAPPED ACCESSIBILITY REQUIREMENTS BASED ON THE 2015 INTERNATIONAL BUILDING CODE, CHAPTER 11, AND THE AMERICAN NATIONAL STANDARDS INSTITUTE (ICC/ANSI) A117-2009. THE DEVELOPER, OWNER AND ASSIGNS ARE RESPONSIBLE FOR COMPLYING WITH THE FEDERALLY MANDATED REQUIREMENTS OF THE AMERICANS WITH DISABILITIES ACT (ADA), AND AS SUCH, THE CITY OF AURORA DOES NOT ENFORCE THESE LAWS.
5.

THE APPLICANT HAS THE OBLIGATION TO COMPLY WITH ALL APPLICABLE REQUIREMENT OF THE AMERICANS WITH DISABILITIES ACT.
6.

THE DEVELOPER, HIS SUCCESSORS AND ASSIGNS, SHALL BE RESPONSIBLE FOR INSTALLATION, MAINTENANCE AND REPLACEMENT OF ALL LANDSCAPING MATERIALS SHOWN OR INDICATED ON THE APPROVED SITE PLAN OR LANDSCAPE PLAN ON FILE IN THE PLANNING DEPARTMENT. ALL LANDSCAPING WILL BE INSTALLED PRIOR TO ISSUANCE OF CERTIFICATE OF OCCUPANCY.
7.

ALL CROSSINGS OR ENCROACHMENTS INTO EASEMENTS AND RIGHTS-OF-WAY OWNED BY THE CITY OF AURORA ("CITY") IDENTIFIED AS BEING PRIVATELY-OWNED AND MAINTAINED HEREIN ARE ACKNOWLEDGED BY THE UNDERSIGNED AS BEING SUBJECT TO CITY'S USE AND OCCUPANCY OF SAID EASEMENTS OR RIGHTS-OF-WAY. THE UNDERSIGNED, ITS SUCCESSORS AND ASSIGNS, FURTHER AGREES TO REMOVE, REPAIR, REPLACE, RELOCATE, MODIFY, OR OTHERWISE ADJUST SAID CROSSINGS OR ENCROACHMENTS UPON REQUEST FROM THE CITY AND AT NO EXPENSE TO THE CITY. THE CITY RESERVES THE RIGHT TO MAKE FULL USE OF THE EASEMENTS AND RIGHTS-OF-WAY AS MAY BE NECESSARY OR CONVENIENT AND THE CITY RETAINS ALL RIGHTS TO OPERATE, MAINTAIN, INSTALL, REPAIR, REMOVE OR RELOCATE ANY CITY FACILITIES LOCATED WITHIN SAID EASEMENTS AND RIGHTS-OF-WAY AT ANY TIME AND IN SUCH A MANNER AS IT DEEMS NECESSARY OR CONVENIENT.
8.

THE APPROVAL OF THIS DOCUMENT DOES NOT CONSTITUTE FINAL APPROVAL OF GRADING, DRAINAGE, UTILITY, PUBLIC IMPROVEMENTS AND BUILDING PLANS. CONSTRUCTION PLANS MUST BE REVIEWED AND APPROVED BY THE APPROPRIATE AGENCY PRIOR TO THE ISSUANCE OF BUILDING PERMITS.
9.

ALL BUILDING ADDRESS NUMBERS SHALL COMPLY WITH THE AURORA CITY CODE OF ORDINANCE, CHAPTER 126, ARTICLE VII - NUMBERING OF BUILDINGS.
10.

ALL ROOFTOP MECHANICAL EQUIPMENT AND VENTS GREATER THAN EIGHT (8) INCHES IN DIAMETER MUST BE SCREENED. SCREENING MAY BE DONE EITHER WITH AN EXTENDED PARAPET WALL OR A FREESTANDING SCREEN WALL. SCREENS SHALL BE AT LEAST AS HIGH AS THE EQUIPMENT THEY HIDE. IF EQUIPMENT IS VISIBLE BECAUSE SCREENS DON'T MEET THIS MINIMUM HEIGHT REQUIREMENT, THE DIRECTOR OF PLANNING MAY REQUIRE CONSTRUCTION MODIFICATIONS PRIOR TO THE ISSUANCE OF A PERMANENT CERTIFICATE OF OCCUPANCY.
11.

NOTWITHSTANDING ANY SURFACE IMPROVEMENTS, LANDSCAPING, PLANTING OR CHANGES SHOWN IN THESE SITE OR CONSTRUCTION PLANS, OR ACTUALLY CONSTRUCTED OR PUT IN PLACE, ALL UTILITY EASEMENTS MUST REMAIN UNOBTSTRUCTED AND FULLY ACCESSIBLE ALONG THEIR ENTIRE LENGTH TO ALLOW FOR ADEQUATE MAINTENANCE EQUIPMENT. ADDITIONALLY, NO INSTALLATION, PLANTING, CHANGE IN THE SURFACE, ETC., SHALL INTERFERE WITH THE OPERATION OF THE UTILITY LINES PLACED WITHIN THE EASEMENT. BY SUBMITTING THESE SITE OR CONSTRUCTION PLANS FOR APPROVAL, THE LANDOWNER RECOGNIZES AND ACCEPTS THE TERMS, CONDITIONS AND REQUIREMENTS OF THIS NOTE.
12.

FINAL GRADE SHALL BE AT LEAST SIX (6) INCHES BELOW ANY EXTERIOR WOOD SIDING ON THE PREMISES.
13.

ALL INTERESTED PARTIES ARE HEREBY ALERTED THAT THIS SITE PLAN IS SUBJECT TO ADMINISTRATIVE CHANGES AND AS SHOWN ON THE ORIGINAL SITE PLAN ON FILE IN THE AURORA CITY PLANNING OFFICE AT THE MUNICIPAL BUILDING. A COPY OF THE OFFICIAL CURRENT PLAN MAY BE PURCHASED THERE. LIKEWISE, SITE PLANS ARE REQUIRED TO AGREE WITH THE APPROVED SUBDIVISION PLAT OF RECORD AT THE TIME OF A BUILDING PERMIT; AND IF NOT, MUST BE AMENDED TO AGREE WITH THE PLAT AS NEEDED, OR VICE VERSA.
14.

ERRORS IN APPROVED SITE PLANS RESULTING FROM COMPUTATIONS OR INCONSISTENCIES IN THE DRAWINGS MADE BY THE APPLICANT ARE THE RESPONSIBILITY OF THE PROPERTY OWNER OF RECORD. WHERE FOUND, THE CURRENT MINIMUM CODE REQUIREMENTS WILL APPLY AT THE TIME OF BUILDING PERMIT. PLEASE BE SURE THAT ALL PLAN COMPUTATIONS ARE CORRECT.
15.

ALL REPRESENTATIONS AND COMMITMENTS MADE BY APPLICANTS AND PROPERTY OWNERS AT PUBLIC HEARINGS REGARDING THIS PLAN ARE BINDING UPON THE APPLICANT, PROPERTY OWNER, AND ITS HEIRS, SUCCESSORS, AND ASSIGNS.
16.

ARCHITECTURAL FEATURES (I.E. BAY WINDOWS, FIREPLACES, ROOF OVERHANG, GUTTERS, EAVES, FOUNDATION, FOOTINGS, CANTILEVERED WALLS, ETC.) ARE NOT ALLOWED TO ENCR OACH INTO ANY EASEMENT OR FIRE LANE.
17.

THE DEVELOPER SHALL HAVE A REGISTERED PROFESSIONAL ENGINEER CERTIFY EACH STORMWATER DETENTION POND AND/OR WATER QUALITY BMP IS BUILT ACCORDING TO THE APPROVED PLANS AND SPECIFICATIONS AND THE REQUIRED DETENTION VOLUME, INCLUDING THE WQCV WHEN USED, IS MET. THE CERTIFICATION SHALL ALSO VERIFY ALL PERTINENT DIMENSIONS, ELEVATIONS, REQUIRED OUTLET ORIFICE PLATES FOR DETENTION AND WQCV AND OTHER PERMANENT BMPS REQUIREMENTS ARE INSTALLED PER THE APPROVED PLANS AND SPECIFICATIONS, AND SHALL SHOW THE AS-BUILT VOLUMES FOR THE 100-YEAR, 10-YEAR STORM EVENTS, AND FOR THE WQCV AND OTHER PERTINENT DIMENSIONS, ELEVATIONS AND CAPACITY REQUIREMENTS ASSOCIATED WITH THE WQ BMP USED. THE CERTIFICATIONS SHALL BE PROVIDED TO THE CITY OF AURORA ENGINEERING CONTROL SECTION SENIOR ENGINEER BEFORE A CERTIFICATE OF OCCUPANCY WILL BE ISSUED.
18.

IN LOCATIONS WHERE UTILITY EASEMENTS OVERLAP DRAINAGE EASEMENTS, ONLY SUBSURFACE UTILITIES SHALL BE PERMITTED WITHIN THE PORTION OF THE UTILITY EASEMENT THAT OVERLAPS THE DRAINAGE EASEMENT. INSTALLATION OF ABOVE GROUND UTILITIES WITHIN A DRAINAGE EASEMENT REQUIRES PRIOR WRITTEN APPROVAL BY CITY ENGINEER.
19.


THE DEVELOPER IS RESPONSIBLE FOR SIGNING AND STRIPING ALL PUBLIC STREETS. THE DEVELOPER IS REQUIRED TO PLACE TRAFFIC CONTROL, STREET NAME, AND GUIDE SIGNS ON ALL PUBLIC STREETS AND PRIVATE STREETS APPROACHING AN INTERSECTION WITH A PUBLIC STREET. SIGNS SHALL BE FURNISHED AND INSTALLED PER THE MOST CURRENT EDITIONS OF THE MANUAL ON UNIFORM TRAFFIC CONTROL DEVICES (MUTCD) AND CITY STANDARDS AND SHOWN ON THE SIGNING AND STRIPING PLAN FOR THE DEVELOPMENT.
20.

THE 2015 INTERNATIONAL FIRE CODE, APPENDIX J AND CITY OF AURORA CODE, CHAPTER 66-38 FIRE PREVENTION REGULATIONS, REQUIRE ALL BUILDINGS TO BE ASSESSED FOR ADEQUATE EMERGENCY RESPONDER RADIO COVERAGE. AT THE TIME THE STRUCTURE IS AT FINAL FRAME AND FINAL ELECTRICAL INSPECTIONS. THE GENERAL CONTRACTOR (GC) WILL BE NOTIFIED BY A BUILDING DIVISION LIFE SAFETY INSPECTOR AS TO WHETHER THE STRUCTURE HAS PASSED OR FAILED THE PRELIMINARY RADIO SURVEILLANCE. A STRUCTURE THAT HAS PASSED THIS SURVEILLANCE REQUIRES NO FURTHER ACTION BY THE GC. A FAILED RADIO SURVEILLANCE WILL REQUIRE AN INDEPENDENT THIRD PARTY RADIO STUDY FOR THE ENTIRE BUILDING AT THE OWNER OR DEVELOPERS EXPENSE. WHERE AN EMERGENCY RESPONDER RADIO COVERAGE SYSTEM IS REQUIRED, A DESIGNATED CONTRACTOR SHALL SUBMIT PLANS TO THE BUILDING DIVISION TO OBTAIN A BUILDING PERMIT PRIOR TO INSTALLATION.
21.

THE DEVELOPER, HIS OR HER SUCCESSORS AND ASSIGNS SHALL BE RESPONSIBLE FOR INSTALLATION, MAINTENANCE AND REPLACEMENT OF THE ACCESS CONTROL GATE OR BARRIER SYSTEM TO ENSURE EMERGENCY VEHICLE ACCESS TO WITHIN THE SITE. IF THE ABOVE CONDITIONS ARE NOT MET, THE OWNERS, HIS OR HER SUCCESSORS AND ASSIGNS SHALL BE REQUIRED BY FIRE DEPARTMENT ORDER NOTICE THAT ALL AFFECTED GATES BE CHAINED AND LOCKED IN THE OPEN POSITION UNTIL REPAIRED OR REPLACED AND RETESTED TO ALL CITY OF AURORA STANDARDS AT THE TIME OF THE VIOLATION. IF THE GATING SYSTEM IS NOT MAINTAINED TO THE SATISFACTION OF THE FIRE DEPARTMENT, THE LICENSE FOR THE EMERGENCY VEHICLE GATE OPENING SYSTEM WILL BE REVOKED AND THE GATING SYSTEM MUST BE REMOVED. ELECTRONIC GATING SYSTEMS SHALL INCLUDE AN EMERGENCY VEHICLE GATE OPENING SYSTEM UTILIZING A REDUNDANCY BACK-UP SYSTEM THAT CONSISTS OF A SIREN OPERATED SYSTEM, AN AUTOMATIC KNOX KEY SWITCH AND A MANUAL OVERRIDE (IN THE EVENT OF SYSTEM FAILURE). GATING SYSTEMS WILL BE INSTALLED IN ACCORDANCE WITH THE "GATING SYSTEMS CROSSING FIRE APPARATUS ACCESS ROADS CHECKLIST". A SEPARATE BUILDING PERMIT THROUGH THE BUILDING DIVISION IS REQUIRED TO BE OBTAINED BY THE CONTRACTOR PRIOR TO THE INSTALLATION OF ANY GATING / BARRIER SYSTEM THAT CROSSES A DEDICATED FIRE LANE EASEMENT.
22.

ATTENTION BUILDING DIVISION: PER ARTICLE XI, C.O.A. BUILDING AND ZONING CODE, SECTION 22-425 THROUGH 22-434, AN ACOUSTIC ANALYSIS, PREPARED BY ACOUSTIC EXPERT THAT WILL IDENTIFY BUILDING DESIGN FEATURES NECESSARY TO ACCOMPLISH EXTERIOR NOISE REDUCTION TO ACHIEVE INTERIOR NOISE LEVELS NOT EXCEEDING UNDER WORSE 55-60 LDN CASE NOISE CONDITIONS.

SITE DEVELOPMENT PLAN  
LOTUS SCHOOL FOR EXCELLENCE ADDITION  
LOTS 1 & 2, ASSEMBLY OF GOD FILING NO. 3  
A PORTION OF THE SOUTHWEST QUARTER SECTION 11,  
TOWNSHIP 4 SOUTH, RANGE 67 WEST, OF THE 6TH P.M.  
CITY OF AURORA, COUNTY OF ARAPAHOE, STATE OF COLORADO

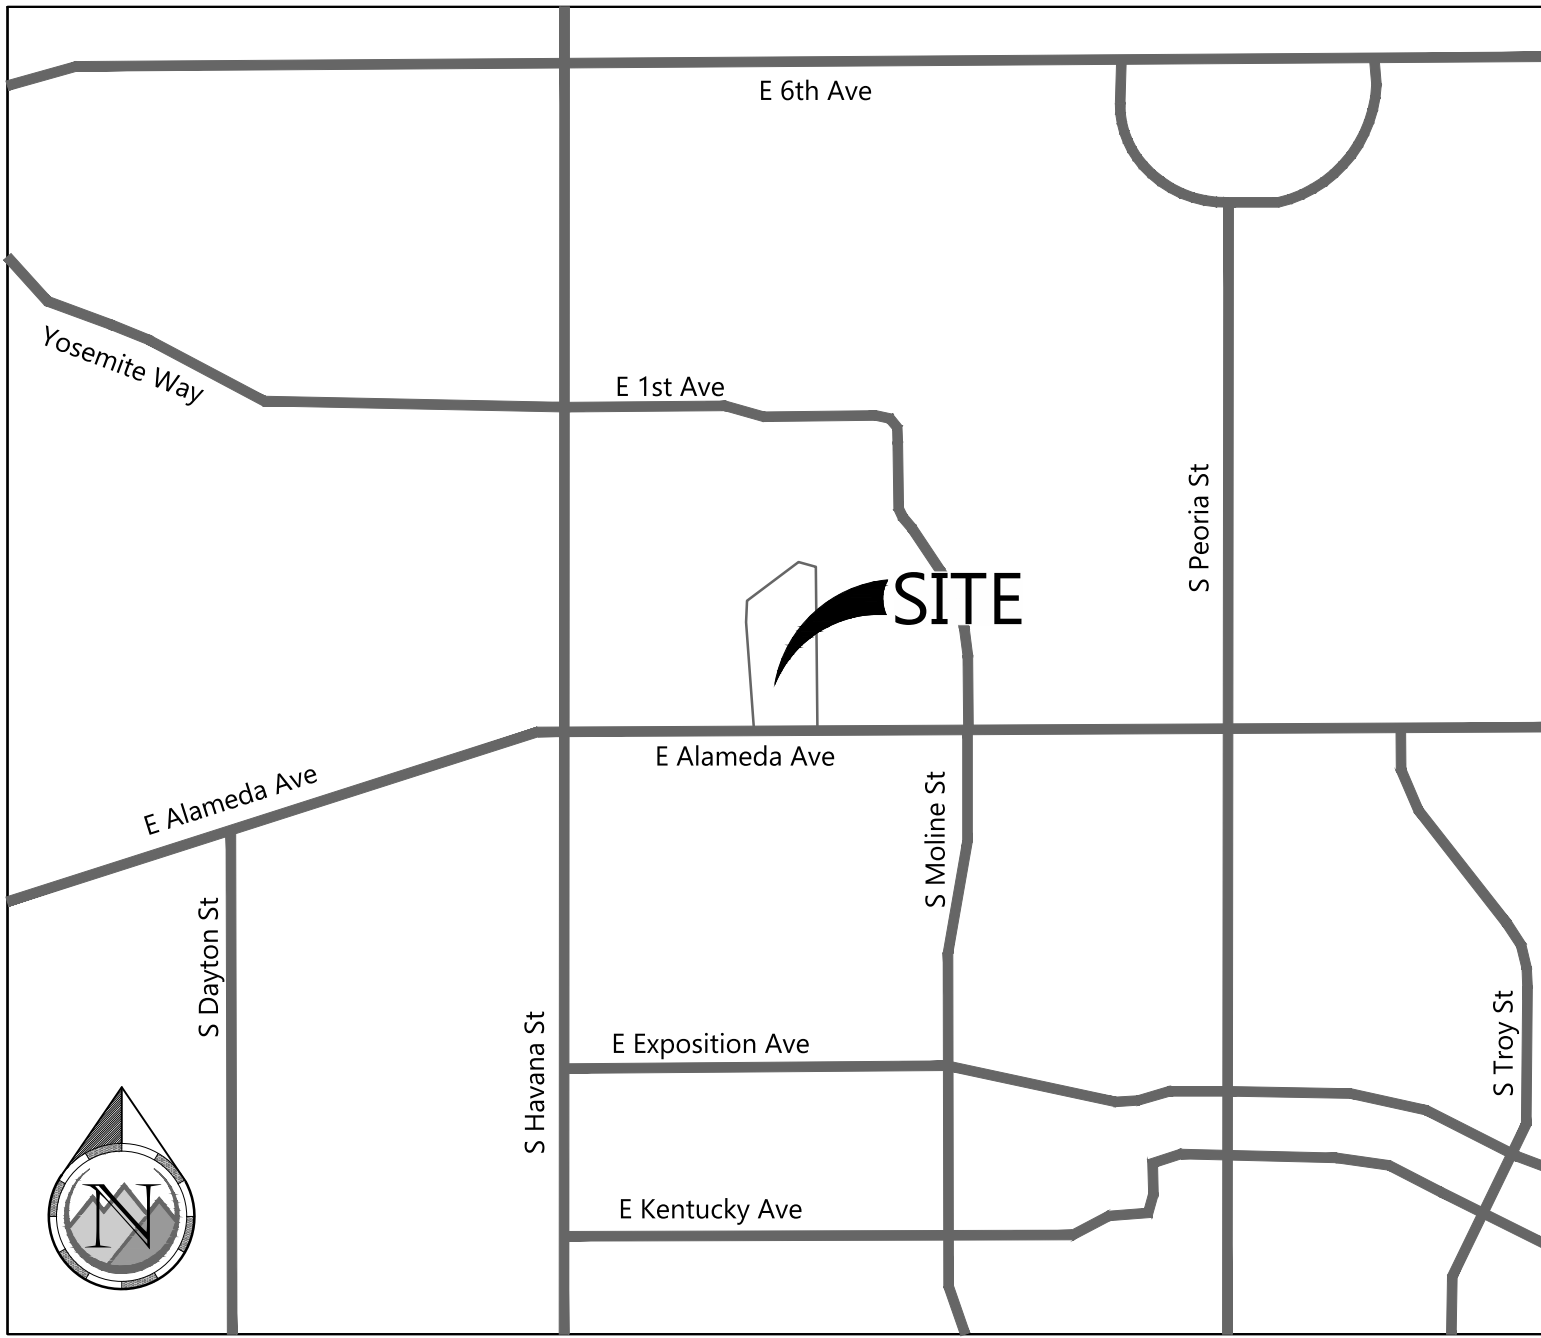

VICINITY MAP

1"=1500'

PROJECT DATA

PROPERTY SIZE (SF)	508,582
PROPERTY SIZE (ACRES)	11.68
LANDSCAPE AREA (SF)	175,598 (35%)
IMPERVIOUS AREA (SF)	332,984 (65%)
EXISTING ZONING CLASSIFICATION	R-2
REQUIRED ZONING CLASSIFICATION	R-2
NUMBER OF BUILDINGS	1
SQUARE FOOTAGE (BUILDING FOOTPRINT)	15,050 SF
SPRINKLERED OR NON SPRINKLERED	SPINKLERED
2021 IBC CONSTRUCTION TYPE	IIIB
OCCUPANCY GROUP	E & B
NUMBER OF STORIES	3
MAX BUILDING HEIGHT (FEET)	75'
PROPOSED BUILDING HEIGHT (FEET)	32'
TOTAL ALLOWED BUILDING SIGN AREA (SF)	232
PROPOSED BUILDING SIGN AREA (SF)	77
TOTAL ALLOWED MONUMENT SIGN AREA (SF)	100
TOTAL PROPOSED MONUMENT SIGN AREA (SF)	0
ALLOWED MONUMENT SIGN HEIGHT (FT)	7.0' MAX
PROPOSED MONUMENT SIGN HEIGHT (FT)	0
STANDARD PARKING SPACES REQUIRED	38
STANDARD PARKING SPACES PROVIDED	62
ACCESSIBLE PARKING SPACES REQUIRED	2
ACCESSIBLE PARKING SPACES PROVIDED	2
VAN ACCESSIBLE PARKING SPACES REQUIRED	1
VAN ACCESSIBLE PARKING SPACES PROVIDED	1
BICYCLE PARKING REQUIRED	4
BICYCLE PARKING PROVIDED	4

PROPERTY OWNER

LOTUS SCHOOL FOR EXCELLENCE FOUNDATION  
11001 E ALAMEDA AVENUE SUITE A  
AURORA, CO 80012  
303.360.0052

ENGINEER

PROOF CIVIL  
1531 MARKET STREET  
DENVER, CO 80202  
303.325.5709  
JASON DEYOUNG

BENCHMARK:

BENCHMARK: CITY OF AURORA BENCH MARK  
"456711SW006", 2" DIAMETER BRASS CAP LOCATED  
AT THE TOP OF EAST WINGWALL ON THE NORTH SIDE  
OF EAST ALAMEDA AVE. SAID WINGWALL FOR THE  
HIGHLINE CANAL BRIDGE (NAVD 88 DATUM).

SHEET INDEX

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ARCHITECT

ADRAGNA ARCHITECTURE + DEVELOPMENT  
7950 S. HANNIBAL CIR.  
ENGLEWOOD, CO 80112  
719.244.4023  
RYAN ADRAGNA, AIA, LEED AP BD+C

LANDSCAPE ARCHITECT:

RVI PLANNING + LANDSCAPE ARCHITECTURE  
3461 RINGSBY CT. STE. 420  
DENVER, CO 80216  
NICOLETTA GARDIA, PLA

PHOTOMETRICS

AE DESIGN  
1900 WAZEE ST. STE. 205  
DENVER, CO 80202  
720.673.8959  
RACHEL PETERSON

LEGAL DESCRIPTION:

LOTS 1&2, BLOCK 1, ASSEMBLY OF GOD FILING NO. 3, LOCATED IN THE SW  $\frac{1}{4}$  OF SECTION 11, TOWNSHIP 4S, R67W OF THE 6TH P.M.  
CITY OF AURORA, COUNTY OF ARAPAHOE, STATE OF COLORADO

THIS SITE PLAN AND ANY AMENDMENTS HERETO, UPON APPROVAL BY THE CITY OF AURORA AND RECORDING, SHALL BE BINDING UPON THE APPLICANTS THEREFORE, THEIR SUCCESSORS AND ASSIGNS. THIS PLAN SHALL LIMIT AND CONTROL THE ISSUANCE AND VALIDITY OF ALL BUILDING PERMITS, AND SHALL RESTRICT AND LIMIT THE CONSTRUCTION, LOCATION, USE, OCCUPANCY AND OPERATION OF ALL LAND AND STRUCTURES WITHIN THIS PLAN TO ALL CONDITIONS, REQUIREMENTS, LOCATIONS AND LIMITATIONS SET FORTH HEREIN. ABANDONMENT, WITHDRAWAL OR AMENDMENT OF THIS PLAN MAY BE PERMITTED ONLY UPON APPROVAL OF THE CITY OF AURORA.

IN WITNESS THEREOF, \_\_\_\_\_ HAS CAUSED THESE PRESENTS TO BE EXECUTED  
THIS \_\_\_\_ DAY OF \_\_\_\_\_, AD, 2023

BY: \_\_\_\_\_  
(PRINCIPALS OR OWNERS)

STATE OF COLORADO \_\_\_\_\_ )SS  
COUNTY OF \_\_\_\_\_ )

THE FOREGOING INSTRUMENT WAS ACKNOWLEDGED BEFORE ME THIS \_\_\_\_ DAY OF \_\_\_\_\_, AD, 2023 BY

WITNESS MY HAND AND OFFICIAL SEAL

NOTARY

SEAL

MY COMMISSION EXPIRES \_\_\_\_\_ NOTARY BUSINESS ADDRESS \_\_\_\_\_

CITY OF AURORA APPROVALS

CITY ATTORNEY: \_\_\_\_\_ DATE: \_\_\_\_\_

PLANNING DIRECTOR: \_\_\_\_\_ DATE: \_\_\_\_\_

PLANNING COMMISSION: \_\_\_\_\_ DATE: \_\_\_\_\_

CITY COUNCIL: \_\_\_\_\_ DATE: \_\_\_\_\_

ATTEST: \_\_\_\_\_ DATE: \_\_\_\_\_

DATABASE APPROVAL: \_\_\_\_\_ DATE: \_\_\_\_\_

AMENDMENTS

COVER SHEET

LOTUS SCHOOL ADDITION

LOTS 1 & 2 ASSEMBLY OF GOD FILING 3

AURORA

REVISIONS

NO.	DATE	DESCRIPTION

PROJ. NO.:

DATE:

DRAWN BY:

CHECKED BY:

24064

ANM

JGD

COLORADO



DRAWING NO.

SP-1



SEAL:

FOR AND ON BEHALF OF PROOF CIVIL CO.

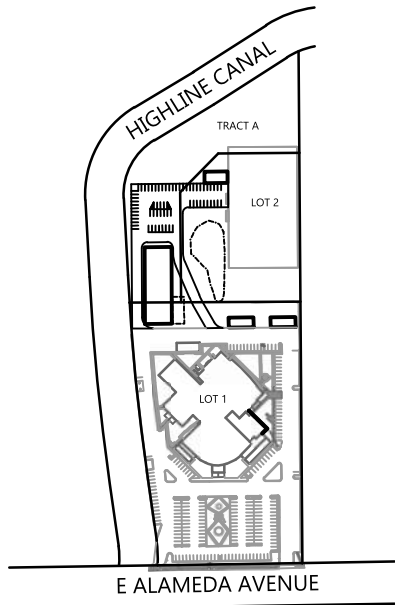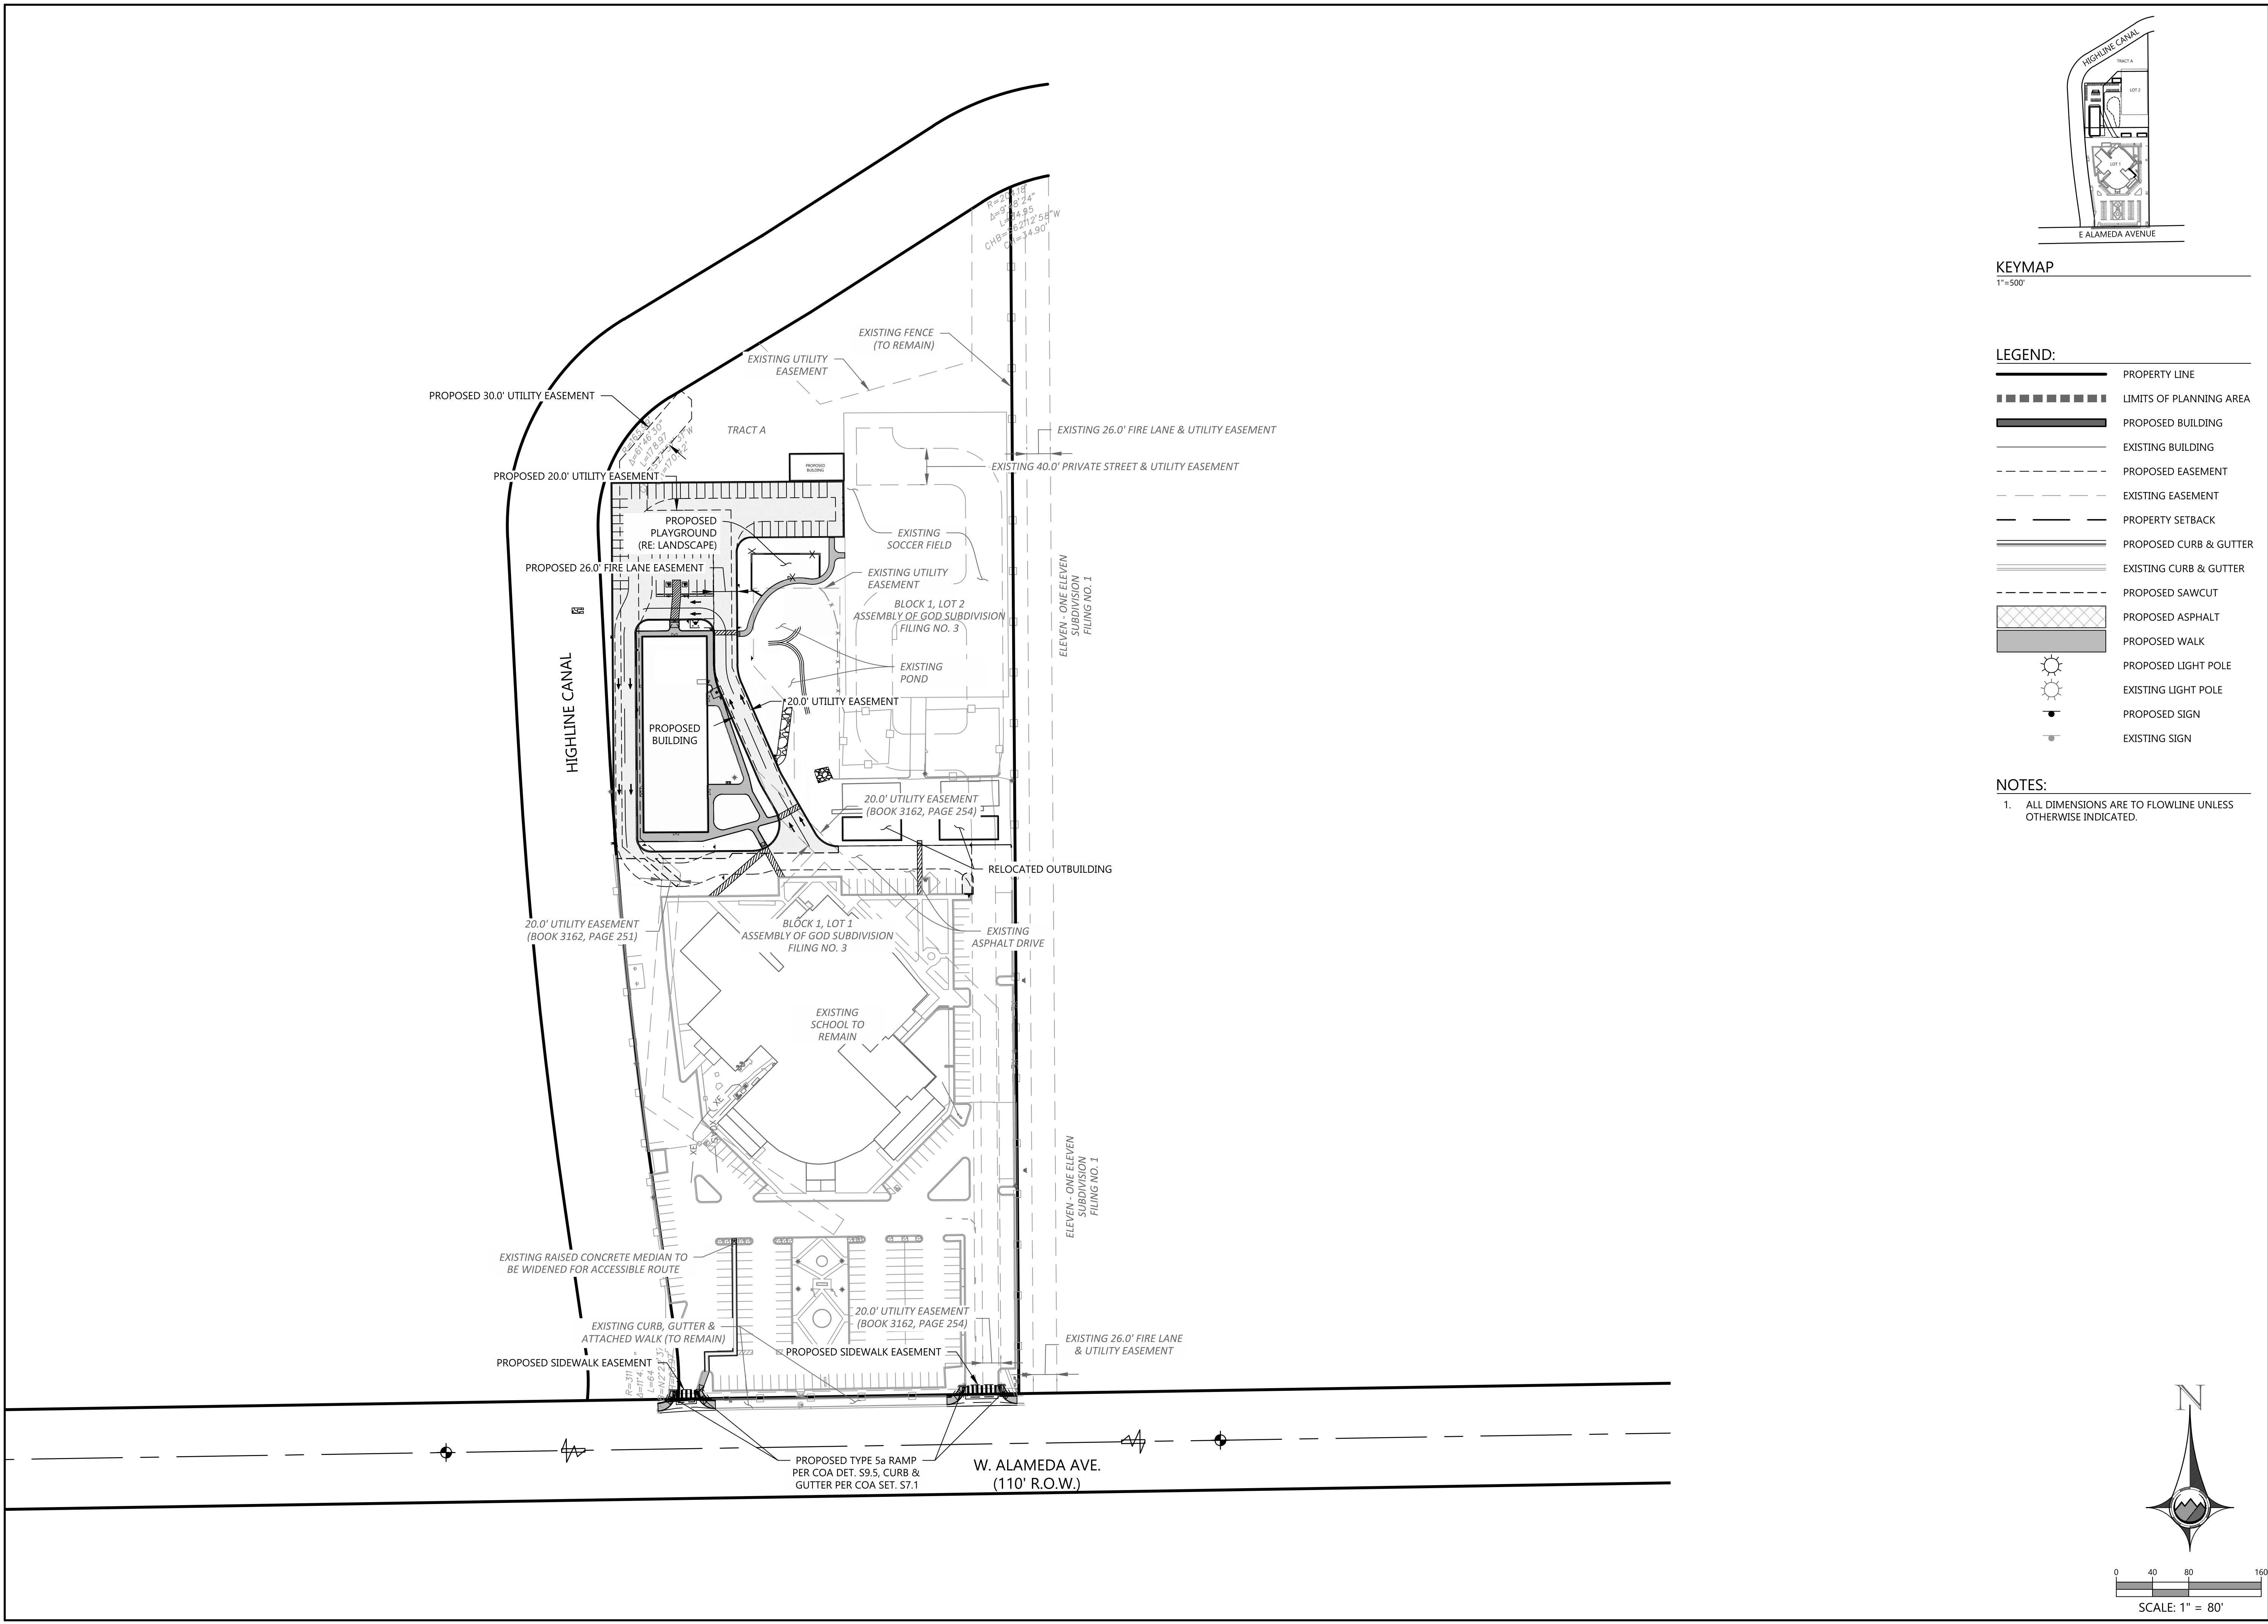

KEYMAP  
1"=500'

PROOFcivil  
consulting engineers  
600 Grant Street | Suite 210 | Denver, CO

SEAL:



FOR AND ON BEHALF OF PROOF CIVIL CO.

REVISIONS	
NO.	DESCRIPTION

PROJ. NO.: 24064	
DATE	DATE

OVERALL SITE PLAN	
LOTUS SCHOOL ADDITION	
LOTS 1 & 2 ASSEMBLY OF GOD FILING 3	
COLORADO	
AURORA	
DRAWING NO.	
SP-2	



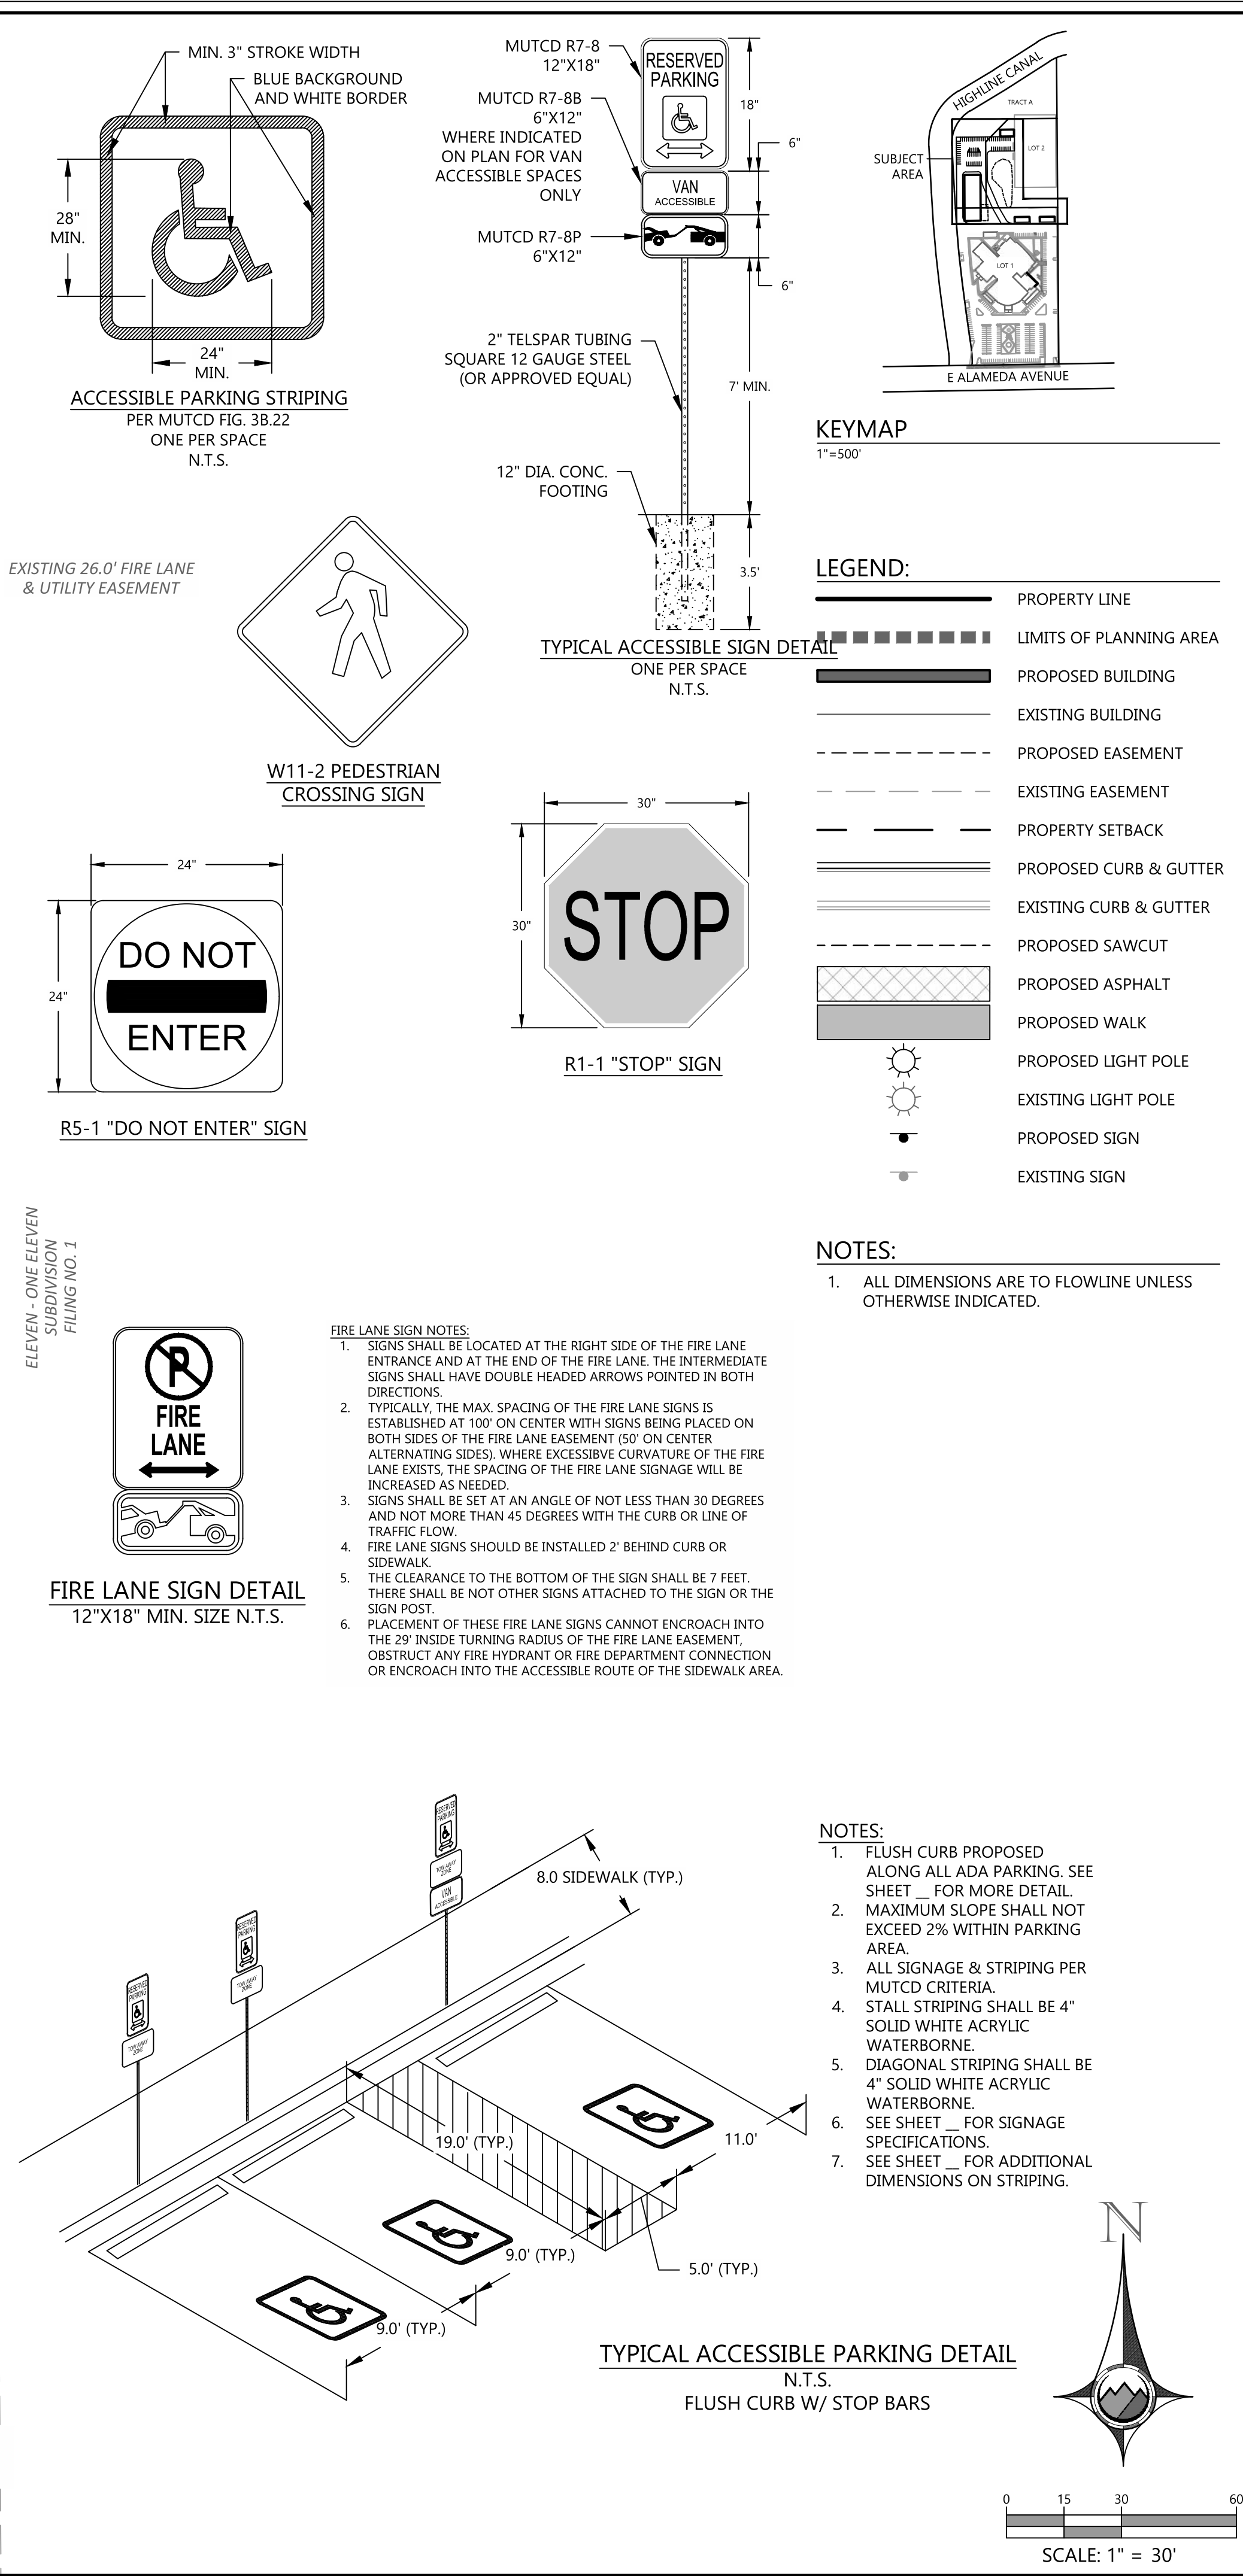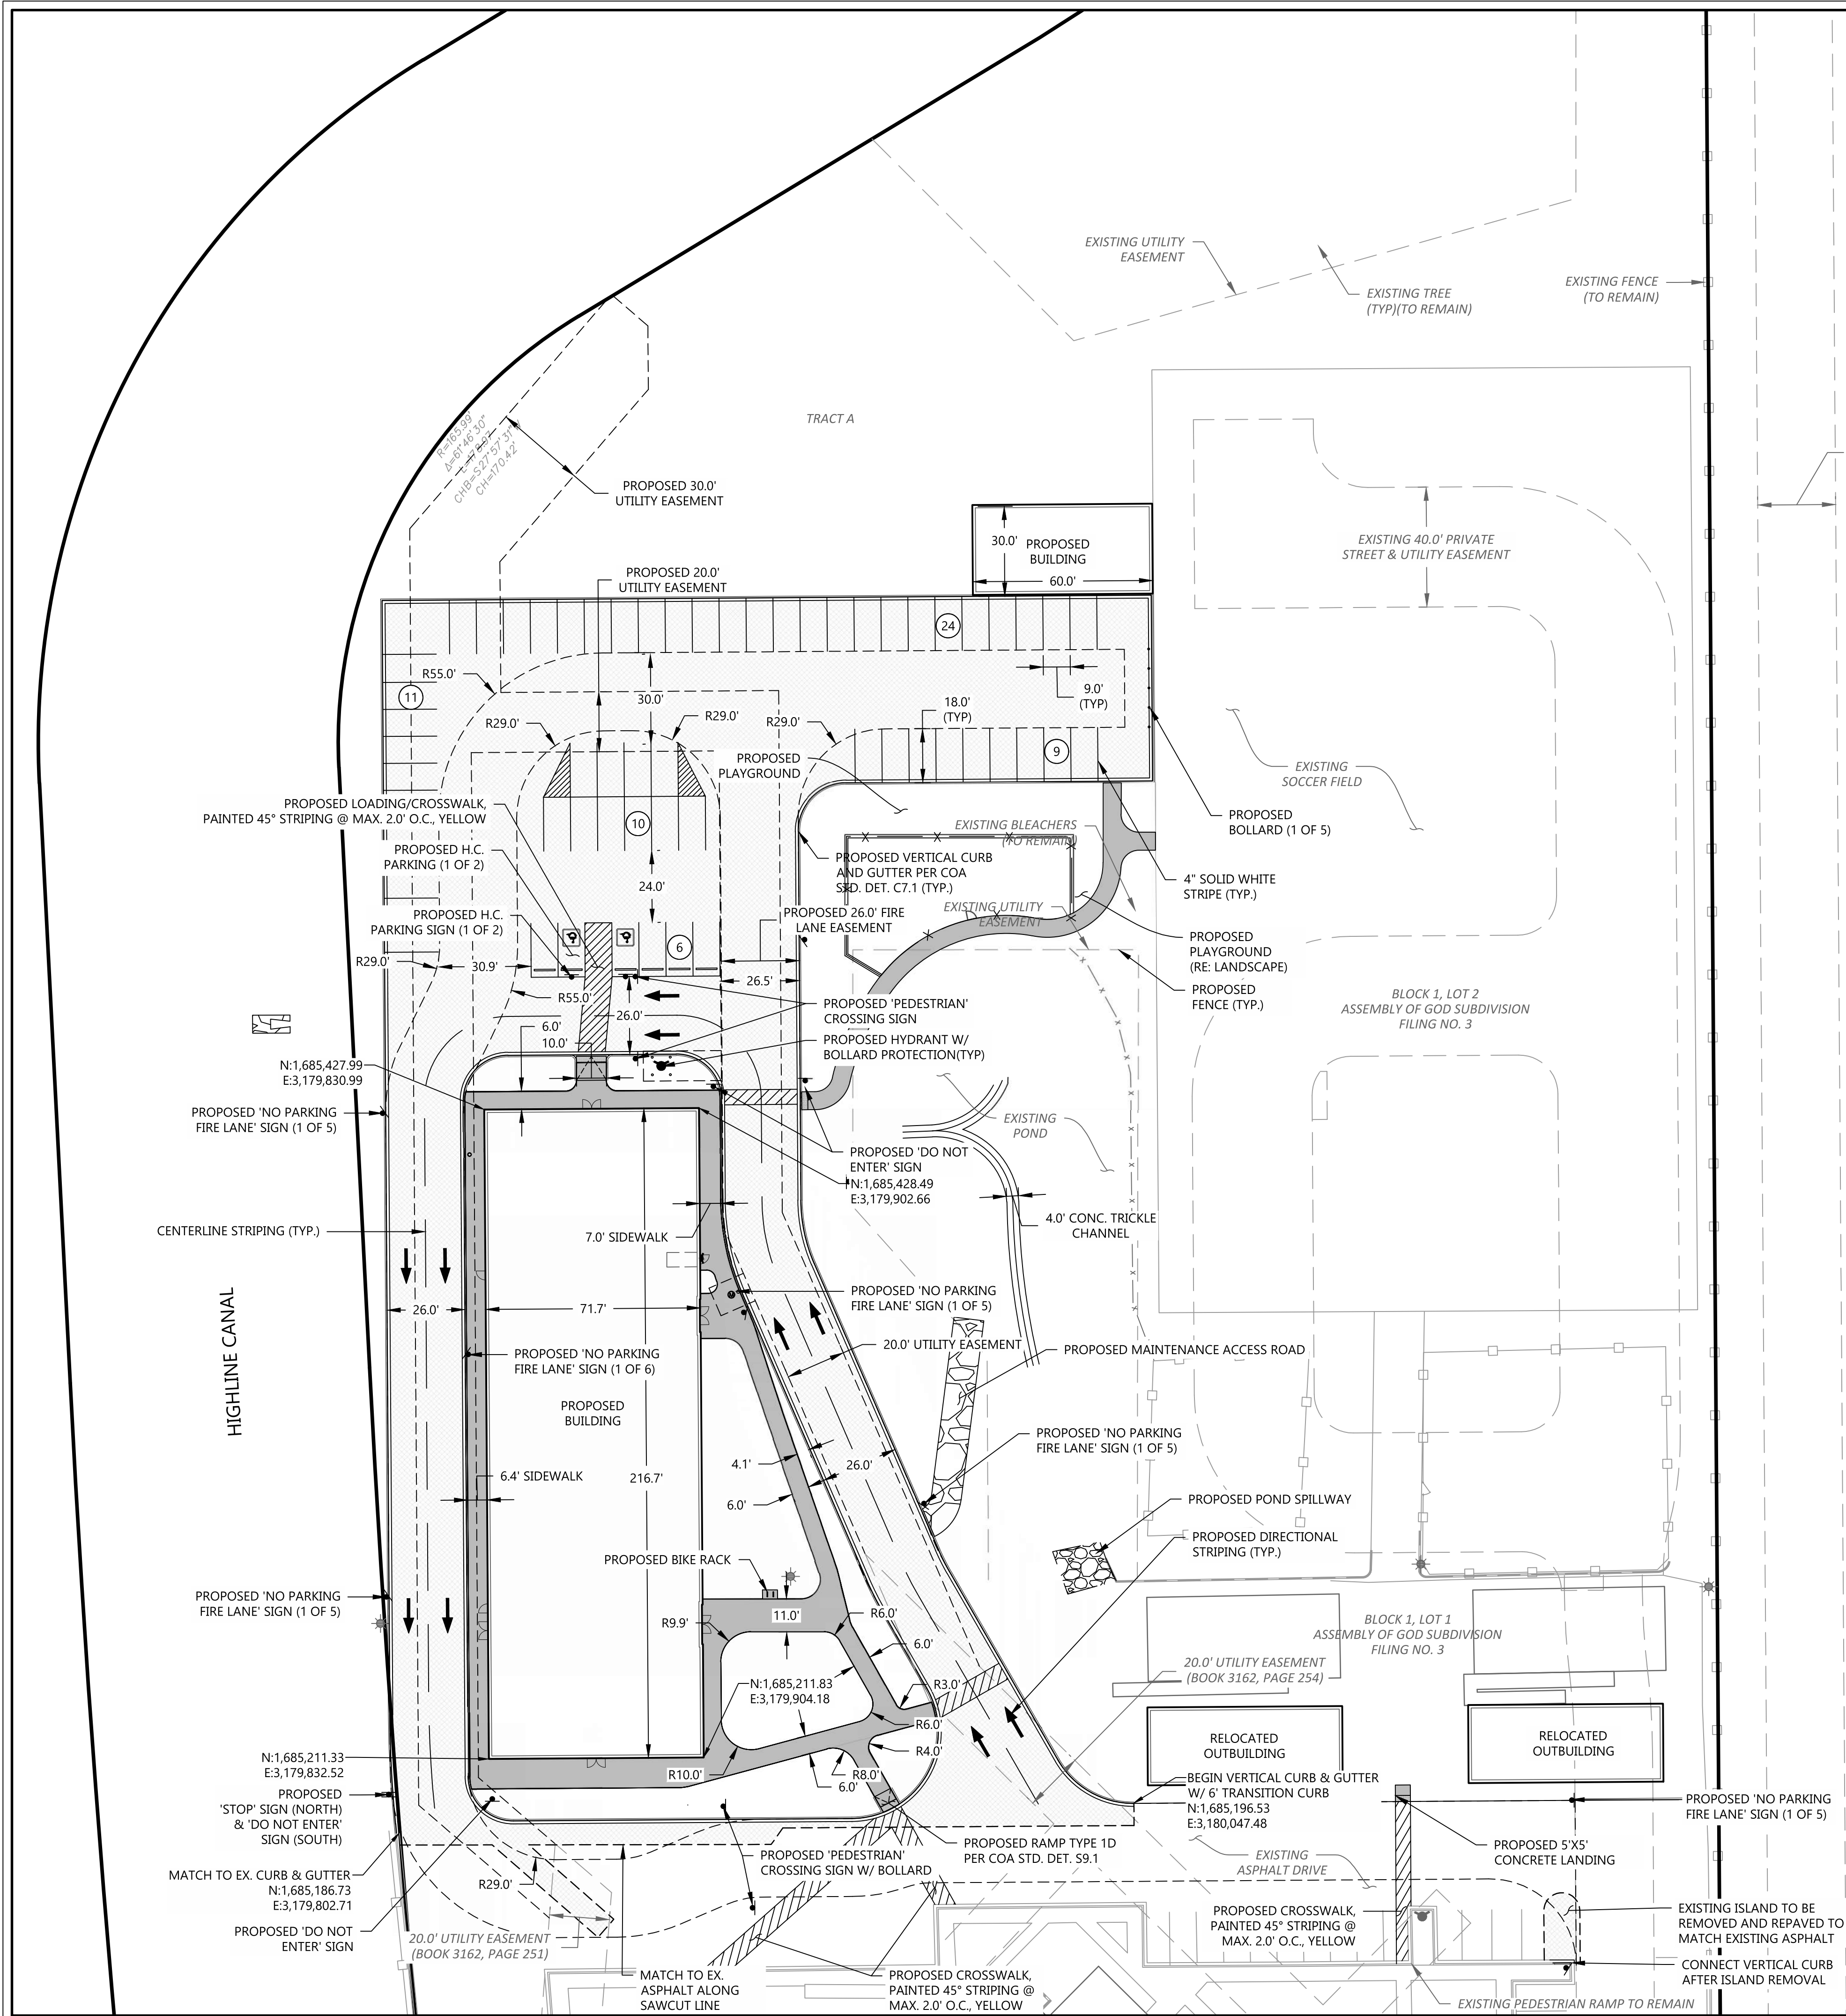

PROOF CIVIL  
consulting engineers  
600 Grant Street | Suite 210 | Denver, CO

PROOF CIVIL  
CONSULTING ENGINEERS

SEAL: [Signature]

REVISIONS	
NO.	DESCRIPTION

PROJ. NO.:	DATE:	DRAWN BY:	CHECKED BY:
24064		ANM	JGD

SITE PLAN



LOTUS SCHOOL ADDITION  
LOTS 1 & 2 ASSEMBLY OF GOD FILING 3

AURORA

DRAWING NO. SP-3





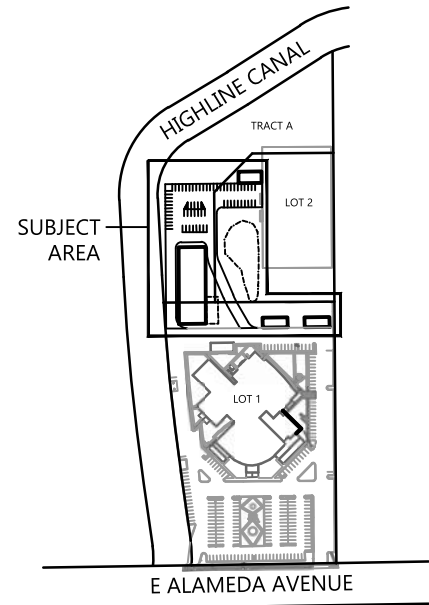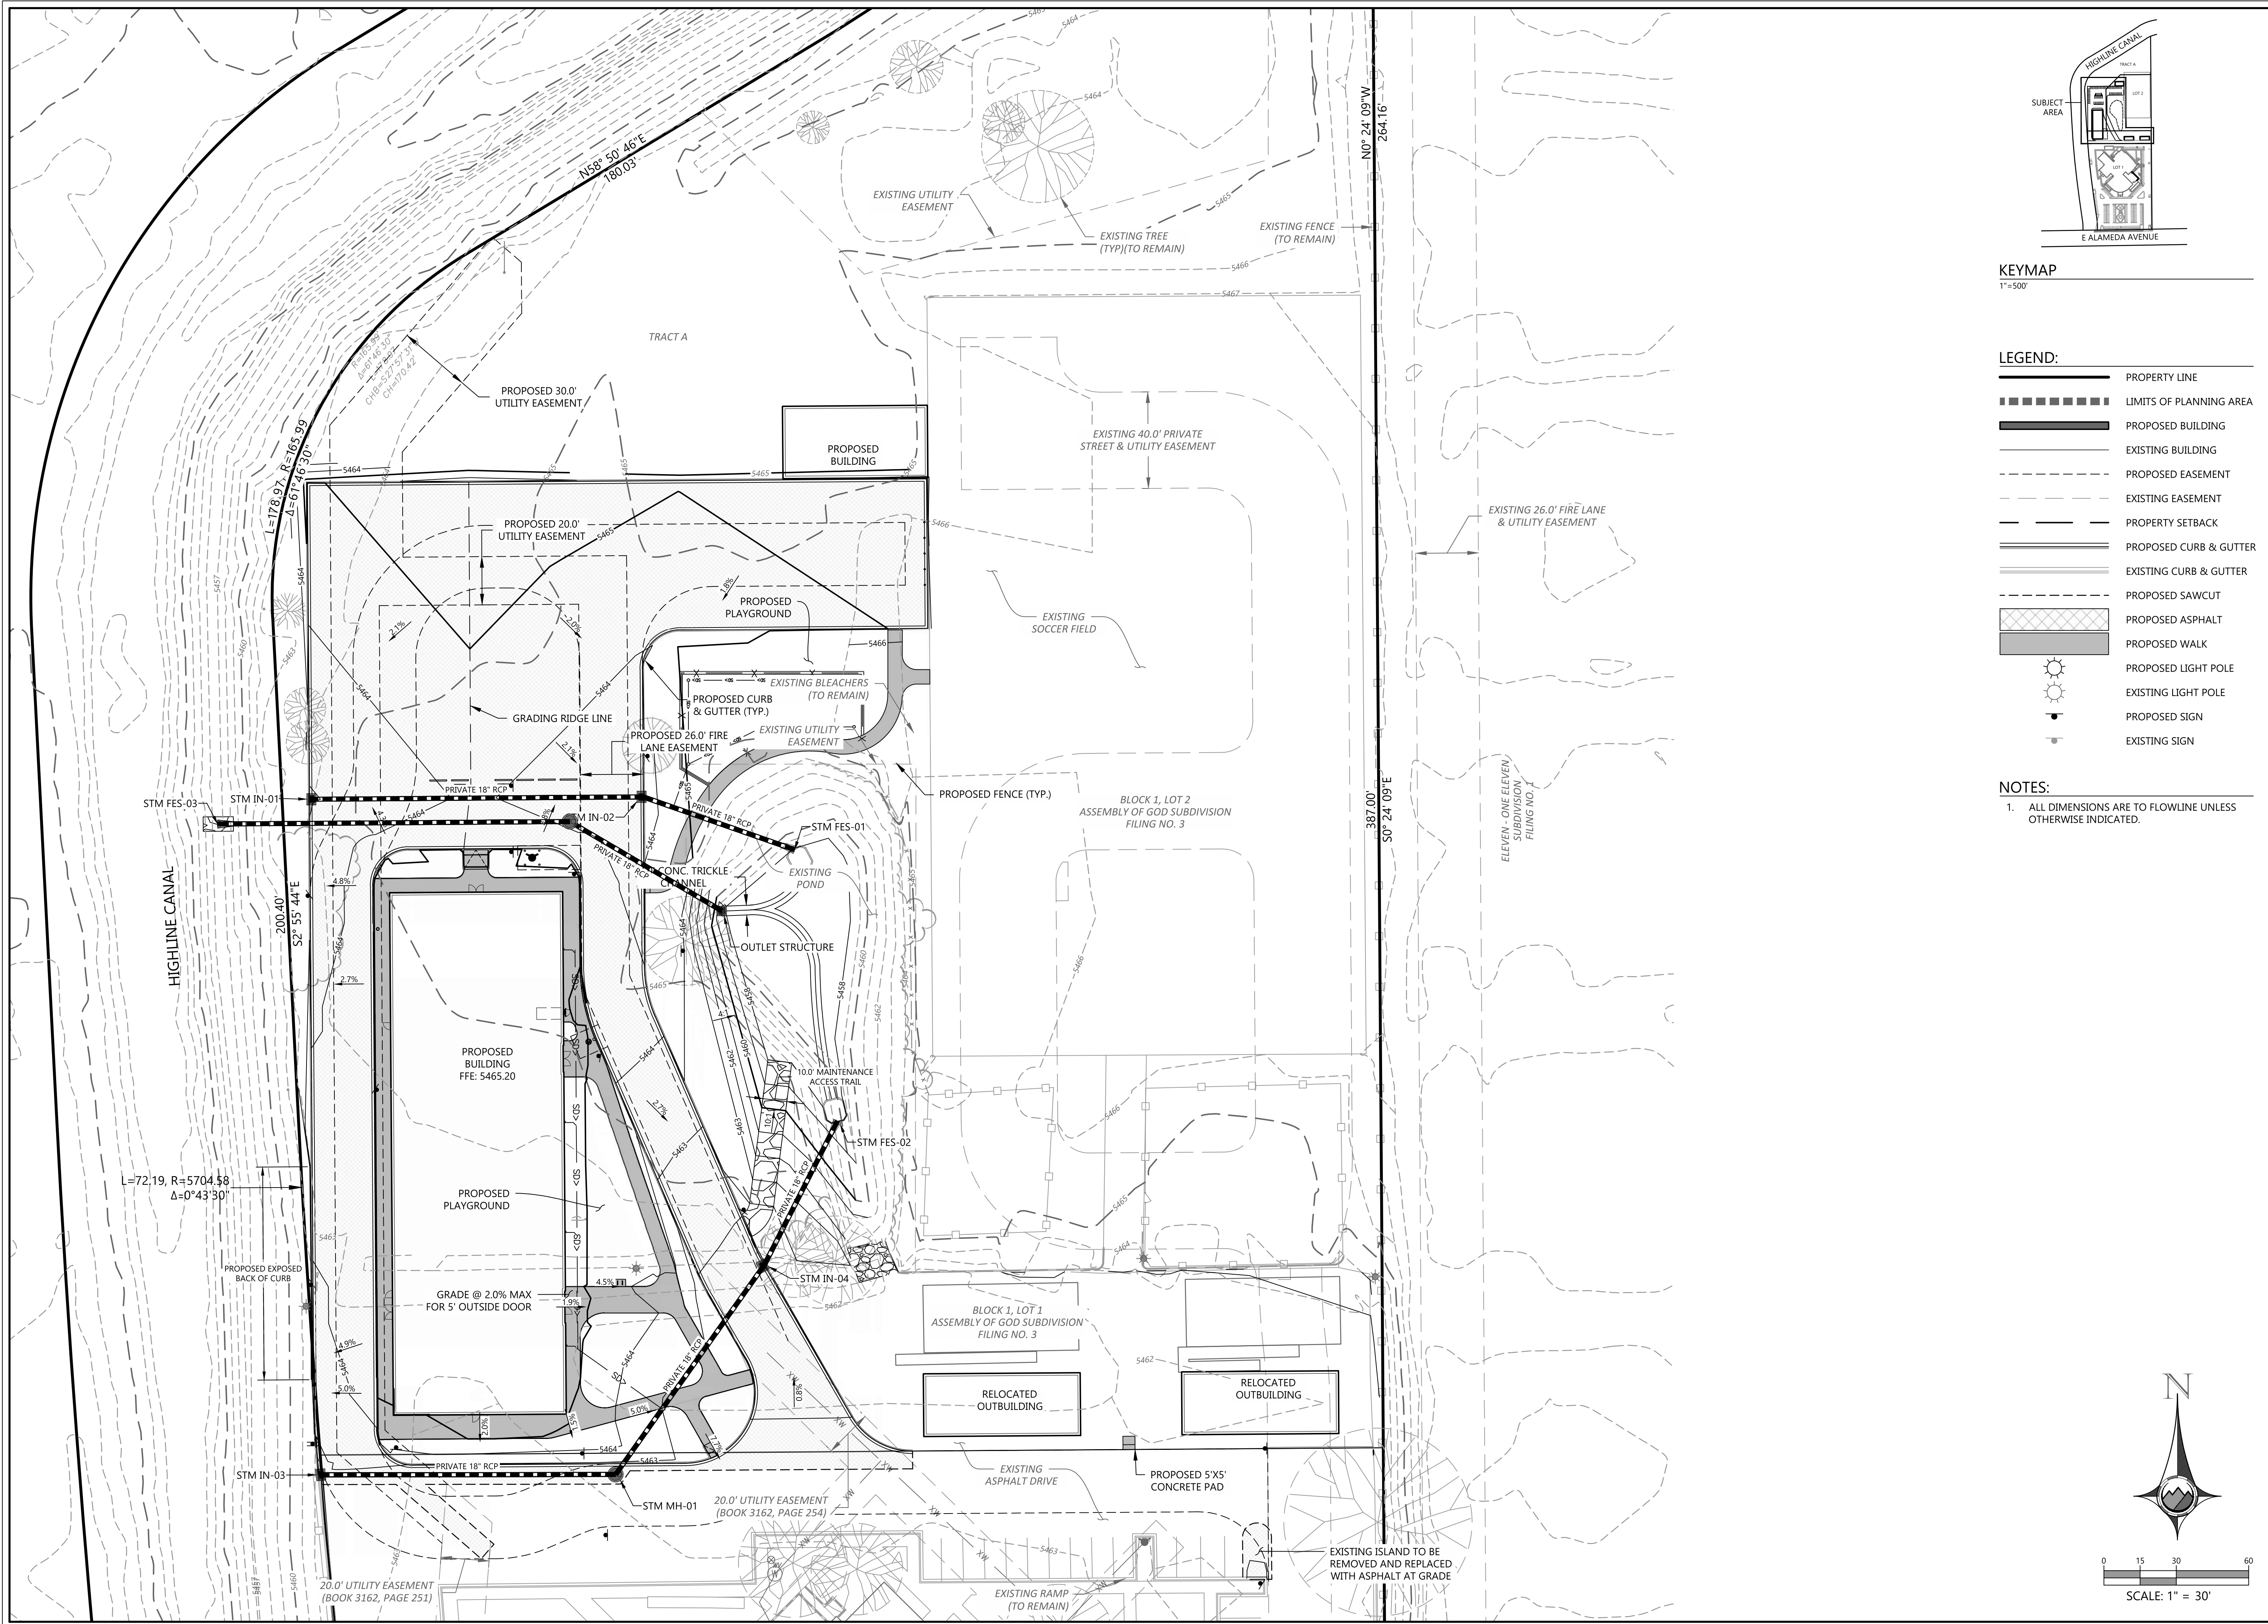


KEYMAP  
1"=500'

LEGEND:

- PROPERTY LINE
- LIMITS OF PLANNING AREA
- PROPOSED BUILDING
- EXISTING BUILDING
- PROPOSED EASEMENT
- EXISTING EASEMENT
- PROPERTY SETBACK
- PROPOSED CURB & GUTTER
- EXISTING CURB & GUTTER
- PROPOSED SAWCUT
- PROPOSED ASPHALT
- PROPOSED WALK
- PROPOSED LIGHT POLE
- EXISTING LIGHT POLE
- PROPOSED SIGN
- EXISTING SIGN

NOTES:

- ALL DIMENSIONS ARE TO FLOWLINE UNLESS OTHERWISE INDICATED.

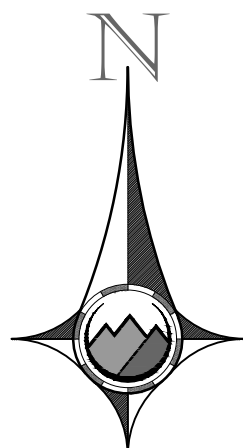

0 15 30 60  
SCALE: 1" = 30'

PROOFcivil  
consulting engineers  
600 Grant Street | Suite 210 | Denver, CO

SEAL:

FOR AND ON BEHALF OF PROOF CIVIL CO.

REVISIONS	
NO.	DESCRIPTION

PROJ. NO.:	24064
DATE:	
DRAWN BY:	ANM
CHECKED BY:	JGD

GRADING PLAN



LOTUS SCHOOL ADDITION  
LOTS 1 & 2 ASSEMBLY OF GOD FILING 3

AURORA

COLORADO

DRAWING NO.

SP-5

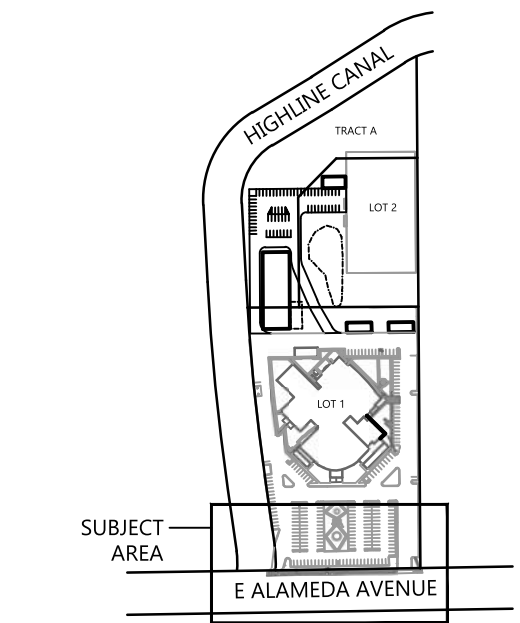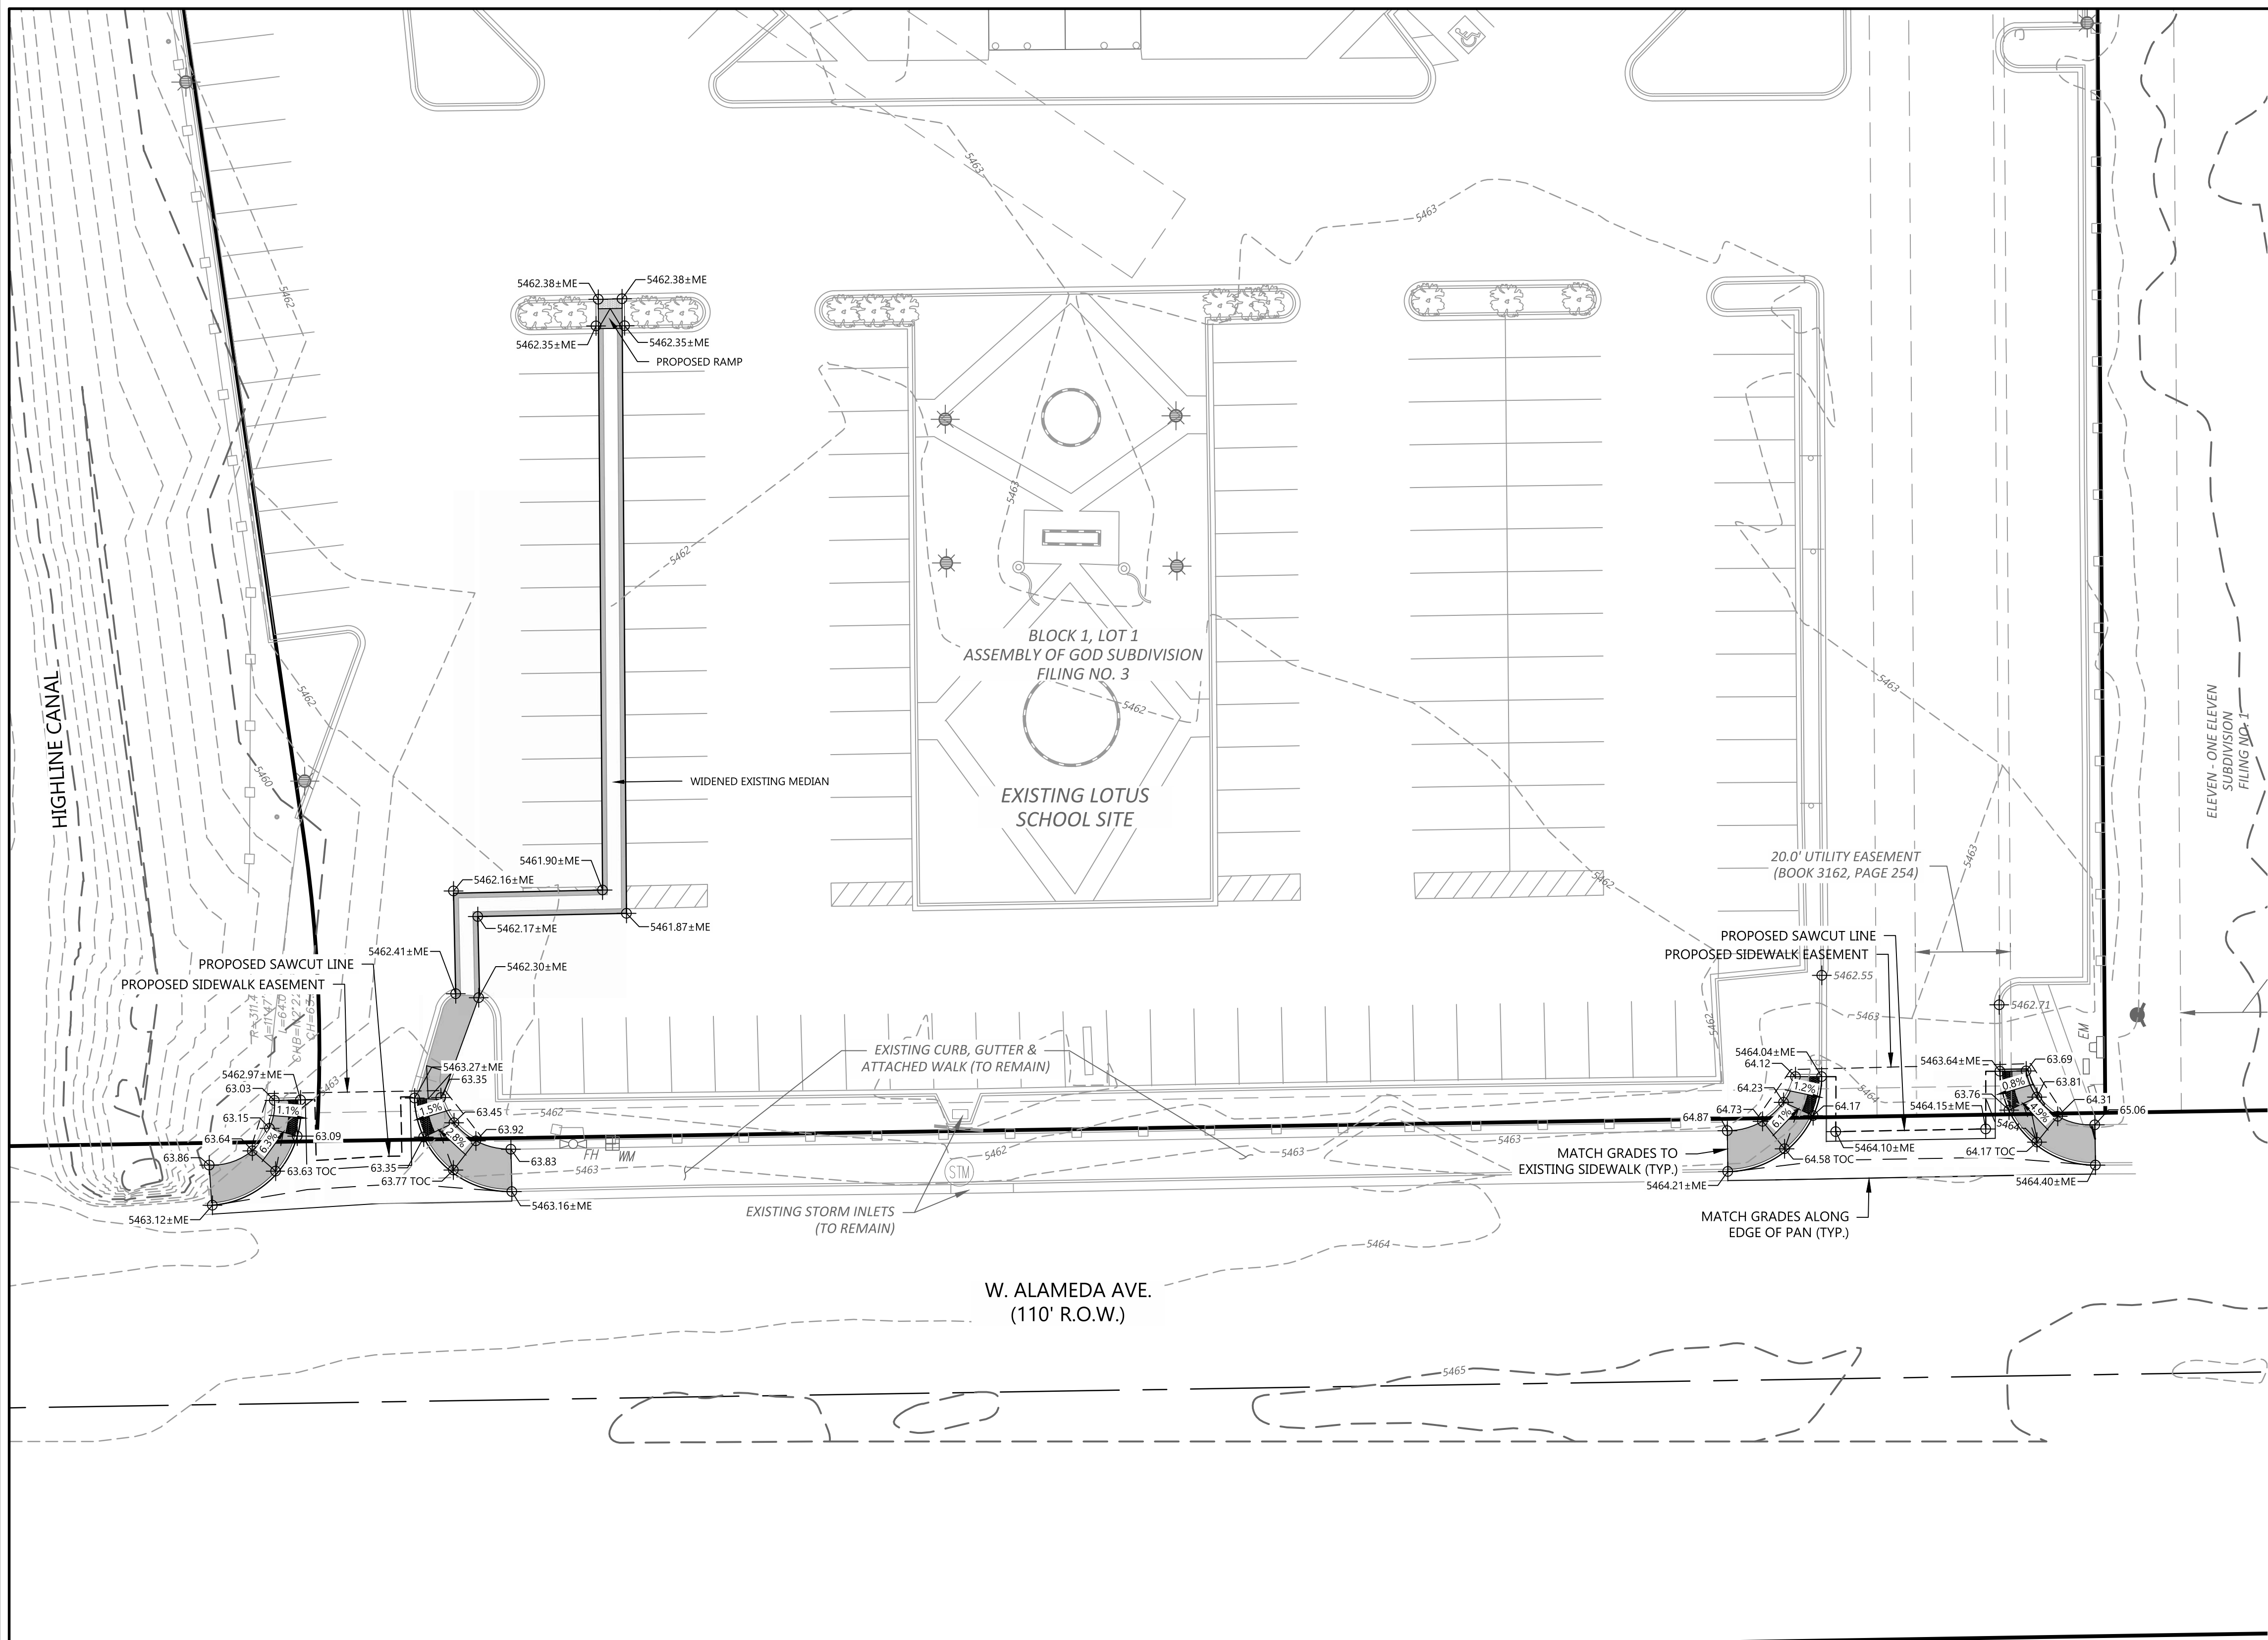


KEYMAP  
1"=500'

LEGEND:

- PROPERTY LINE
- LIMITS OF PLANNING AREA
- PROPOSED BUILDING
- EXISTING BUILDING
- PROPOSED EASEMENT
- EXISTING EASEMENT
- PROPERTY SETBACK
- PROPOSED 5' CONTOUR
- PROPOSED 1' CONTOUR
- EXISTING 5' CONTOUR
- EXISTING 1' CONTOUR
- PROPOSED STORM LINE
- EXISTING STORM LINE
- PROPOSED SAWCUT
- PROPOSED STORM INLET
- EXISTING STORM INLET
- FLOW DIRECTION
- PROPOSED SPOT GRADE
- EXISTING SPOT GRADE
- SLOPE AND DIRECTION
- HP HIGH POINT
- LP LOW POINT
- GB GRADE BREAK



NOTES:

- ALL ELEVATION SPOTS ALONG CURB INDICATE FLOWLINE ELEVATION UNLESS OTHERWISE INDICATED.
- PROPOSED ACCESSIBLE PARKING SPOTS SHALL HAVE 2.0% MAX SLOPE IN ANY DIRECTION. MINIMUM SLOPE ON UNPAVED AREAS IS 2%, MINIMUM SLOPE ON ASPHALT IS 1%, AND MINIMUM SLOPE ON CONCRETE IS 0.5%.
- THE MAXIMUM SLOPE WITHIN ROW IS 4:1, THE MAXIMUM SLOPE FOR PROPERTY OUTSIDE OF THE ROW IS 3:1.
- THE SLOPE AWAY FROM THE BUILDING SHALL HAVE A MINIMUM GRADE OF FIVE (5) PERCENT FOR THE FIRST TEN FEET OR TO THE PROPERTY LINE, WHICHEVER OCCURS FIRST, THEN A MINIMUM OF TWO (2) PERCENT UNTIL THE SLOPE REACHES THE SWALE AROUND THE BUILDING. IF PHYSICAL OBSTRUCTIONS OR LOT LINES PROHIBIT THE TEN FEET OF HORIZONTAL DISTANCE, A FIVE (5) PERCENT SLOPE SHALL BE PROVIDED TO AN APPROVED ALTERNATIVE METHOD OF DIVERTING STORM RUNOFF AWAY FROM THE FOUNDATION. IMPERVIOUS SURFACES WITHIN TEN FEET OF THE BUILDING FOUNDATION SHALL BE SLOPED A MINIMUM OF TWO (2) PERCENT AWAY FROM THE BUILDING.
- THE MAXIMUM PERMISSIBLE LONGITUDINAL GRADE FOR FIRE LANES IS 10%. THE MAXIMUM TRANSVERSE GRADE FOR A FIRE LANE IS FOUR PERCENT WITH A RESULTANT MAXIMUM SLOPE OF TEN PERCENT.
- THE RESULTANT GRADE IN ANY DIRECTION WITHIN ACCESSIBLE PARKING AREAS SHALL NOT EXCEED TWO PERCENT.
- THE MAXIMUM CROSS SLOPE IN AN ACCESSIBLE PATH SHALL NOT EXCEED TWO PERCENT. THE MAXIMUM LONGITUDINAL SLOPE ALONG AN ACCESSIBLE PATH SHALL NOT EXCEED FIVE PERCENT.

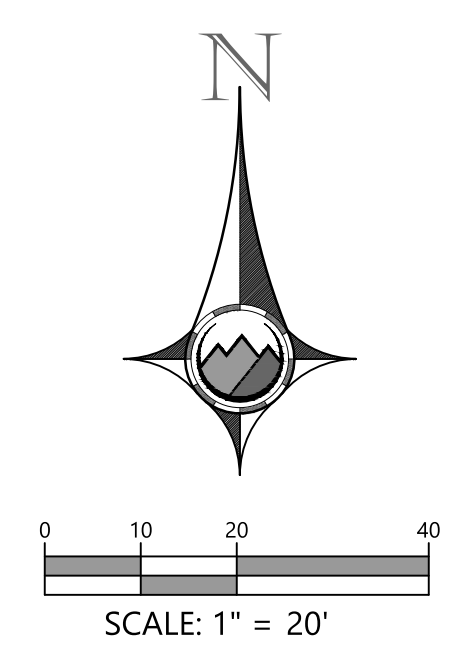

SEAL:	
FOR AND ON BEHALF OF PROOF CIVIL CO.	
REVISIONS	DESCRIPTION
	NO. DATE
PROJ. NO.: 24064	DATE
DRAWN BY: ANM	CHECKED BY: JGD



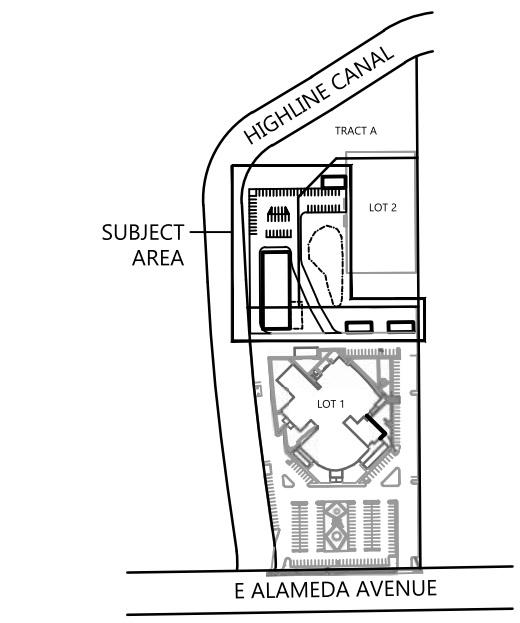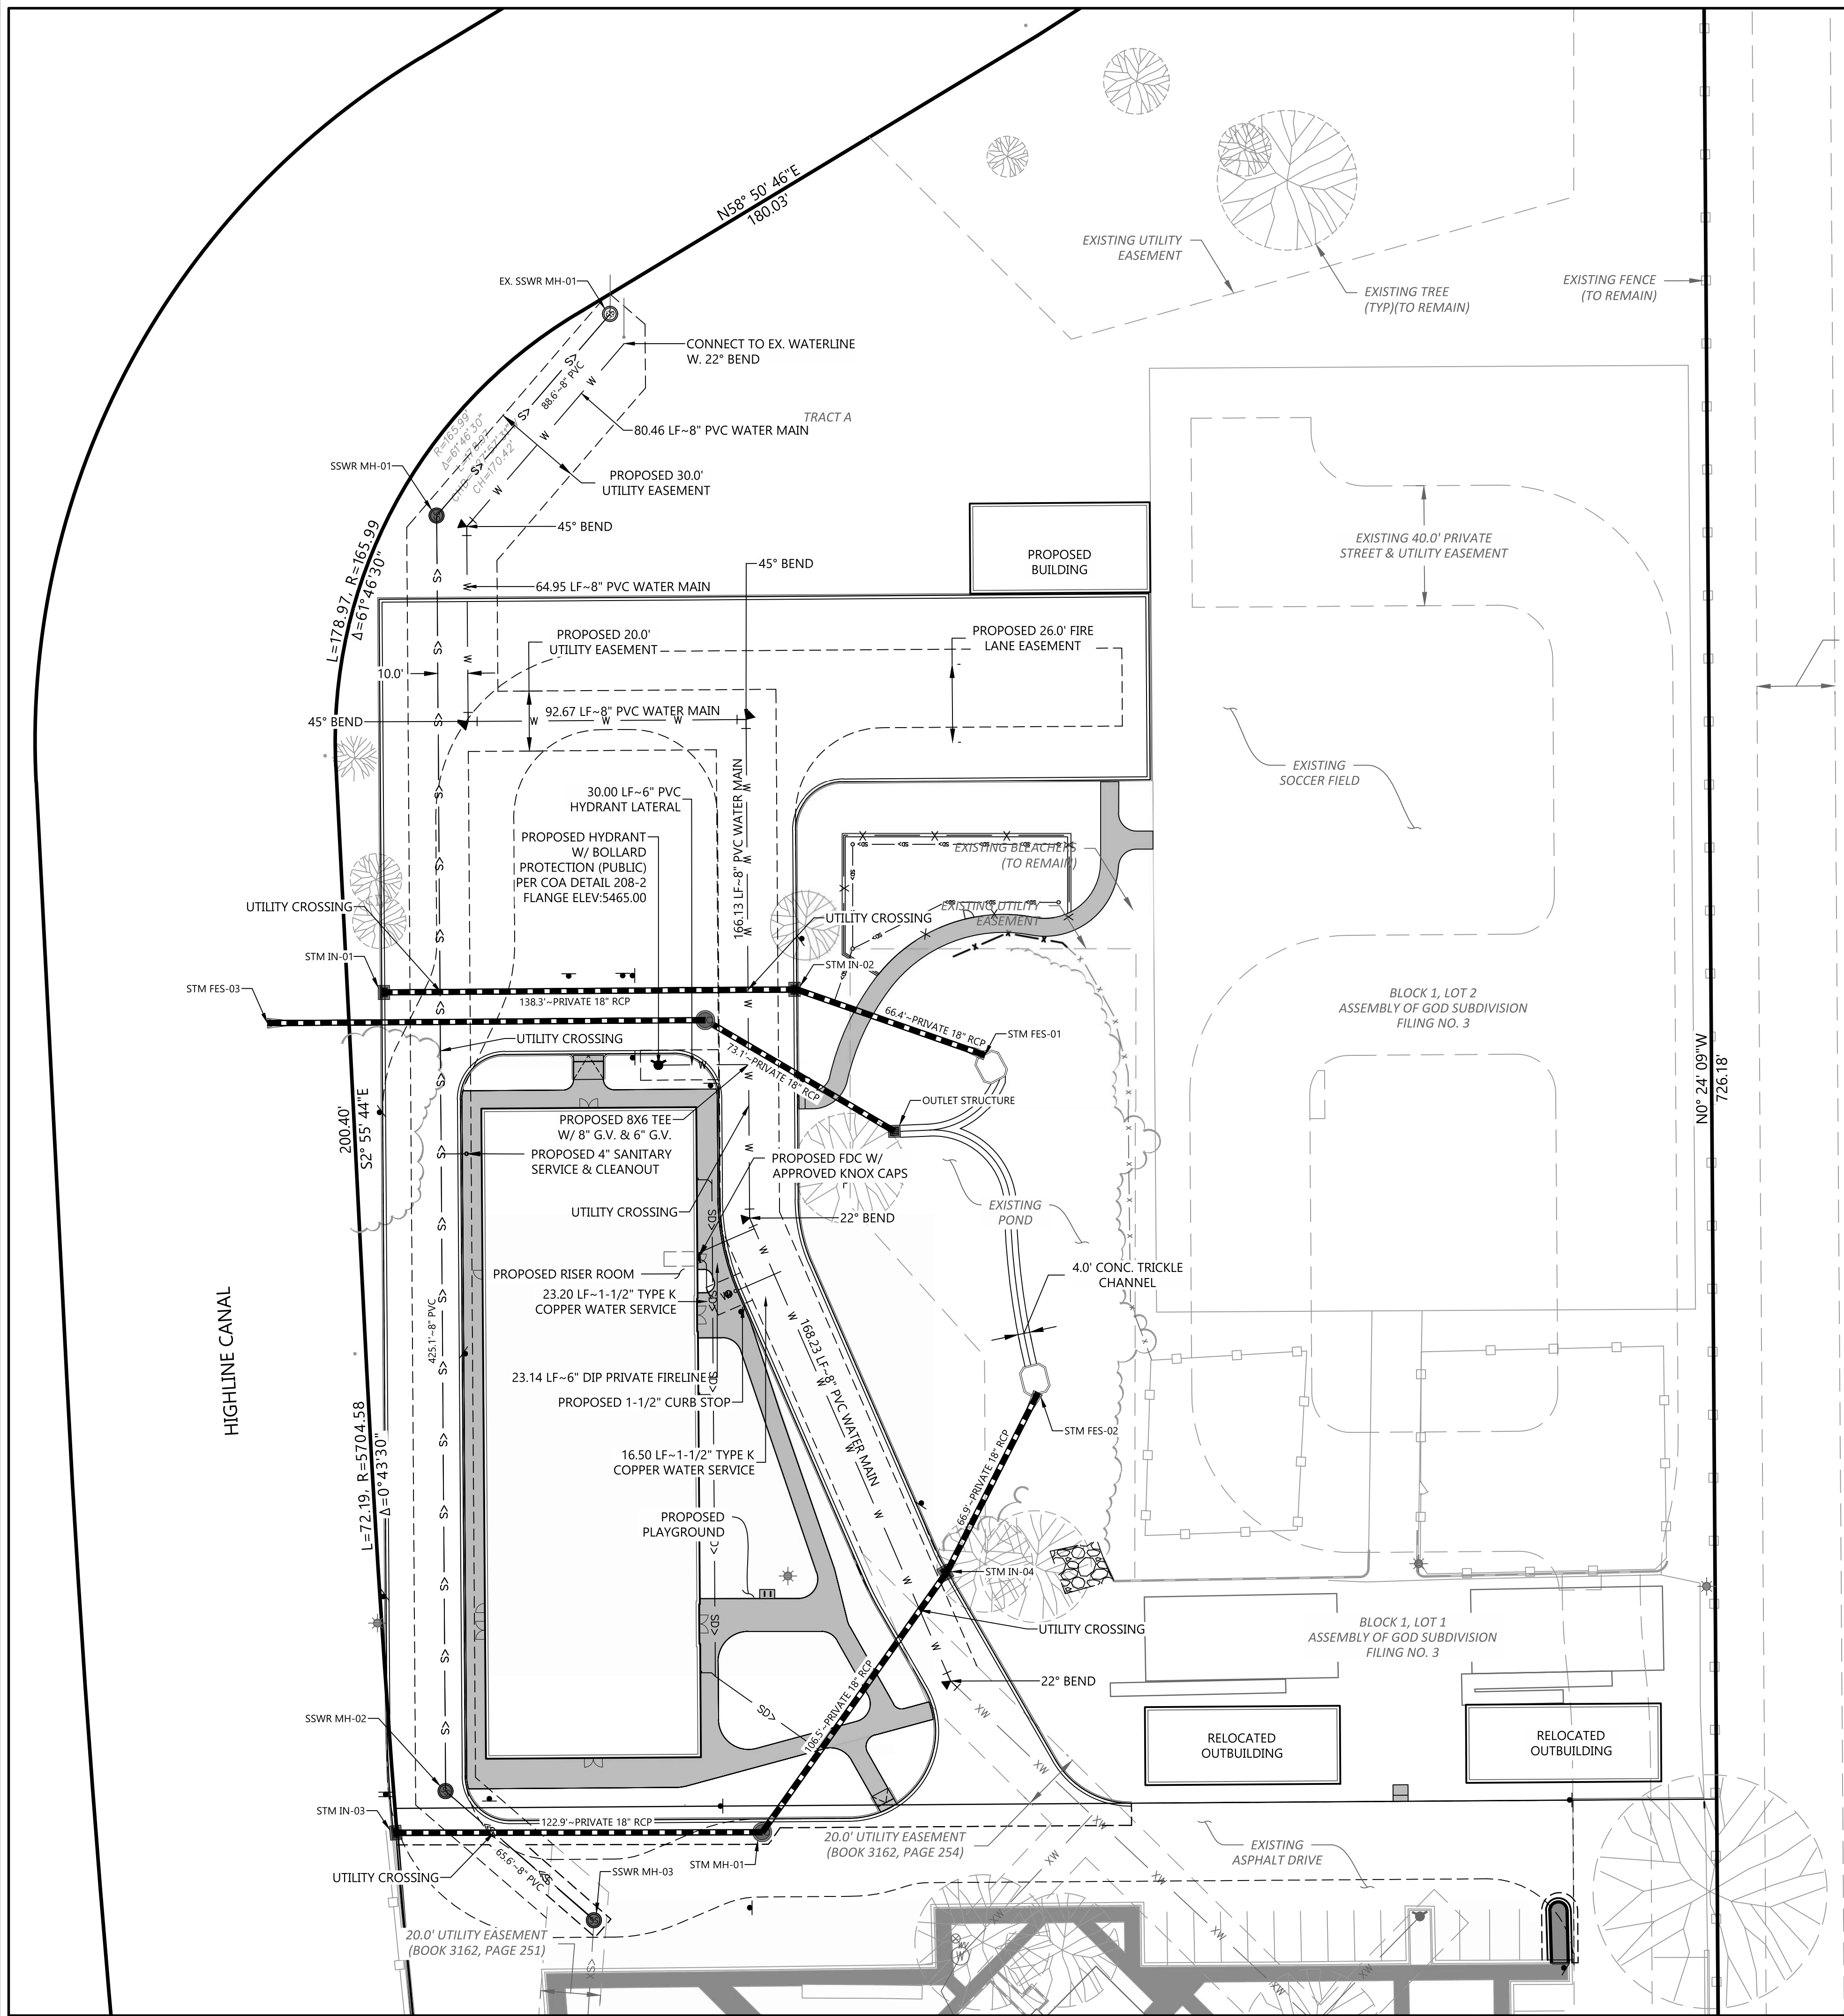


KEYMAP  
1"=500'

LEGEND:

- |  |                          |
|--|--------------------------|
|  | PROPERTY LINE            |
|  | LIMITS OF PLANNING AREA  |
|  | PROPOSED BUILDING        |
|  | EXISTING BUILDING        |
|  | PROPOSED EASEMENT        |
|  | EXISTING EASEMENT        |
|  | PROPERTY SETBACK         |
|  | PROPOSED STORM LINE      |
|  | EXISTING STORM LINE      |
|  | PROPOSED INLET           |
|  | EXISTING INLET           |
|  | PROPOSED WATER LINE      |
|  | EXISTING WATER LINE      |
|  | PROPOSED HYDRANT & VALVE |
|  | EXISTING HYDRANT & VALVE |
|  | PROPOSED SAN SEWER LINE  |
|  | EXISTING SAN SEWER LINE  |
|  | EXISTING ELECTRICAL LINE |
|  | EXISTING TELECOMM LINE   |
|  | EXISTING GAS LINE        |
|  | EXISTING IRRIGATION LINE |
|  | PROPOSED LIGHT POLE      |
|  | EXISTING LIGHT POLE      |

NOTES:

1. PROPOSED STORM SEWER IS PRIVATE AND SHALL BE MAINTAINED BY THE OWNER.

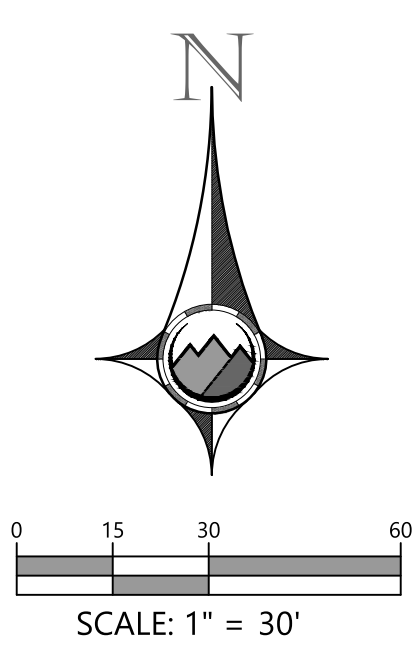

PROOFcivil

consulting engineers

600 Grant Street | Suite 210 | Denver, CO

SEAL:

FOR AND ON BEHALF OF PROOF CIVIL CO.

REVISED	
NO.	DESCRIPTION

PROJ. NO.:	DATE:	DRAWN BY:	CHECKED BY:
24064		ANM	JGD

UTILITY PLAN

LOTUS SCHOOL ADDITION

LOTS 1 & 2 ASSEMBLY OF GOD FILING 3

AURORA



COLORADO

DRAWING NO.

SP-7





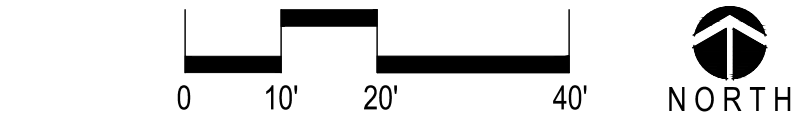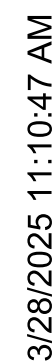






**GENERAL LANDSCAPE NOTES:**

1. PLANT QUALITY: ALL PLANT MATERIAL SHALL BE A-GRADE OR NO. 1 GRADE – FREE OF ANY DEFECTS, OF NORMAL HEALTH, HEIGHT, LEAF DENSITY AND SPREAD APPROPRIATE TO THE SPECIES AS DEFINED BY THE AMERICAN ASSOCIATION OF NURSERYMEN (AAN) STANDARDS. ALL TREES SHALL BE BALL AND BURLAP OR EQUIVALENT.
2. ALL LANDSCAPING AND PLANTS TO BE LOCATED NOT TO INTERFERE WITH EXISTING OR PROPOSED UTILITIES CONTRACTOR SHALL VERIFY LOCATION OF ALL UNDERGROUND UTILITIES, LINES AND STRUCTURES PRIOR TO EXCAVATION OR TRENCHING. DAMAGE TO THESE UTILITIES SHALL BE REPAIRED BY THE CONTRACTOR AT NO COST TO THE OWNER OR LANDSCAPE ARCHITECT.
3. PLANT QUANTITIES SHOWN FOR INFORMATION PURPOSES ONLY. CONTRACTOR TO VERIFY ALL QUANTITIES.
4. ALL TREE AND SHRUB LOCATIONS SHALL BE STAKED BY CONTRACTOR AND APPROVED BY LANDSCAPE ARCHITECT.
5. PLANT SUBSTITUTIONS WILL NOT BE PERMITTED WITHOUT APPROVAL FROM LANDSCAPE ARCHITECT.
6. PLANTS SHALL BE INSTALLED IMMEDIATELY UPON DELIVERY TO SITE, IF THIS IS NOT POSSIBLE, PLANTS SHALL BE HEELED IN AND WATERED TO PREVENT DEHYDRATION.
7. SOIL AMENDMENT:
  - SHRUB AND PLANTING BEDS - 4" OF COMPOST TILLED INTO 6" OF EXISTING SOIL.
  - ACCEPTABLE PRODUCT: CLASS I COMPOST. COMPOSTED MATERIAL SHALL CONSIST OF AGED ORGANIC MATTER, FREE OF WEED OR OTHER NOXIOUS PLANT SEEDS, LUMPS, STONES, OR OTHER FOREIGN CONTAMINANTS HARMFUL TO PLANT LIFE, AND HAVING THE FOLLOWING CHARACTERISTICS BASED ON A NUTRIENT TEST PERFORMED NO LONGER THAN 3 MONTHS PRIOR TO ITS INCORPORATION INTO THE PROJECT:
    - A. ORGANIC MATTER: 25% MINIMUM.
    - B. SALT CONTENT: 5.0 MMHOS/CM MAXIMUM
    - C. PH: 7.5 MAXIMUM.
    - D. CARBON TO NITROGEN RATIO OF 10:1 TO 20:1
9. ALL LANDSCAPED AREAS AND PLANT MATERIAL, EXCEPT FOR NON-IRRIGATED NATIVE, RESTORATIVE, AND DRYLAND GRASS AREAS THAT COMPLY WITH REQUIREMENTS FOUND IN SEC. 146-1429 AND/OR SEC. 146-1435 MUST BE WATERED BY AN AUTOMATIC UNDERGROUND IRRIGATION SYSTEM. IRRIGATION SYSTEM DESIGN, INSTALLATION, OPERATION, AND MAINTENANCE SHALL CONFORM TO REQUIREMENTS FOUND IN THE CITY OF AURORA IRRIGATION ORDINANCE.
10. SOD TO BE REPLACED OVER ALL TRENCHED IRRIGATION LINES.
11. INSTALL 4" OF ORGANIC WOOD MULCH IN EXISTING PLANTING BEDS AND TREE PLANTING PITS THAT HAVE BEEN DISTURBED OR ENLARGED. MULCH TO MATCH EXISTING.
12. ALL DAMAGED OR DEAD PLANT MATERIAL TO BE REPLACED. CONTRACTOR TO PROVIDE WATER THROUGHOUT CONSTRUCTION PERIOD.
13. THE FOLLOWING SEPARATIONS SHALL BE PROVIDED BETWEEN TREES/SHRUBS AND UTILITIES:
  - 40 FEET BETWEEN CANOPY TREES AND STREET LIGHTS
  - 15 FEET BETWEEN ORNAMENTAL TREES AND STREETLIGHTS
  - 10 FEET BETWEEN TREES AND PUBLIC WATER, SANITARY AND STORM SEWER MAIN LINES
  - 6 FEET BETWEEN TREES AND PUBLIC WATER, SANITARY AND STORM SEWER SERVICE LINES.
  - 4 FEET BETWEEN SHRUBS AND PUBLIC WATER AND SANITARY AND STORM SEWER LINES
  - 4 FEET BETWEEN TREES AND GAS LINES
14. ALL STREET TREES SHALL BE PLACED A MINIMUM EIGHT (8) FEET AWAY FROM THE EDGES OF DRIVEWAYS.
15. PLACEMENT OF ALL LANDSCAPING SHALL BE IN ACCORDANCE WITH THE SIGHT DISTANCE CRITERIA AS SPECIFIED BY CHERRY HILLS VILLAGE. NO STRUCTURES OR LANDSCAPE ELEMENTS GREATER THAN 24" SHALL BE ALLOWED WITHIN THE SIGHT DISTANCE TRIANGLE OR EASEMENTS WITH THE EXCEPTION OF DECIDUOUS TREES PROVIDED THAT THE LOWEST BRANCH IS AT LEAST 6' FROM GRADE. ANY FENCES WITHIN THE SIGHT DISTANCE TRIANGLE OR EASEMENT MUST BE NOT MORE THAN 42" IN HEIGHT AND OF AN OPEN DESIGN.
16. THE FINAL LANDSCAPE PLAN SHALL BE COORDINATED WITH ALL OTHER FINAL PLAN ELEMENTS SO THAT THE PROPOSED GRADING, STORM DRAINAGE, AND OTHER DEVELOPMENT IMPROVEMENTS DO NOT CONFLICT WITH NOR PRECLUDE INSTALLATION AND MAINTENANCE OF LANDSCAPE ELEMENTS ON THIS PLAN.
17. MINOR CHANGES IN SPECIES AND PLANT LOCATIONS MAY BE MADE DURING CONSTRUCTION – AS REQUIRED BY SITE CONDITIONS OR PLANT AVAILABILITY. OVERALL QUANTITY, QUALITY, AND DESIGN CONCEPT MUST BE CONSISTENT WITH THE APPROVED PLANS. IN THE EVENT OF CONFLICT WITH THE QUANTITIES INCLUDED IN THE PLANT LIST, SPECIES AND QUANTITIES ILLUSTRATED SHALL BE PROVIDED. ALL CHANGES OF PLANT SPECIES AND LOCATION MUST HAVE WRITTEN APPROVAL BY THE CITY PRIOR TO INSTALLATION.
18. ALL PLANTING BEDS SHALL BE MULCHED TO A MINIMUM DEPTH OF THREE INCHES.

TREES						
SYMBOL	CODE	QTY	BOTANICAL / COMMON NAME	CONT	O.C	WATER USE
	AG	2	Acer grandidentatum / Bigtooth Maple	B&B	1.5'	Low - Medium
DECIDUOUS SHRUBS						
	CB	10	Caryopteris x clandonensis 'Blue Mist' / Blue Mist Bluebeard	5 gal.		Low - Medium
	CM	7	Chamaebatiaria millefolium / Fernbush	5 gal.		Very low - Low
	CS	6	Cytisus purgans 'Spanish Gold' / Spanish Gold Broom	5 gal.		Very low - Medium
	EN	12	Ericameria nauseosa / Rubber Rabbitbrush	5 gal.		Very low - Low
	PG	7	Potentilla fruticosa 'Goldfinger' / Goldfinger Bush Cinquefoil	5 gal.		Medium
	PP	10	Prunus besseyi 'P011S' / Pawnee Buttes® Sand Cherry	5 gal.		Low
	PB	3	Prunus pumila besseyi / Western Sand Cherry	5 gal.		Low
	PT	11	Prunus tomentosa / Nanking Cherry	5 gal.		Medium
	RG	13	Rhus aromatica 'Gro-Low' / Gro-Low Fragrant Sumac	5 gal.		Very low - Medium

ORNAMENTAL GRASS					
	BG	82	Bouteloua gracilis / Blue Grama Grass	1 gal.	Low
	CA	33	Calamagrostis x acutiflora / Feather Reed Grass	1 gal.	Medium
	SL	23	Schizachyrium scoparium / Little Bluestem	1 gal.	Very Low - Low
	SH	44	Sporobolus heterolepis / Prairie Dropseed	1 gal.	Low

PERENNIAL						
	AM	23	Achillea x 'Moonshine' / Moonshine Yarrow	1 gal.		Low
	AC	11	Aquilegia caerulea / Rocky Mountain Columbine	1 gal.		Medium
	EM	12	Echinacea purpurea 'Magnus' / Magnus Purple Coneflower	1 gal.		Low - Medium
	GA	9	Gaillardia aristata / Blanket Flower	1 gal.		Low - Medium
	NW	15	Nepeta x faassenii 'Walker's Low' / Walker's Low Catmint	1 gal.		Low - Medium
	PS	3	Penstemon strictus / Rocky Mountain Penstemon	1 gal.		Low
	RC	4	Ratibida columnifera / Prairie Coneflower	1 gal.		Low - Medium
	RA	5	Rudbeckia amplexicaulis / Black-eyed Susan	1 gal.		High

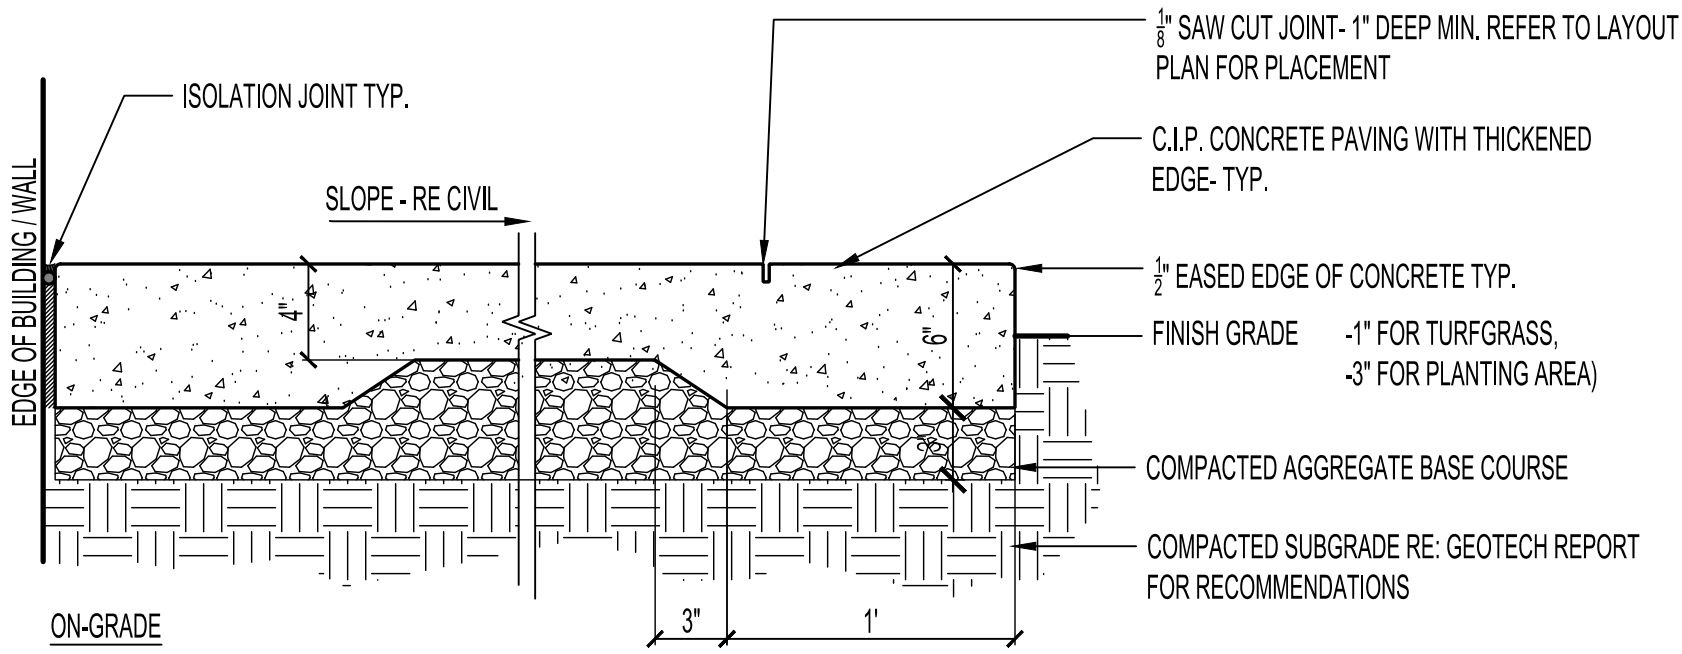


NOTES:

1. REFERENCE PLANS & SPECIFICATIONS FOR COLOR AND/OR FINISH
2. REFER TO SPECS FOR CONCRETE STRENGTH AND REINFORCEMENT REQ.
3. REFER TO PLANS FOR EXPANSION JOINT LOCATIONS
4. REFER TO PLANS FOR CONTROL JOINT LOCATIONS. CONTROL JOINTS ARE TO BE MAX. 2x THE THICKNESS OF THE CONCRETE.
5. PROVIDE ISOLATION JOINTS AT ALL WALLS AND BUILDINGS TYP.
6. CONCRETE SHALL HAVE A MAXIMUM 1.8% AND A MINIMUM OF 1% CROSS SLOPE.

A CONCRETE PAVING - PEDESTRIAN

Scale: 1/2" = 1'-0"

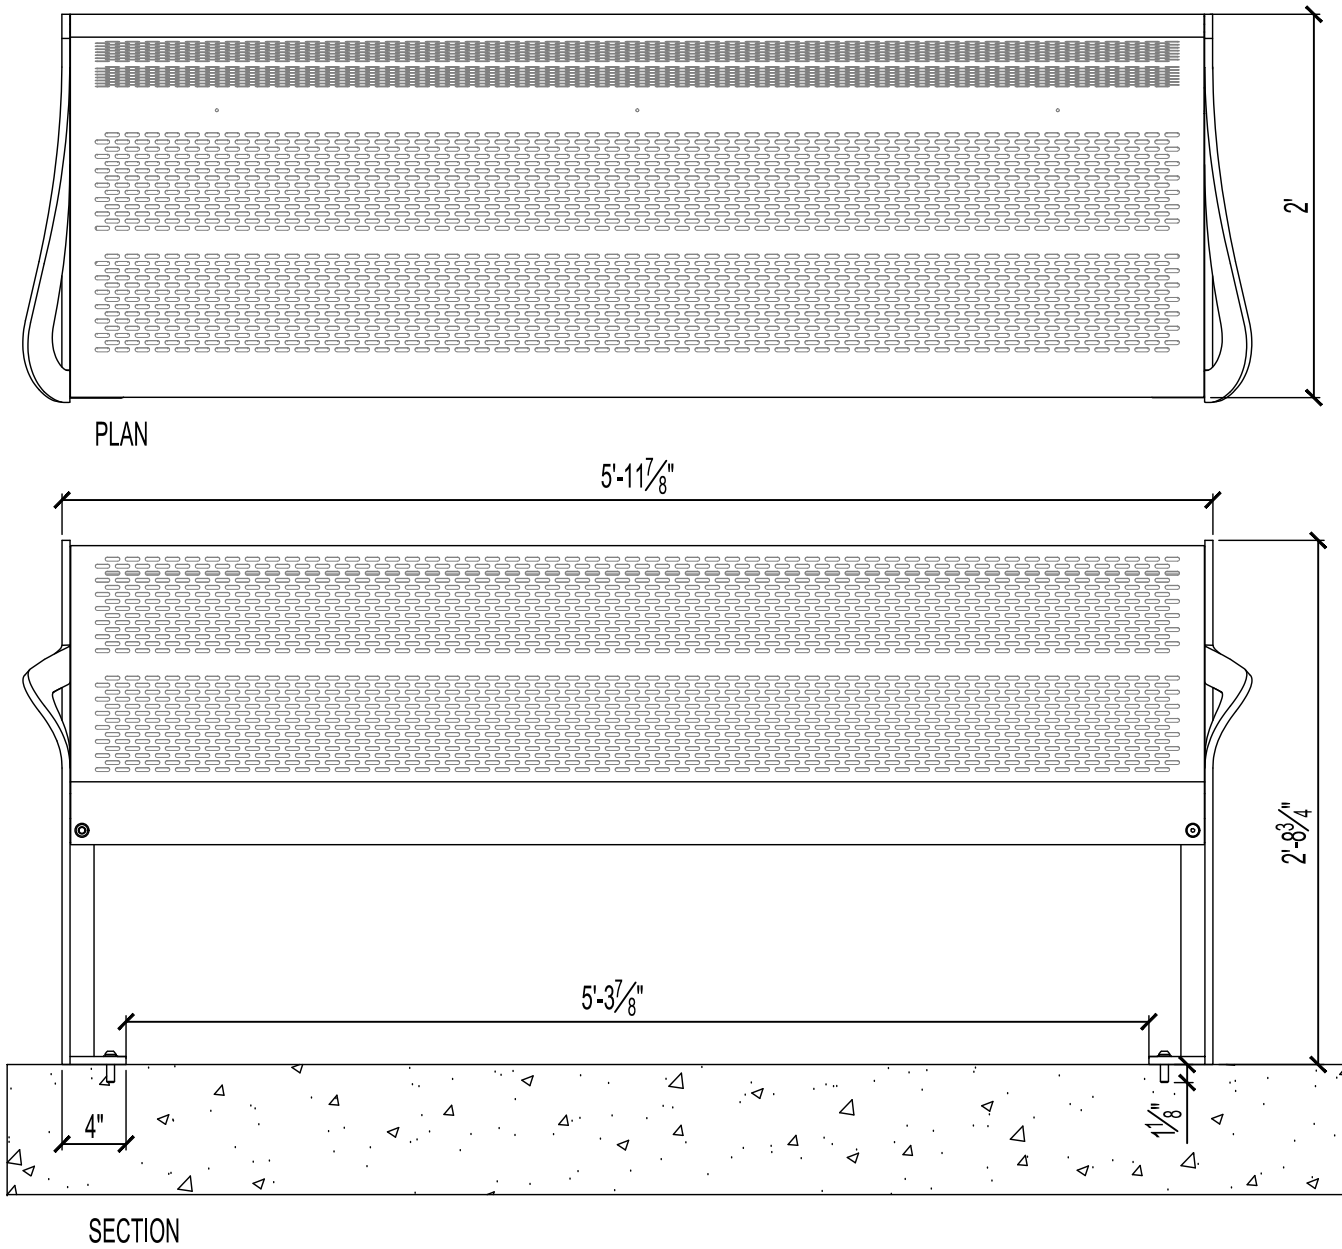


MANUFACTURER: LANDSCAPE FORMS  
PRODUCT: RATIO BENCH

MATERIALS: STAINLESS STEEL  
FINISHES: POWDER COAT SILVER TEXTURE ON ARM RESTS  
DIMENSIONS: 77" L X 24.25" W X 32" TALL  
MOUNTING: SURFACE MOUNT. PROVIDE THREADED ANCHORS AND STAINLESS STEEL MOUNTING HARDWARE.

D FIXED BENCH TYPE 1- RATIO BENCH - BACKED

Scale: 1" = 1'-0"

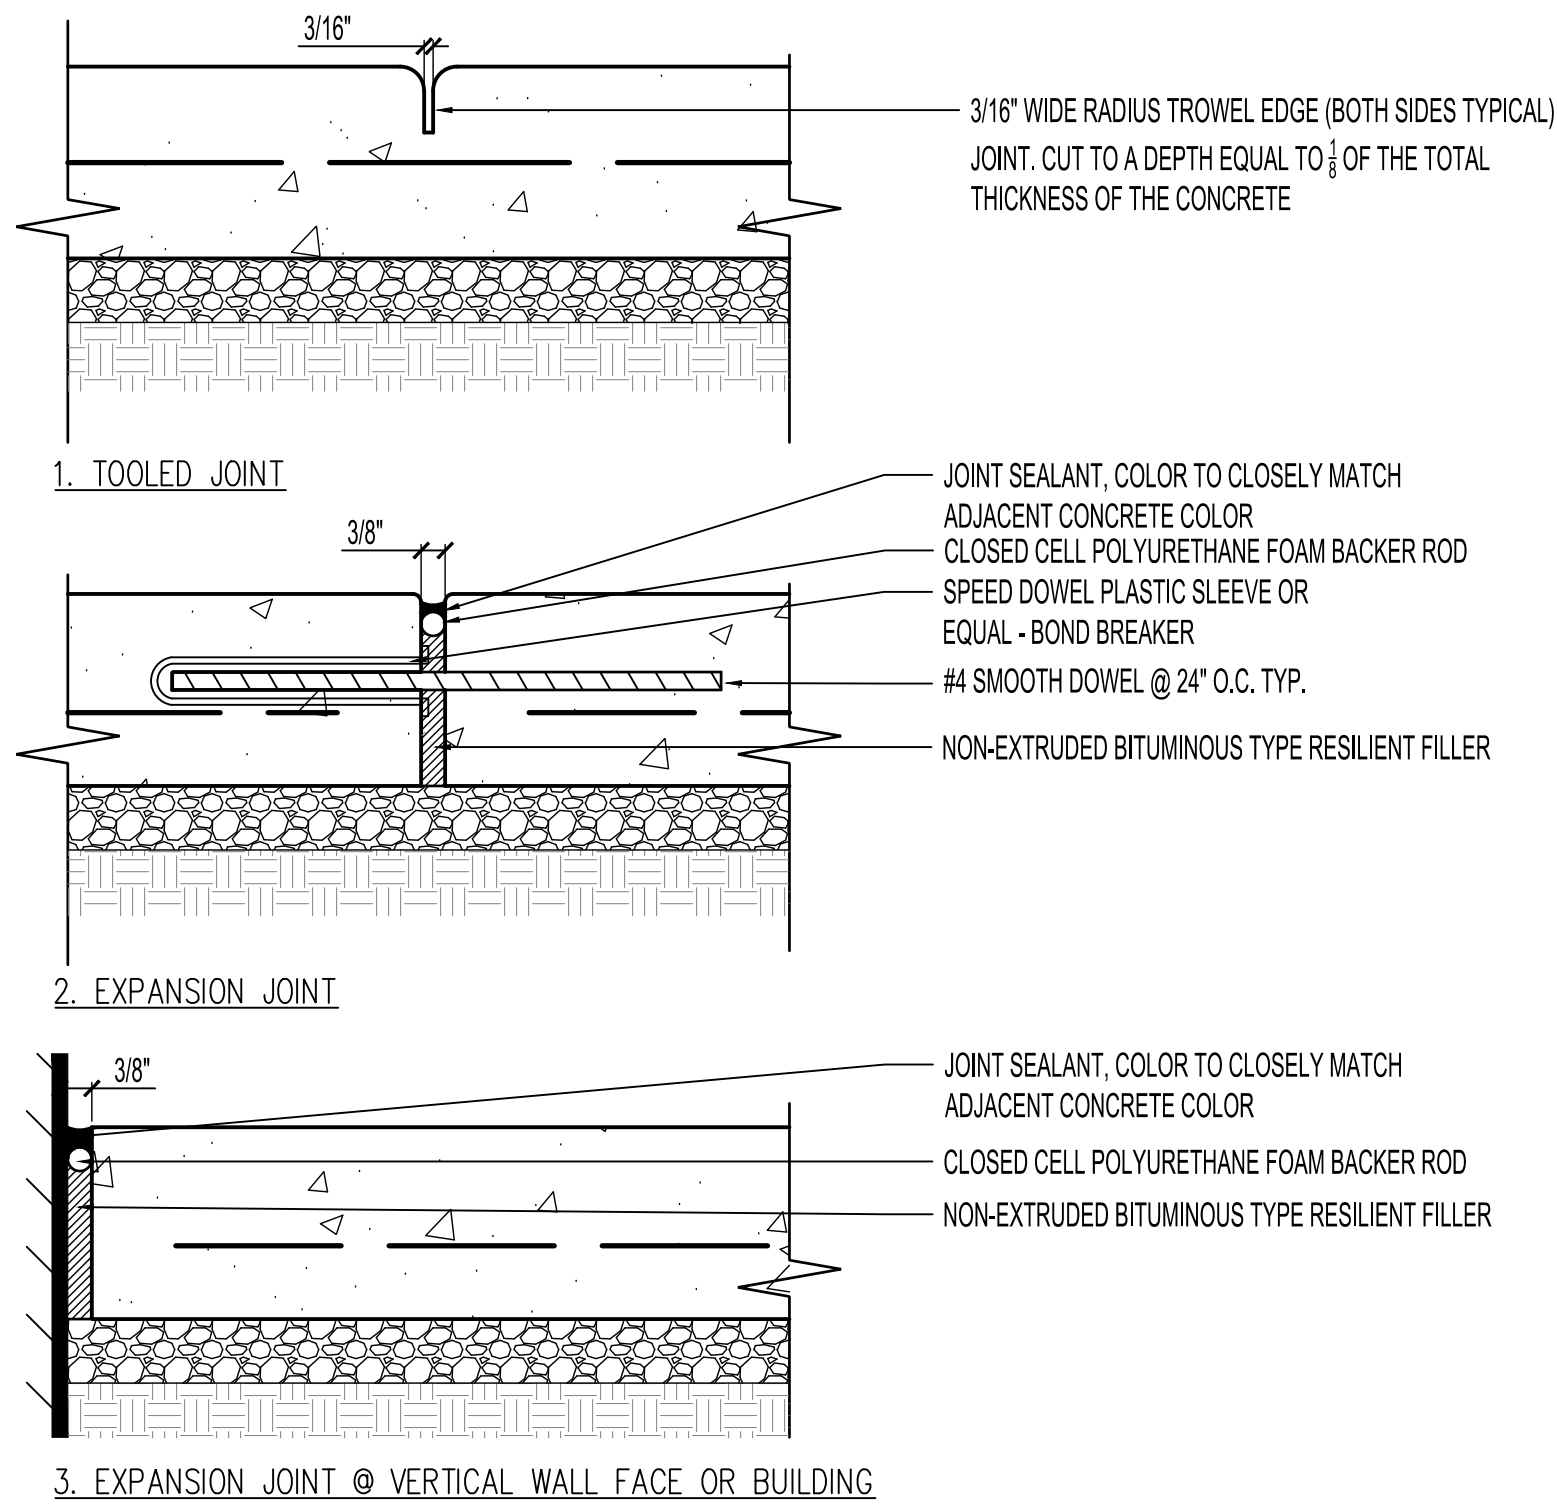


NOTES:

1. REFER TO MATERIAL SCHEDULE & DETAILS FOR COLOR, PATTERN, TEXTURE AND FINISH OF CONCRETE PAVING
2. REFER TO PLANS FOR LOCATION OF ALL CONSTRUCTION JOINTS.
3. ALL CONNECTIONS BETWEEN EXISTING AND NEW CONCRETE PAVING SHALL BE SMOOTH AND FLUSH TRANSITIONS

B TYPICAL CONSTRUCTION JOINTS

Scale: 1" = 1'-0"

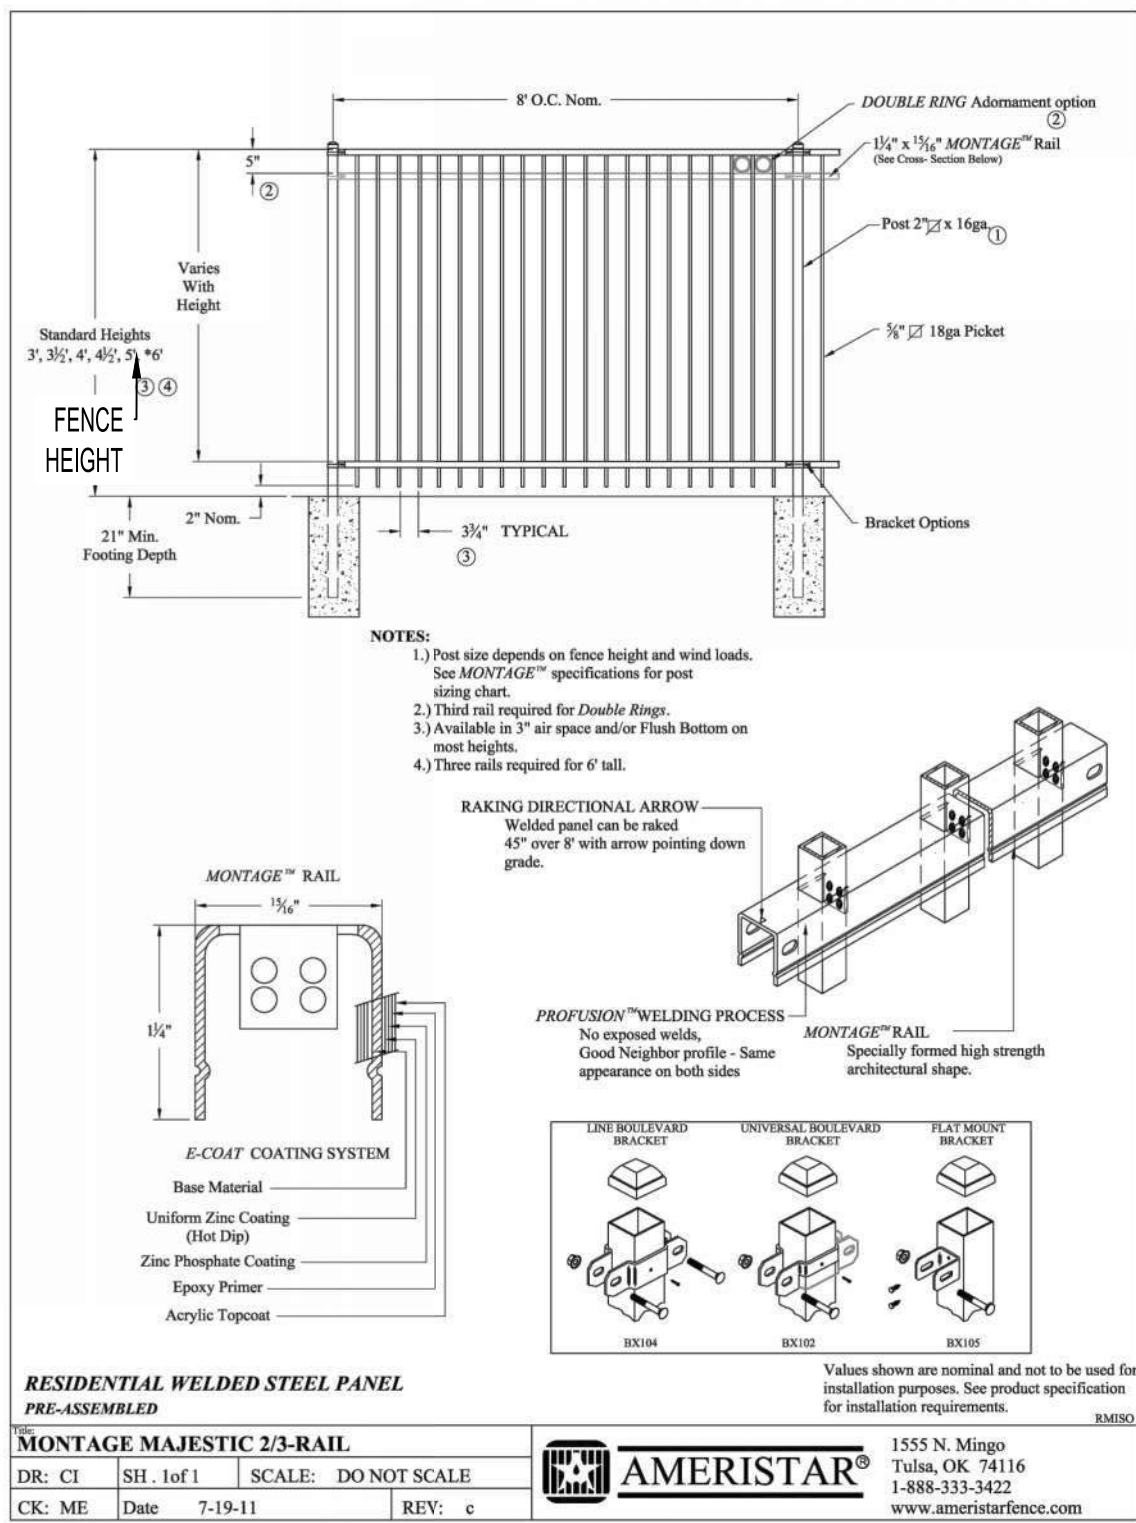


NOTE:

1. PLAYGROUND FENCE SPECIFYING INFO
    - 5 FT. TALL FENCE W/ SINGLE SWING GATES LOCATED PER PLAN. GATE TO SWING IN THE DIRECTION OF EGRESS WITH ABILITY TO LOCK OUTSIDE WITH A PANIC DEVICE.
- FENCE MANUFACTURER SHALL SUBMIT SHOP DRAWINGS OF EACH FENCE AND GATE TYPE FOR APPROVAL BY THE LARCH, PRIOR TO FABRICATION


E TYPICAL FENCE

Scale: NTS

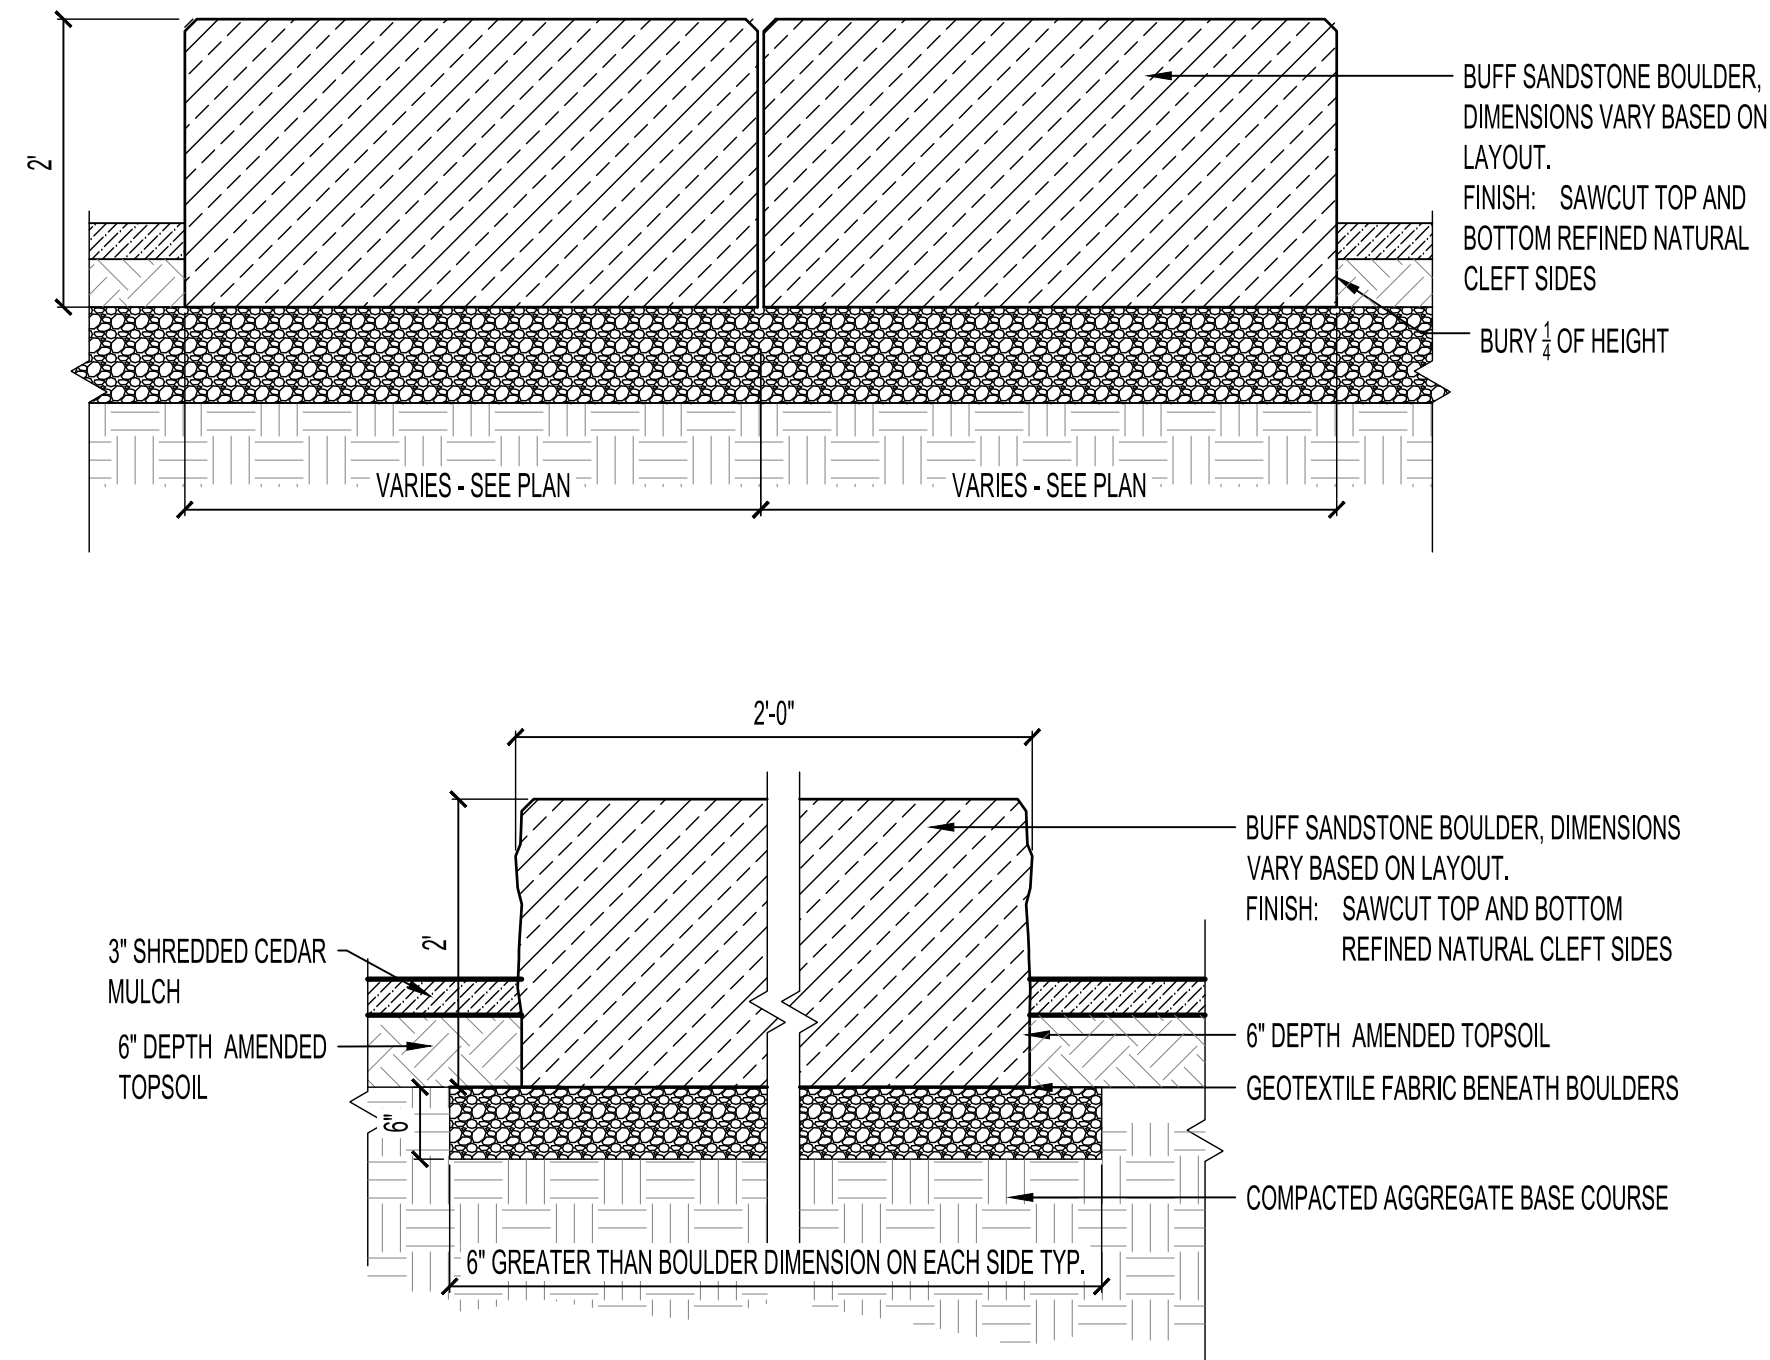

C LANDSCAPE BOULDERS

Scale: 3/4" = 1'-0"

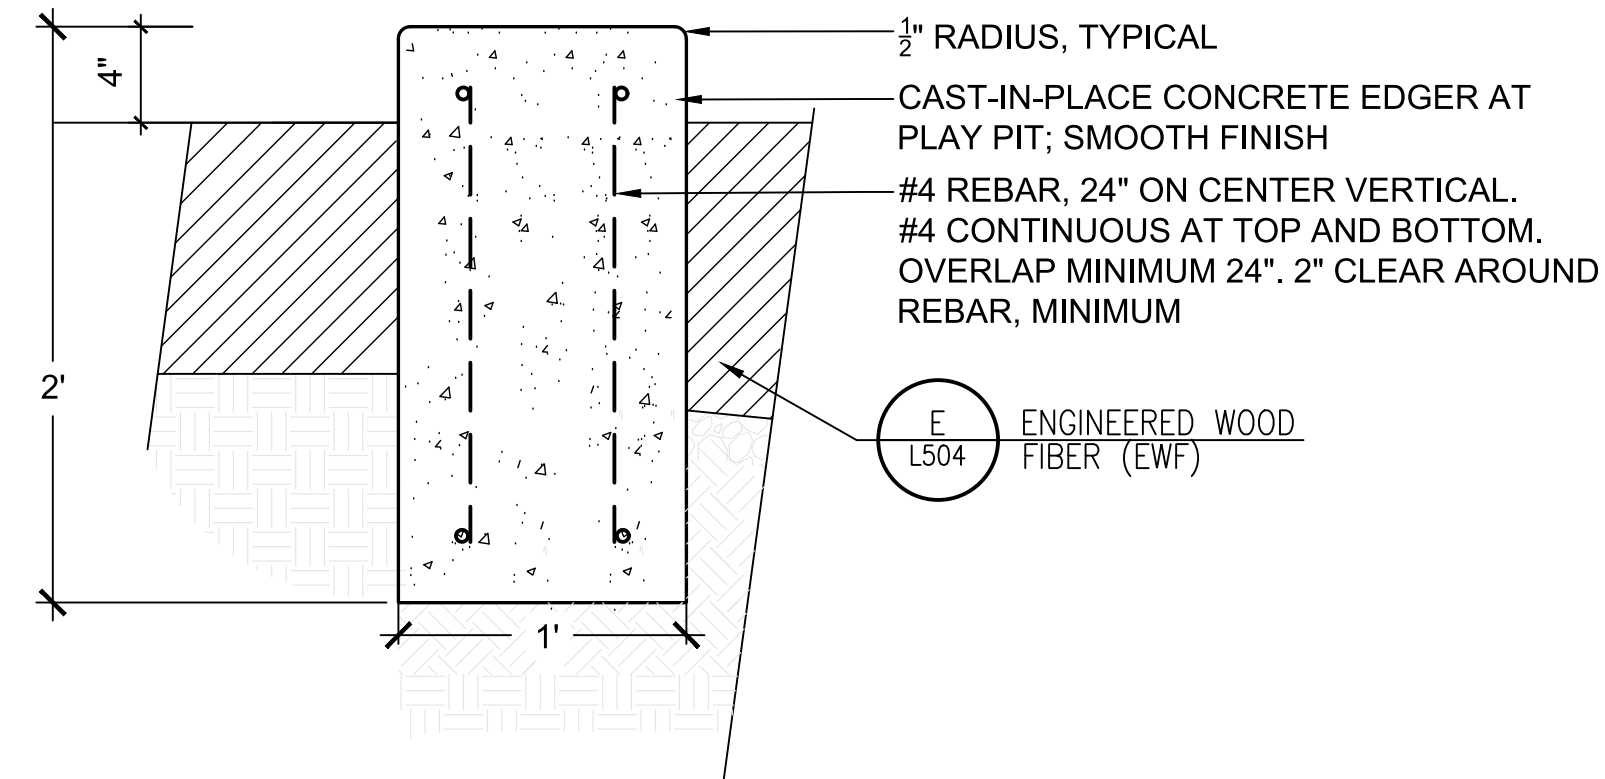

NOTES:



- JOINT SPACING AT EDGER:
1. SAW CUT CONTROL JOINTS EQUALLY SPACED AT 8' MINIMUM, 10' MAXIMUM AND CONTINUE DOWN ENTIRE FACE OF EDGER
  2. EXPANSION JOINTS EQUALLY SPACED AT 80' MINIMUM, 100' MAXIMUM
  3. REFER TO SPECIFICATIONS FOR ALL MATERIALS CALLED OUT IN DETAIL

F PLAYGROUND EDGER

Scale: 1/2" = 1'-0"

DATE	DESC.
11/11/2024	PREAPP
03/12/2025	MDLR CON DOC
03/26/2025	PRELIM
05/15/2025	BID SET
05/23/2025	CITY SUB.




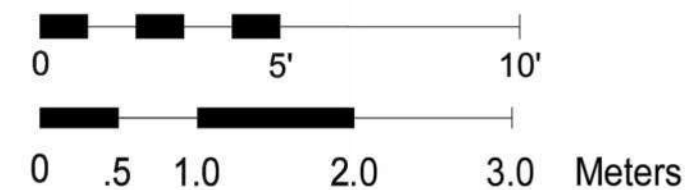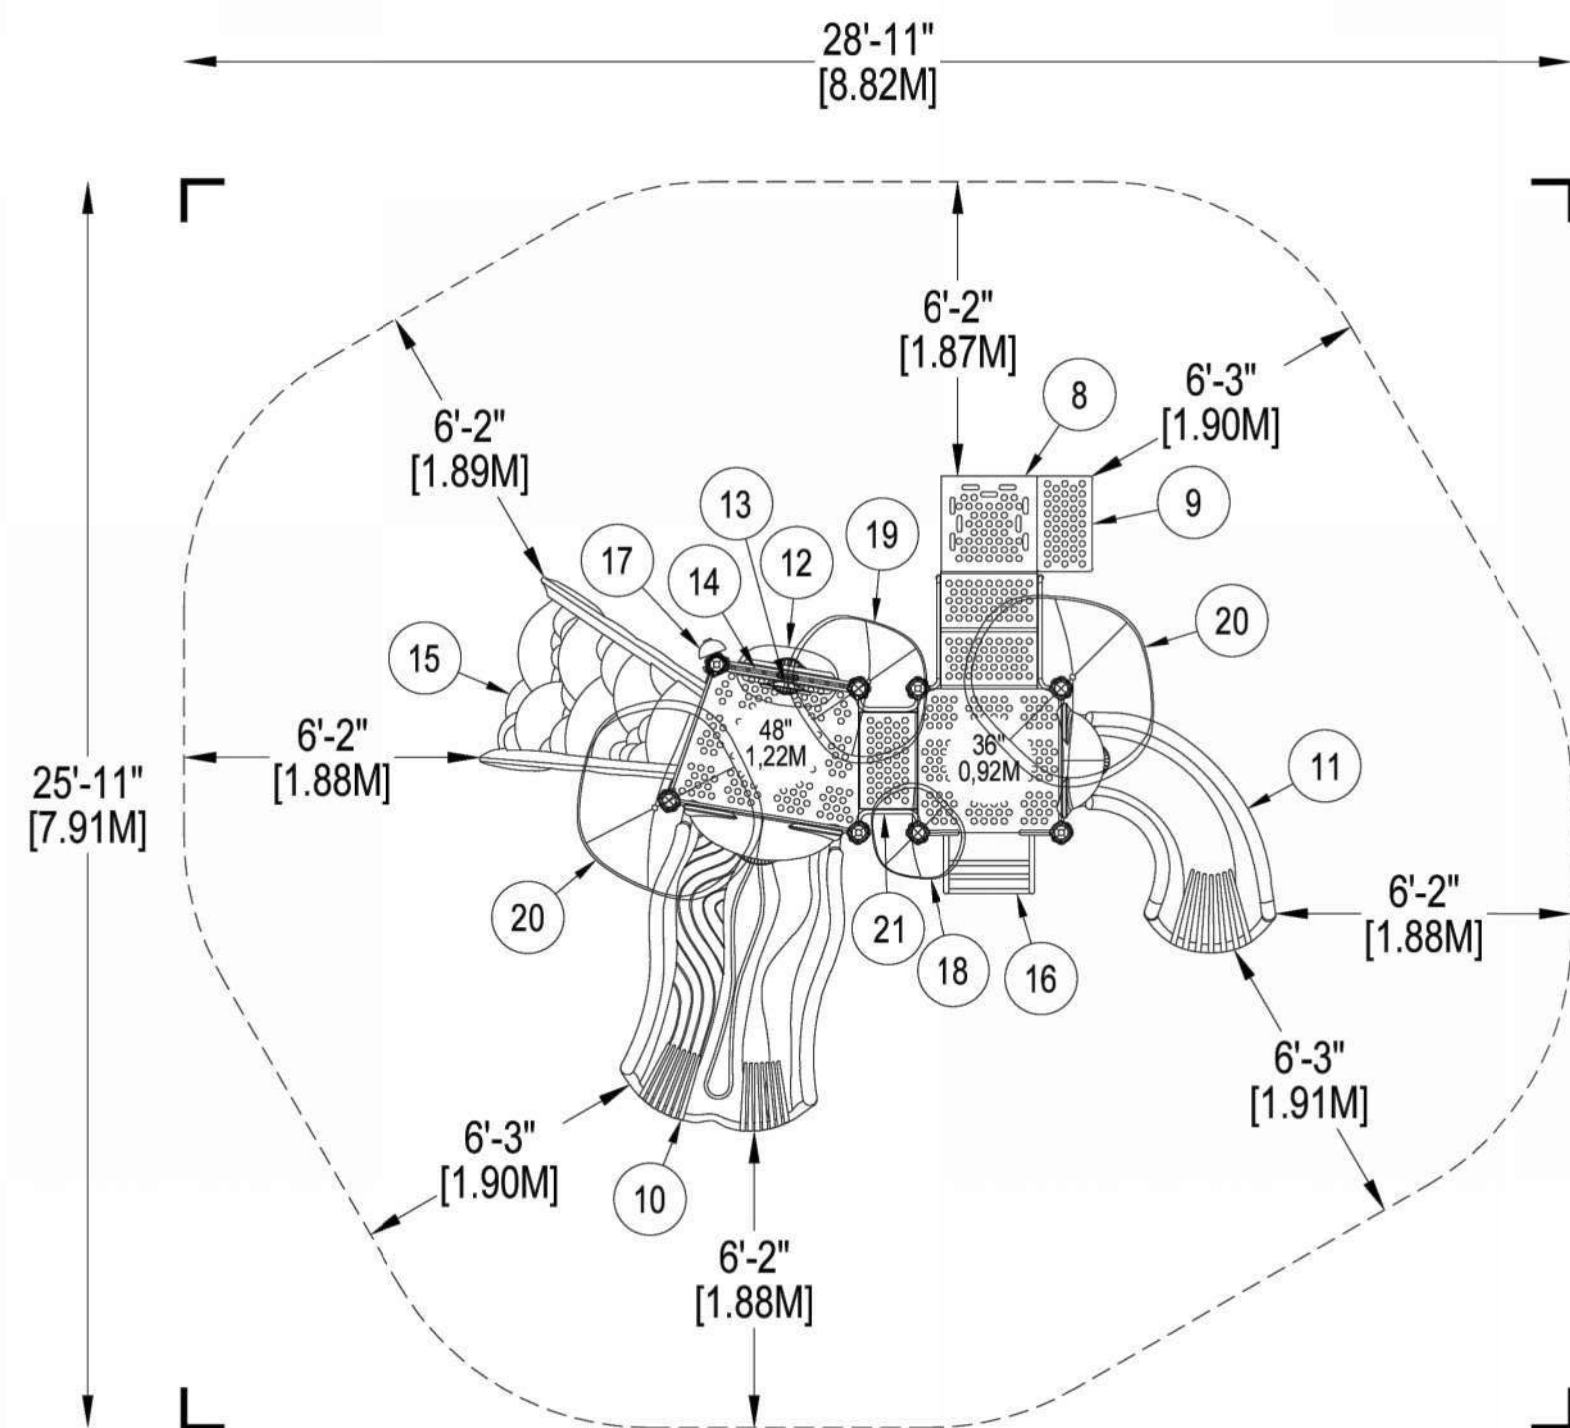

# SP-10



Landscape  
Details



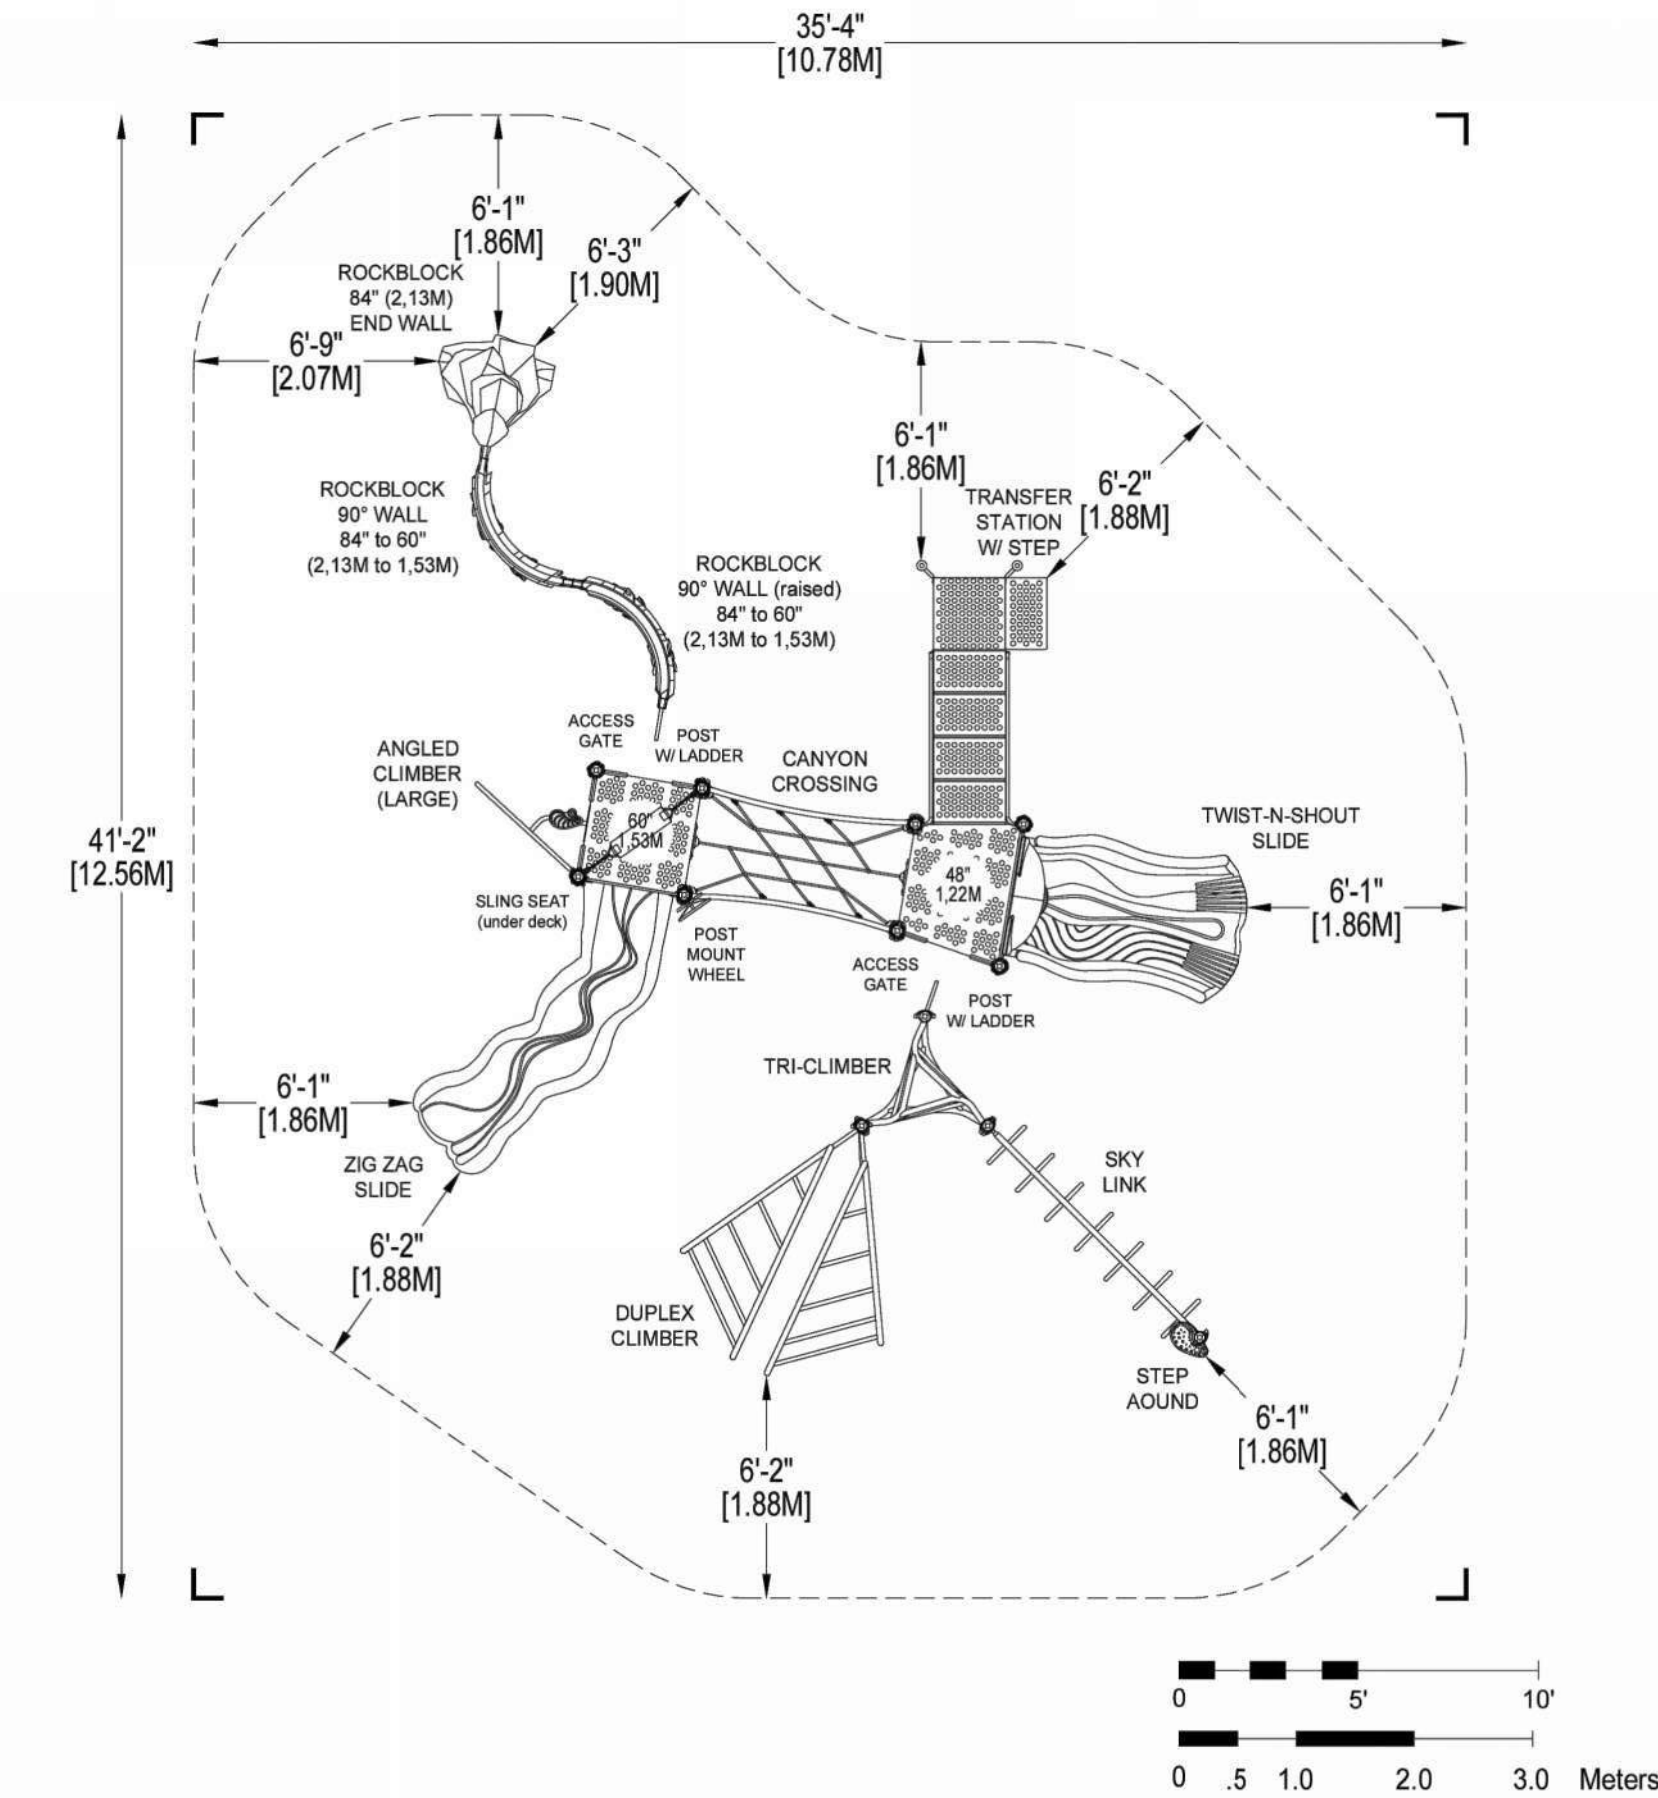

COMPANY: PLAYWORLD OR APPROVED EQUAL  
ITEM: 350-2105A  
AGE RANGE: 5-12 YEARS  
INSTALL PER MANUFACTURER RECOMMENDATIONS AND SPECIFICATIONS

1. DETAIL(S) FROM MANUFACTURER, RVI IS NOT RESPONSIBLE FOR INFORMATION SHOWN.
2. CONTRACTOR TO VERIFY WITH MANUFACTURER THAT DETAIL(S) IS/ARE MOST CURRENT AVAILABLE PRIOR TO INSTALLATION.
3. ADDITIONAL DETAILS AND INSTALLATION INFORMATION IS PART OF INSTALLATION GUIDE PROVIDED BY MANUFACTURER. CONTRACTOR TO OBTAIN ALL ADDITIONAL INFORMATION AND FULLY UNDERSTAND PRIOR TO INSTALLATION OF EQUIPMENT.
4. REFER TO SITE PLANS FOR ADJACENT PLAYGROUND SURFACING. FINISHED SURFACE LEVEL SHOWN ON DETAIL SHALL BE HELD FOR ALL SURFACE TYPES.

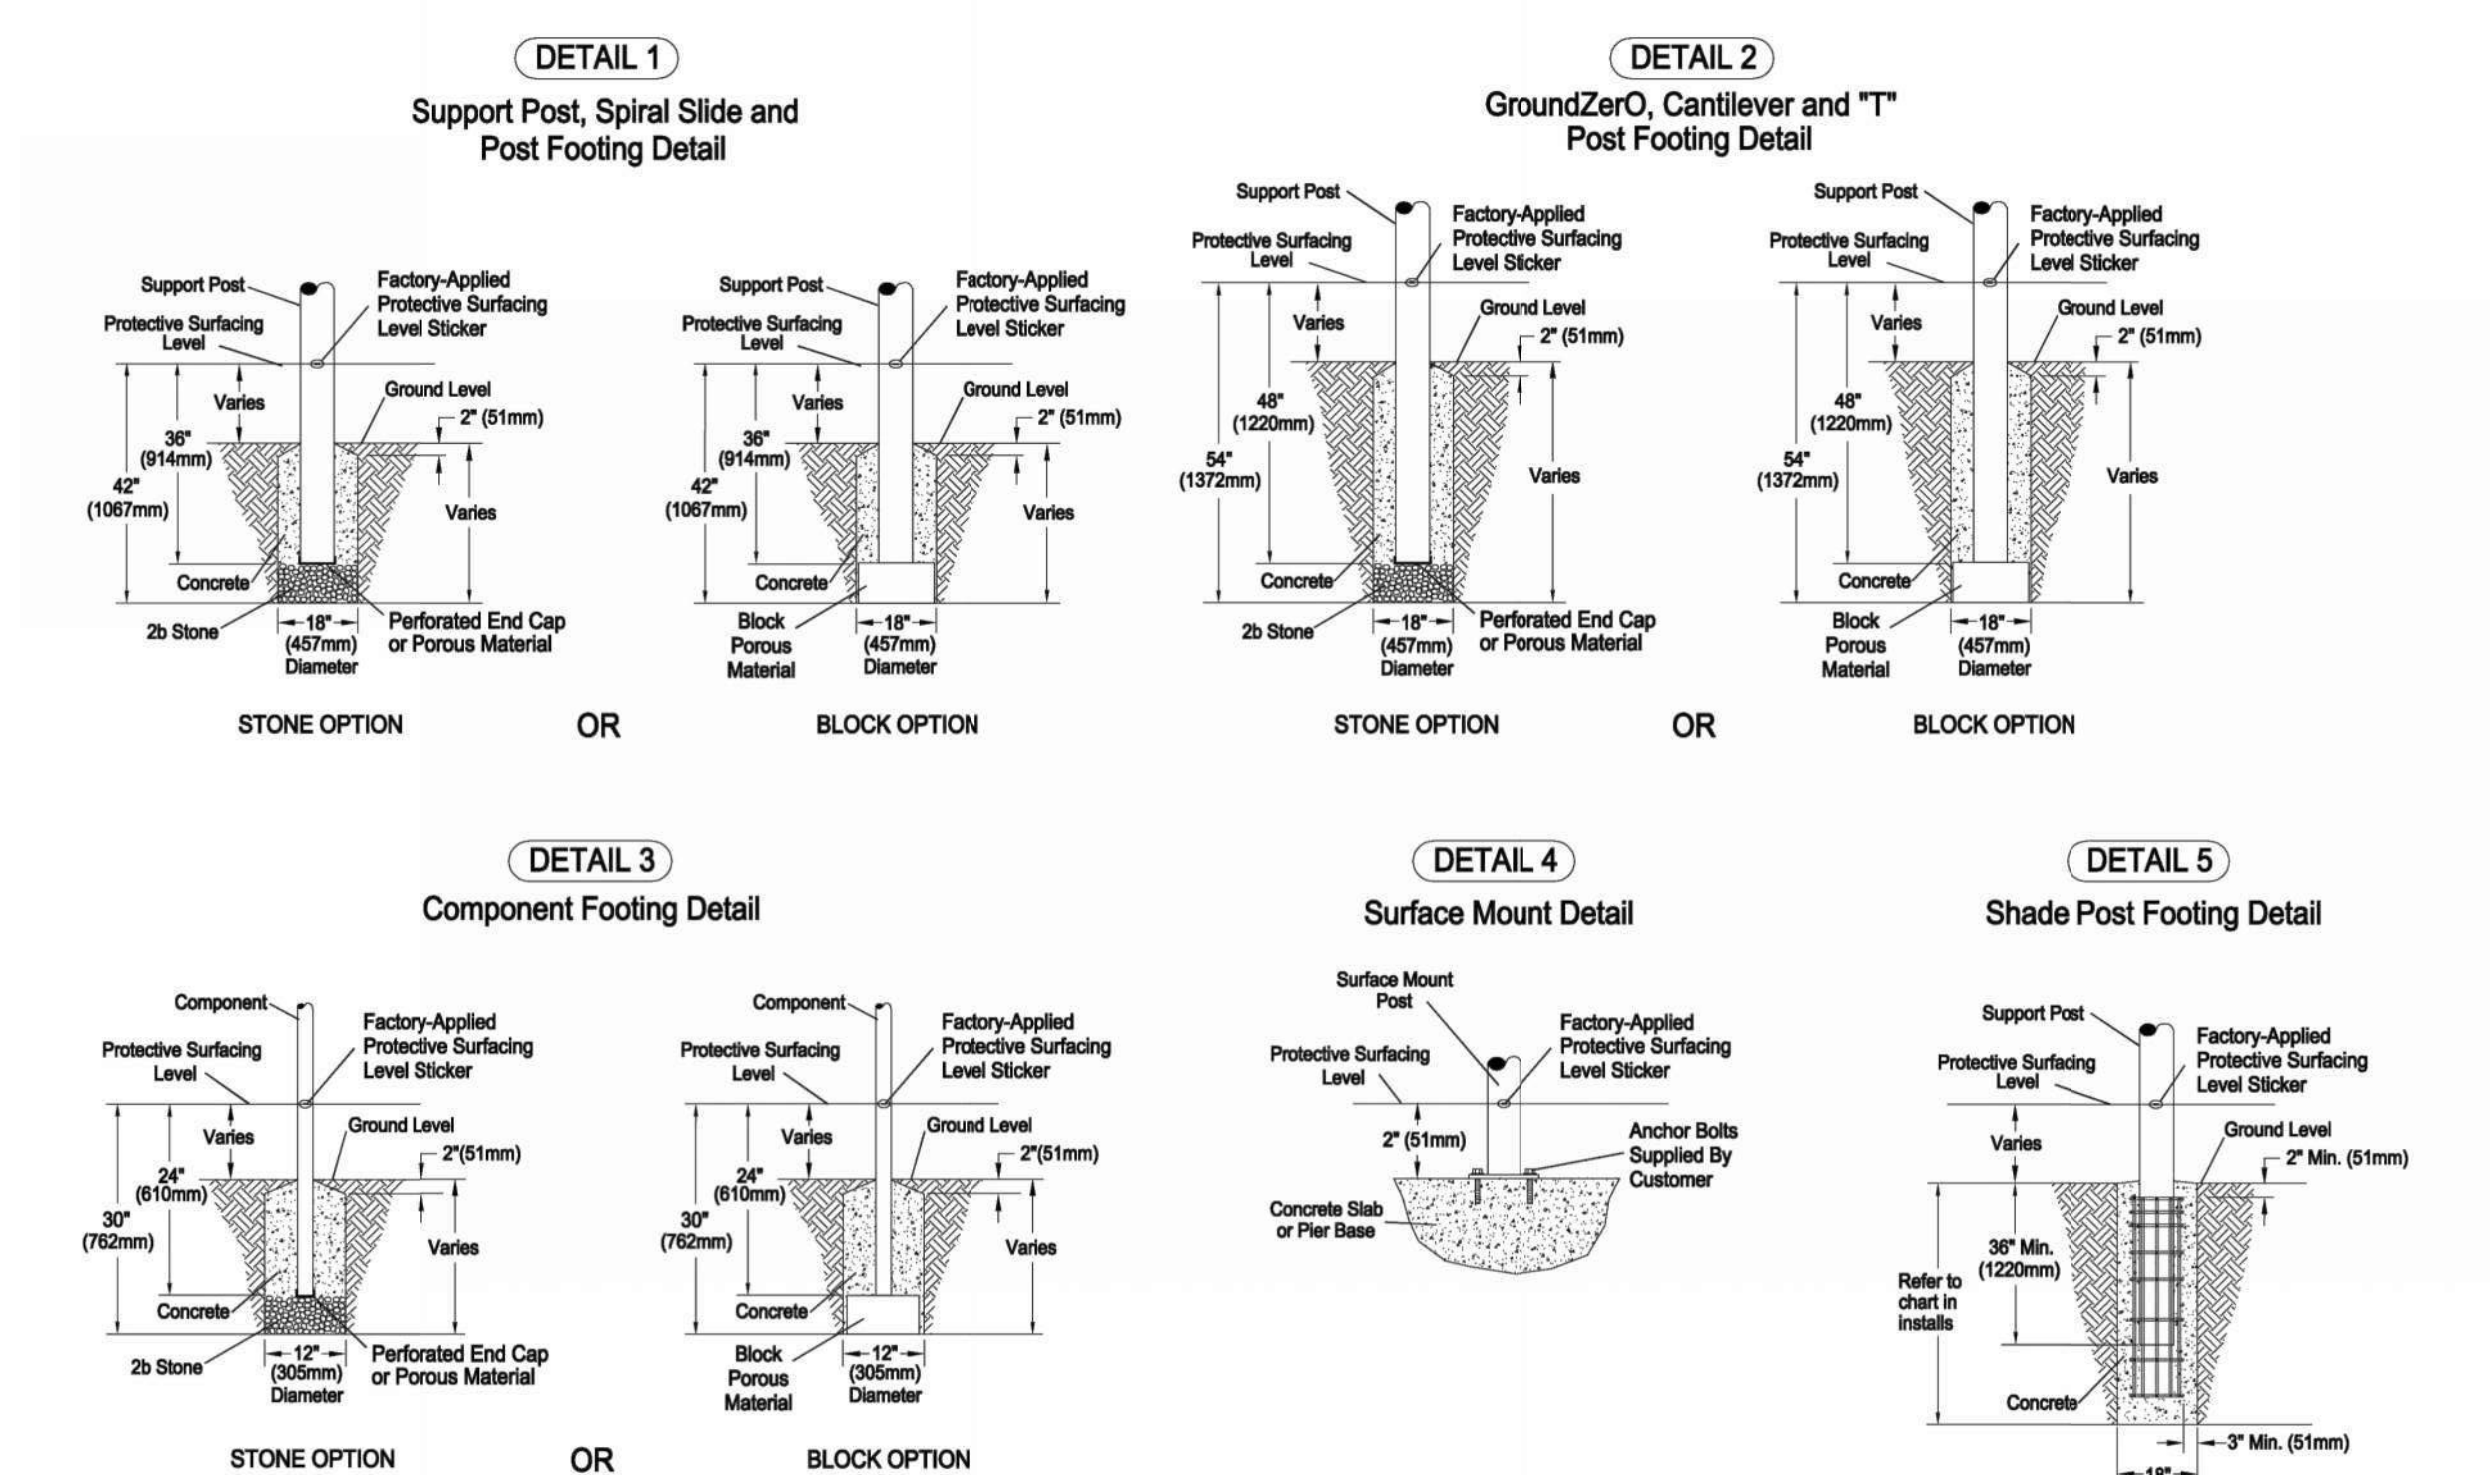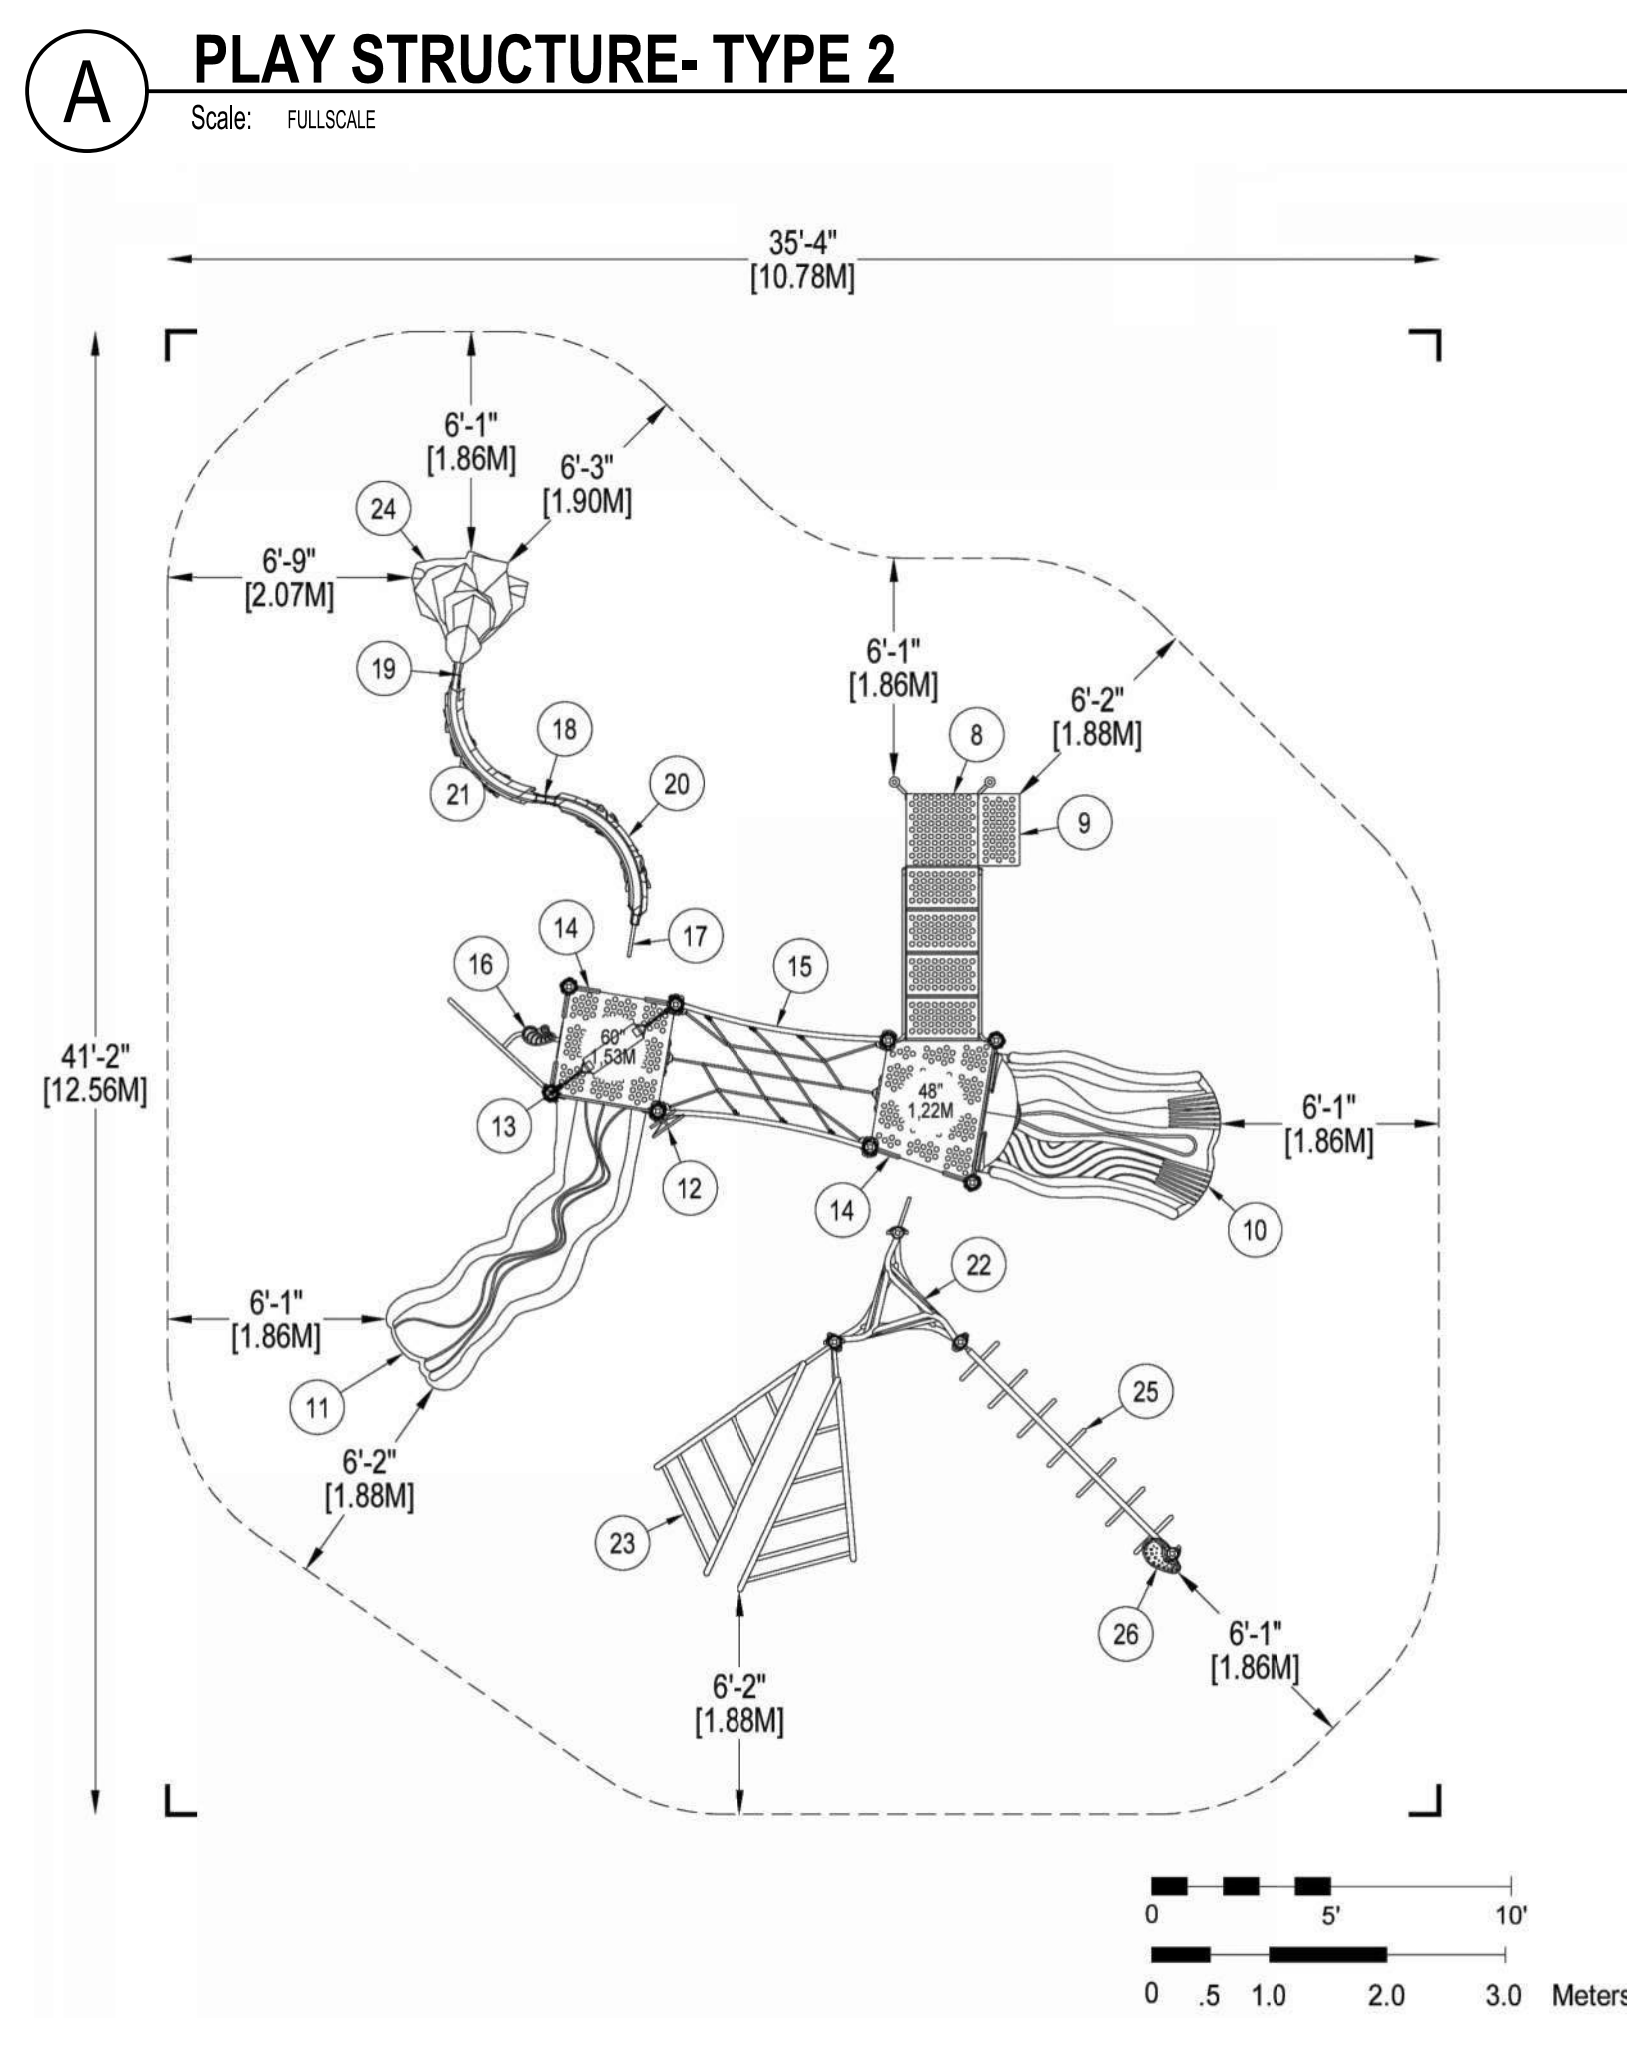


**SITE NOTES:**

- 1) The site plan provided must be checked against the actual site area to ensure that placement of your structure meets required clearances.
- 2) The dimensions labeled are for location of footing holes, not exact placement of equipment. Assembly, plants, and level equipment before pouring concrete.
- 3) There must be a minimum distance of 6" (150mm) between any obstacle, sidewalk, etc., and your structure.
- 4) Slides must have a use zone that extends out from the lower end section of the slide a distance that is at least 6' (180mm) or equal to the vertical distance from the highest point of the sliding surface to the top of the protective surfacing, whichever is greater. The slide use zone should not extend greater than 12' (360mm) from the end of the lower end section.
- 5) The complete area, including the space under and around the equipment, must be covered with an impact attenuating material. See the 1997 publication, "Handbook for Public Playground Safety", published by the U.S. Consumer Product Safety Commission, for guidelines and recommendations on the type and depth of surfacing material. For a copy of the "Handbook for Public Playground Safety", write to: U.S. Consumer Product Safety Commission, Office of Information and Public Affairs, Washington, D.C. 20507


**INSTALLATION NOTES:**

- 1) Paved surfaces, such as asphalt and concrete, are not acceptable for use under your structure.
- 2) It is the consumer's responsibility to check with local utilities prior to excavating footings for any underground utility lines that may exist within the installation area.
- 3) It is the consumer's responsibility to check local soil conditions and drainage within the site area. Inquire with local contractors for appropriate recommendations.
- 4) If the structure is to be installed across uneven terrain, maintain the support post mark for protective surfacing level at the lowest grade. Adjust other footings accordingly.
- 5) The base of footings must be below frost line.
- 6) Do not encase the bottom of support posts in concrete. Place all posts directly on packed stones.
- 7) Assemble the entire structure before pouring concrete unless specifically instructed to do so in the individual component installation instructions.
- 8) Read completely the installation instructions provided with your structure prior to beginning construction.

**\*PLAYGROUND SUPERVISION REQUIRED**

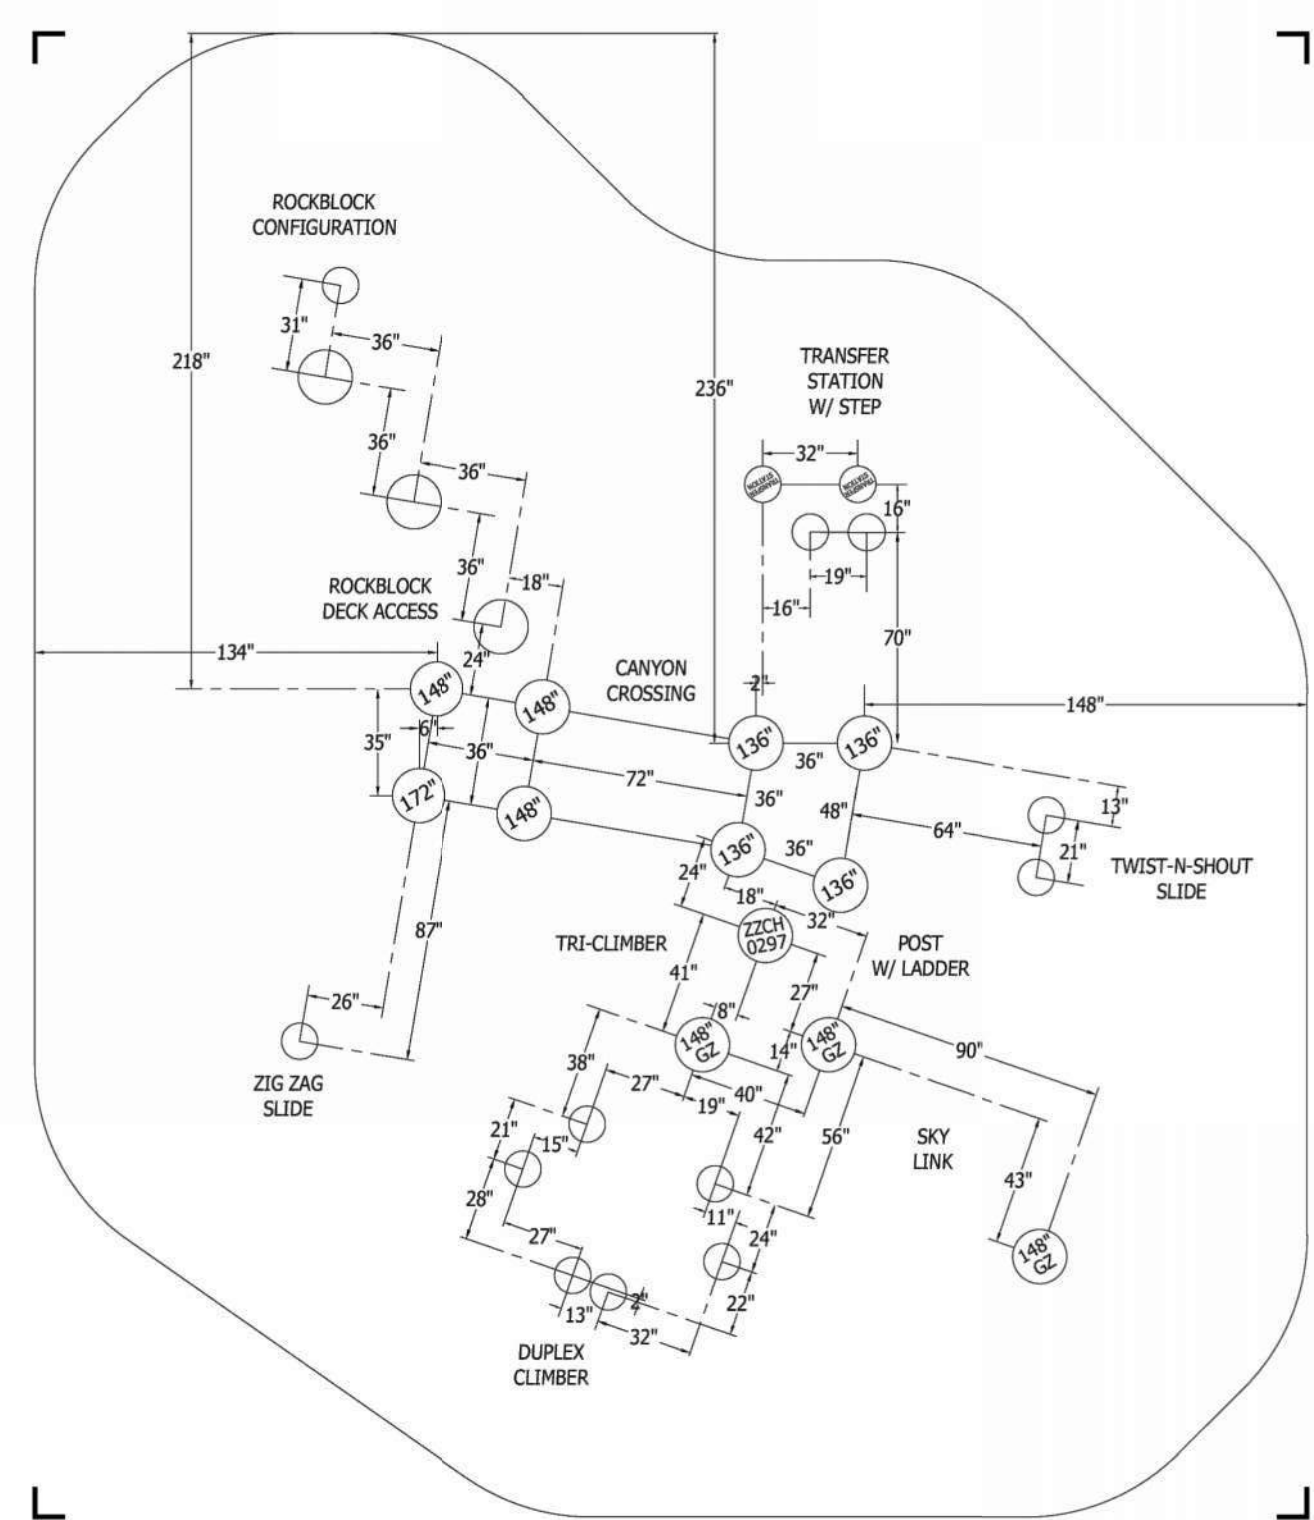




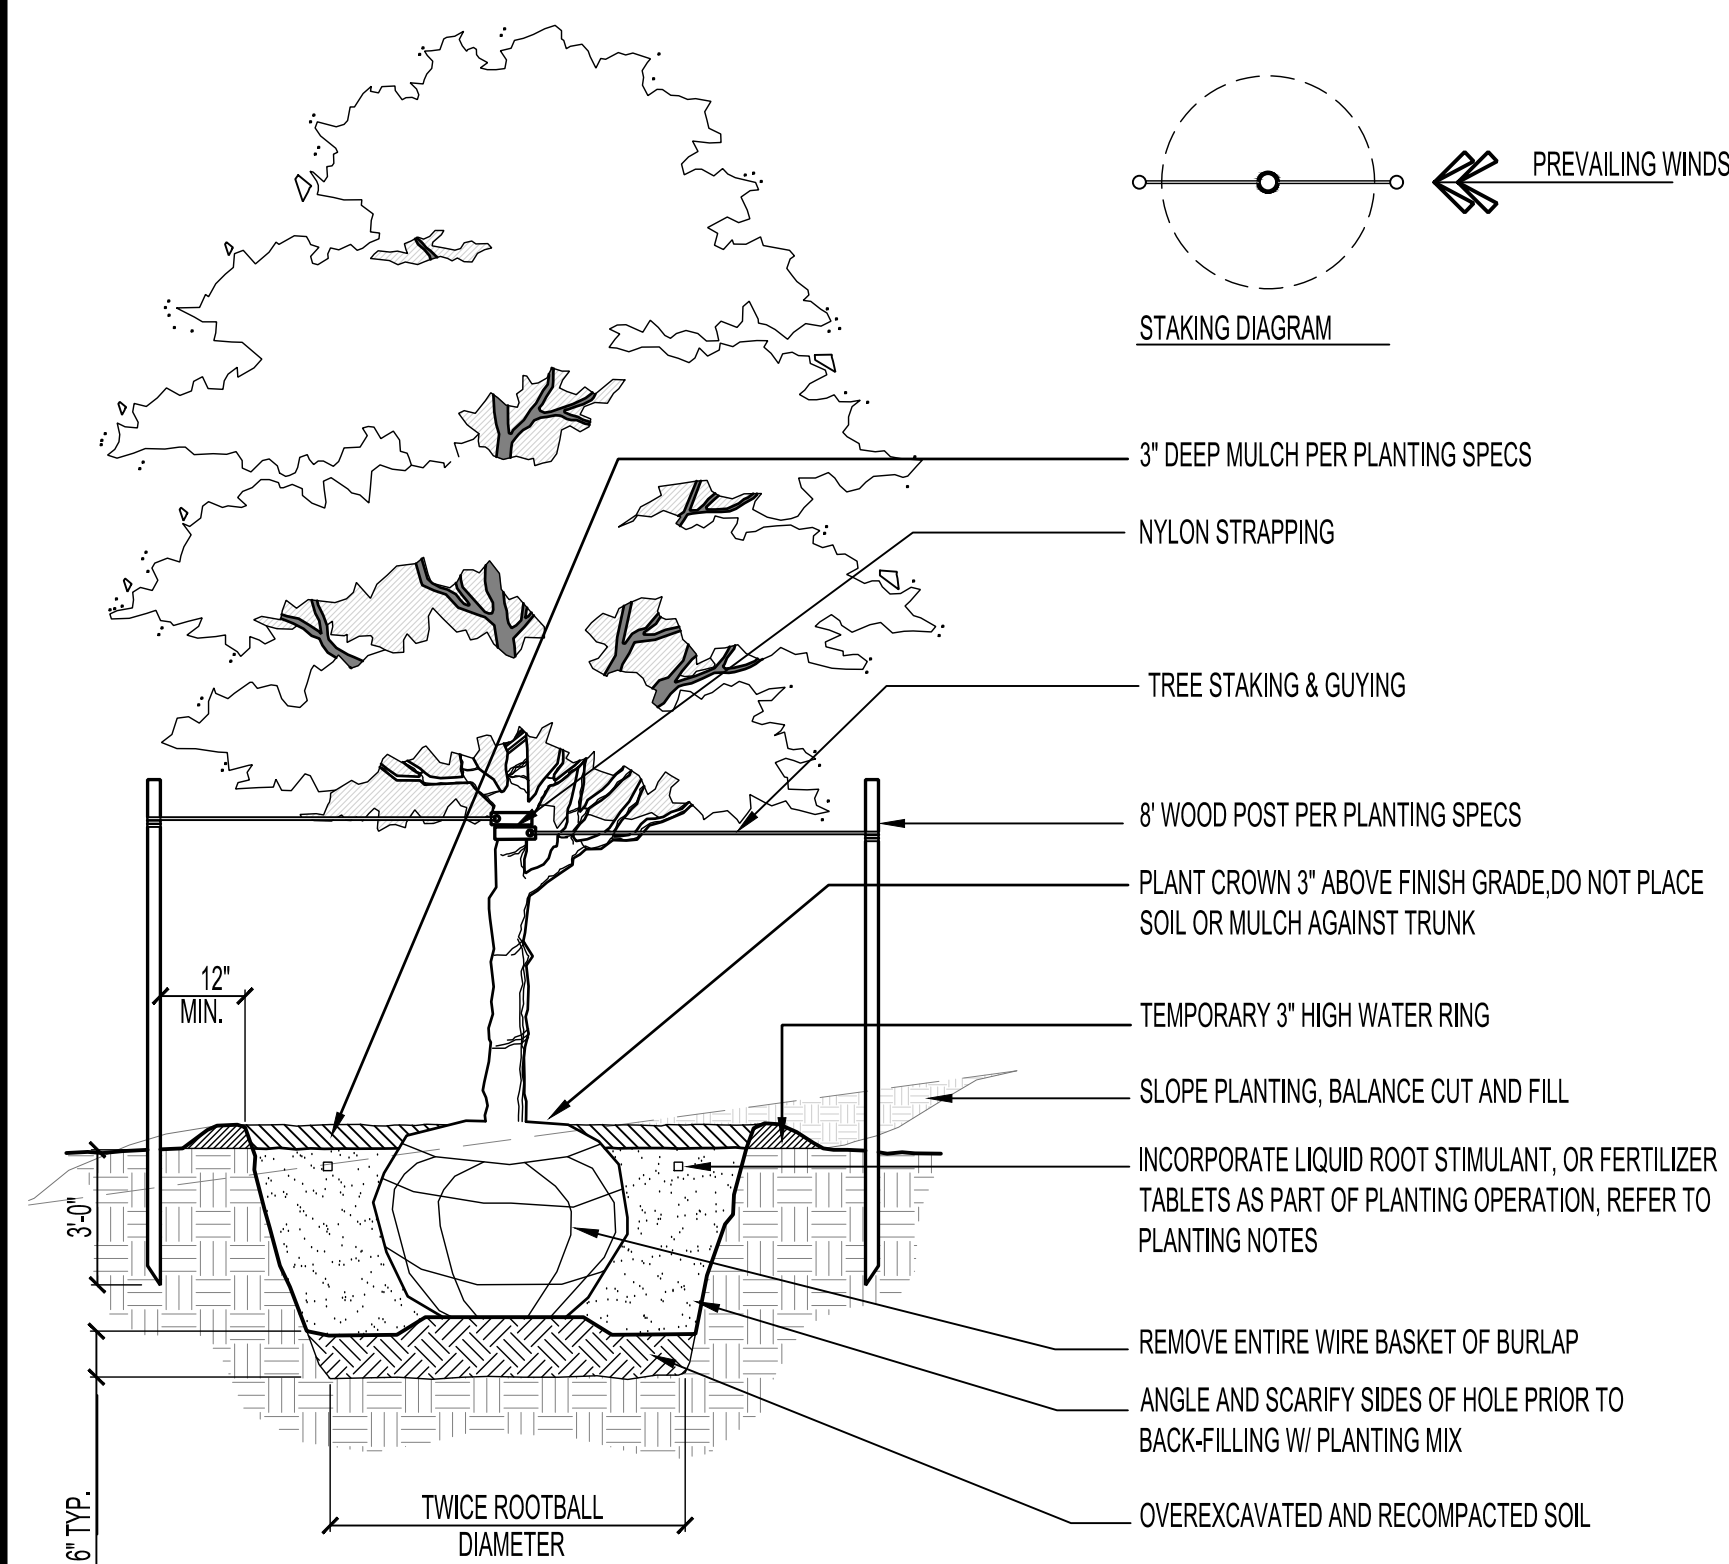


## A DECIDUOUS TREE PLANTING

Scale: N.T.S.

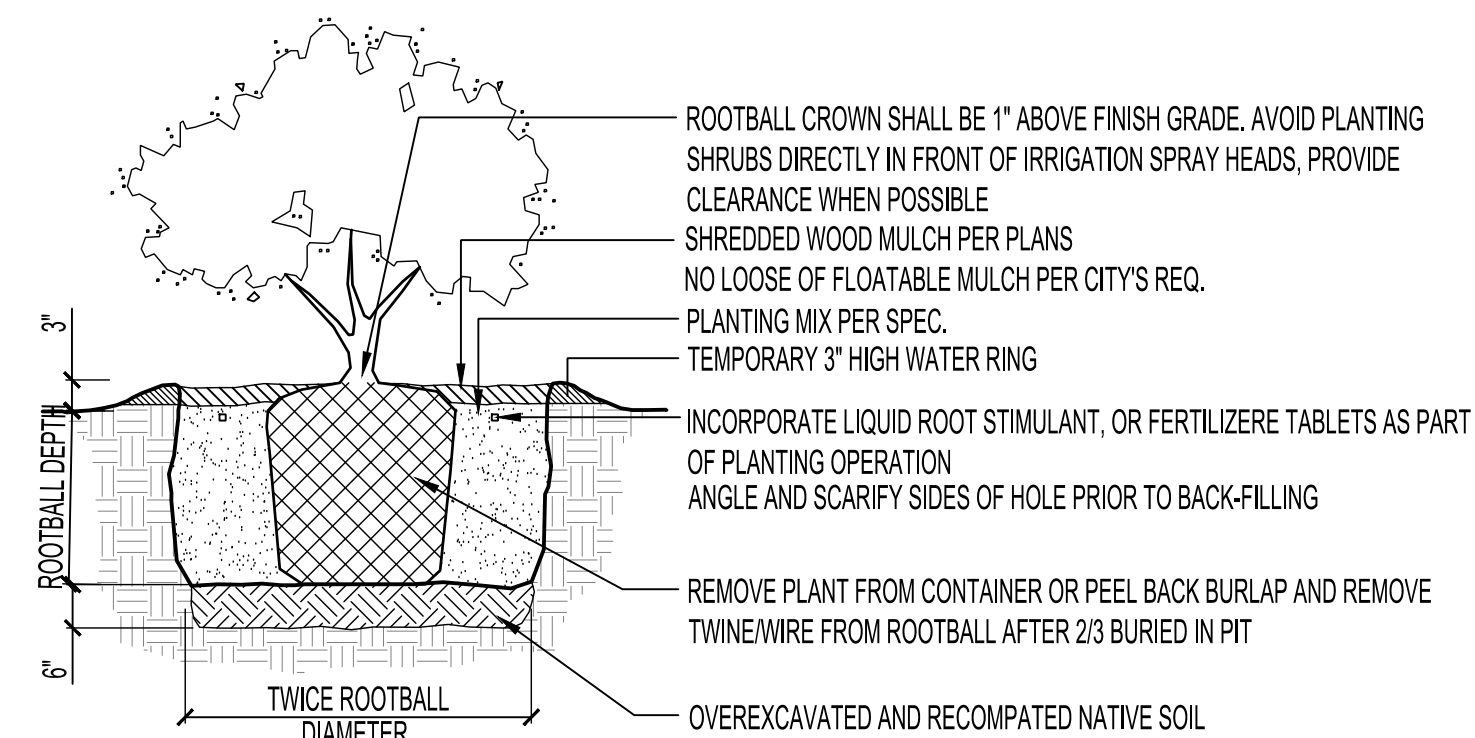


## B SHRUB PLANTING

Scale: N.T.S.

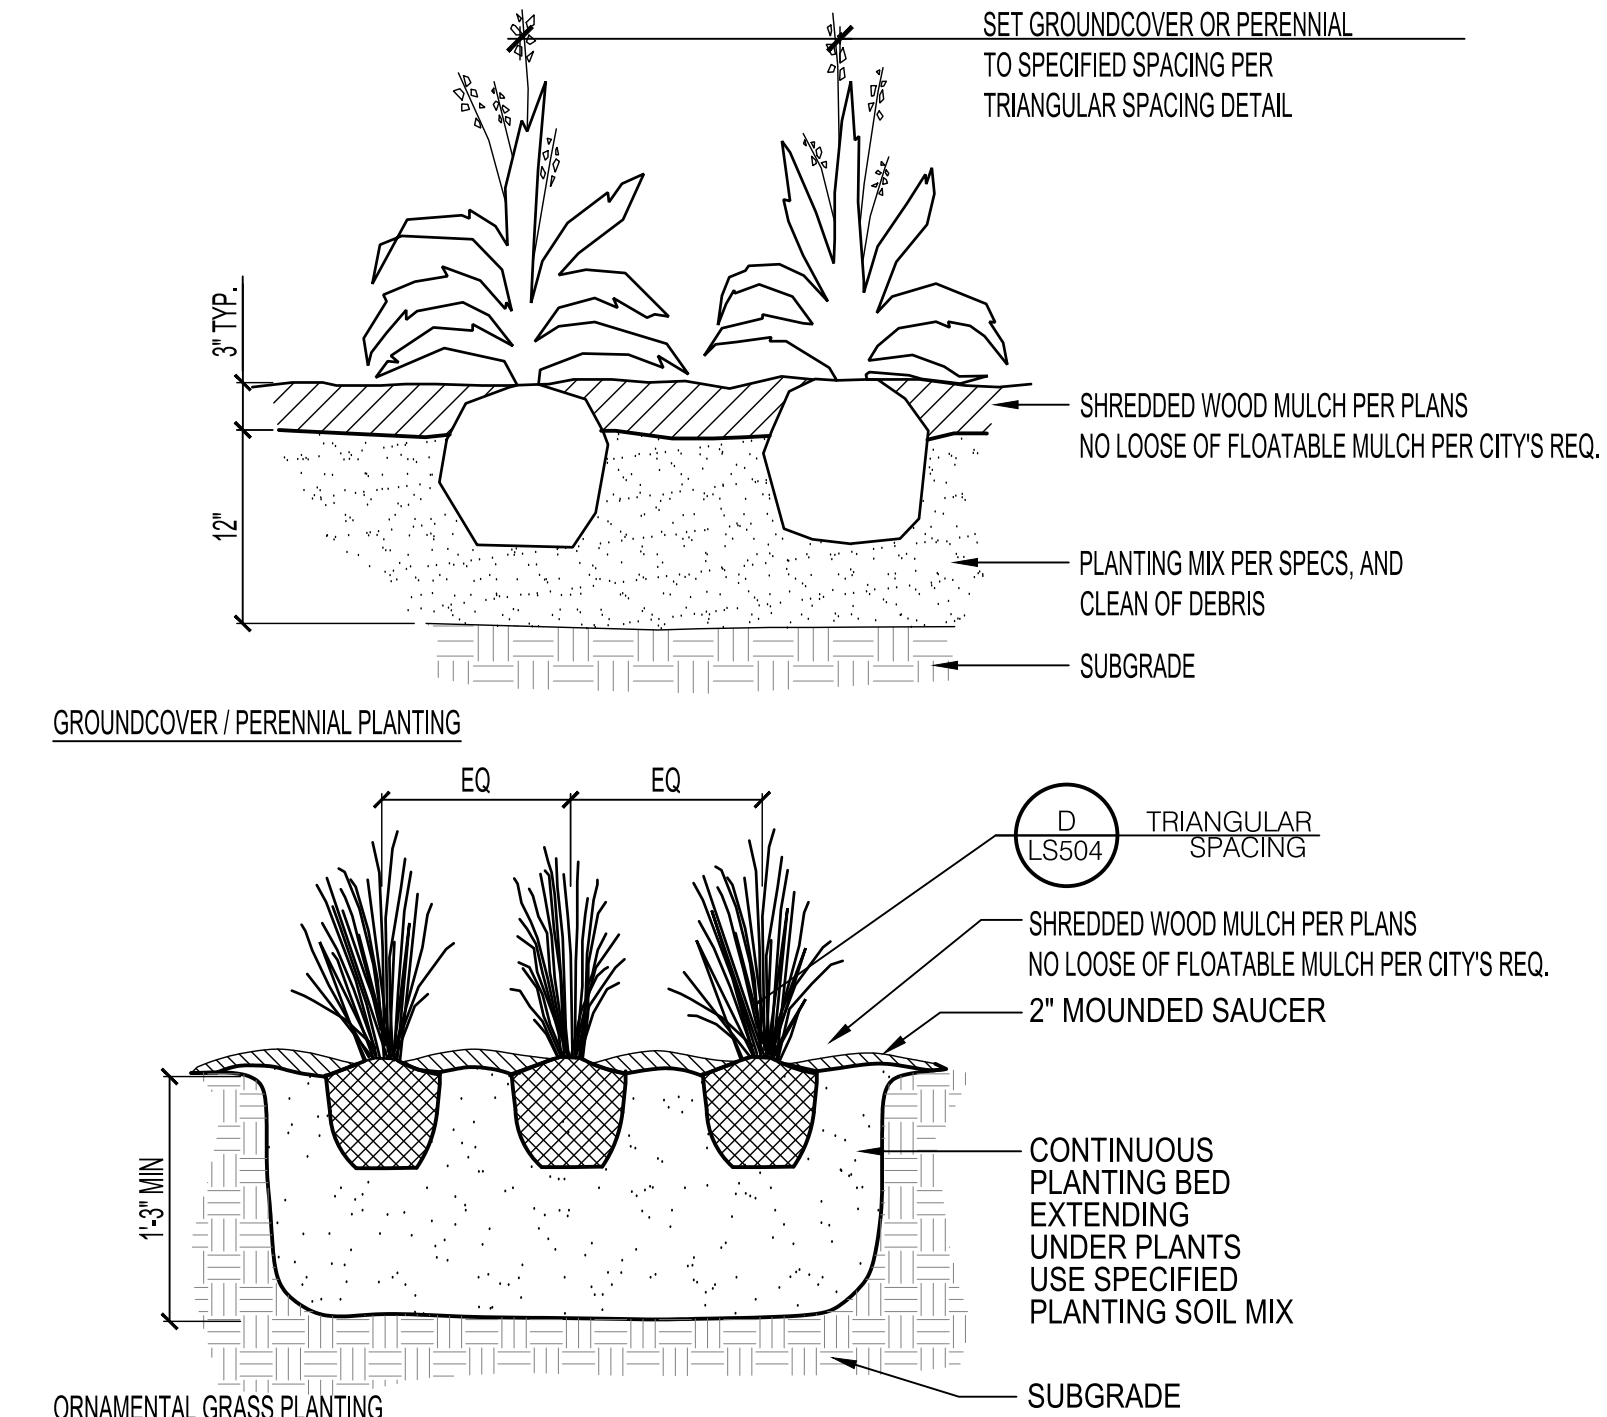


## ORNAMENTAL GRASS & PERENNIAL PLANTING

Scale: N.T.S.

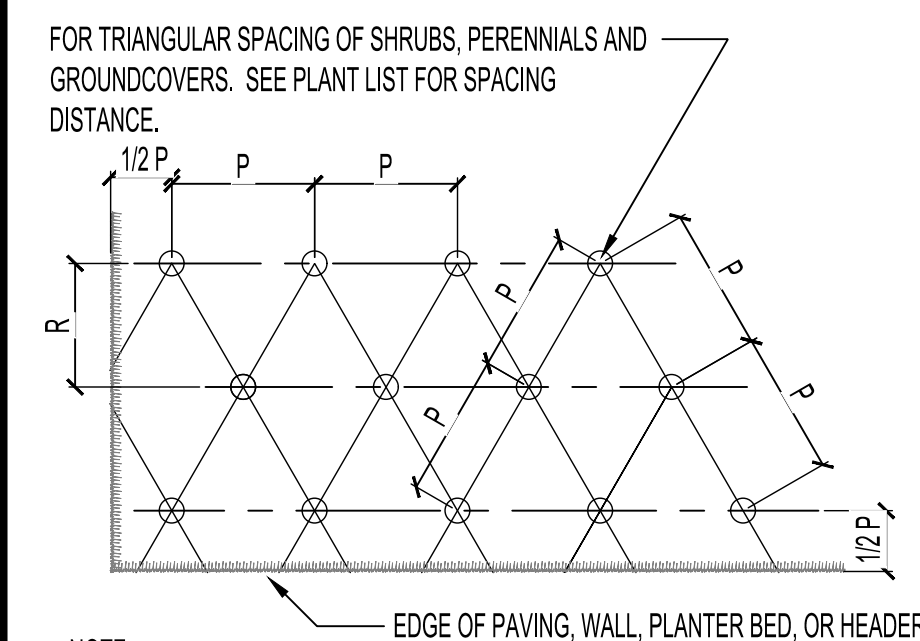


## PLANT SPACING DIAGRAM

Scale: 1" = 1'-0"

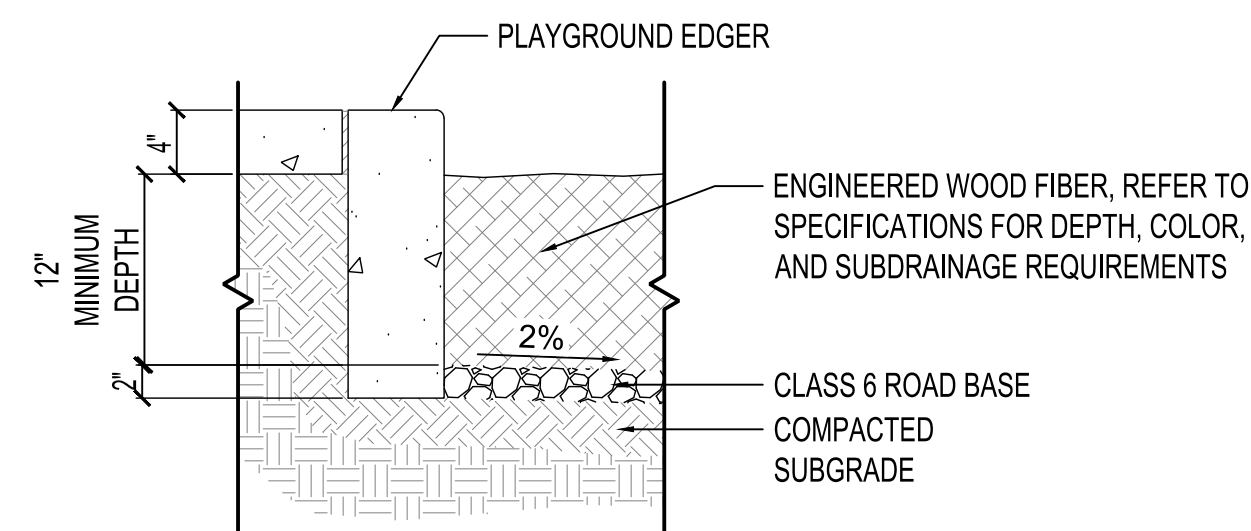


**E ENGINEERED WOOD FIBER**

Scale: 1" = 1'-0"

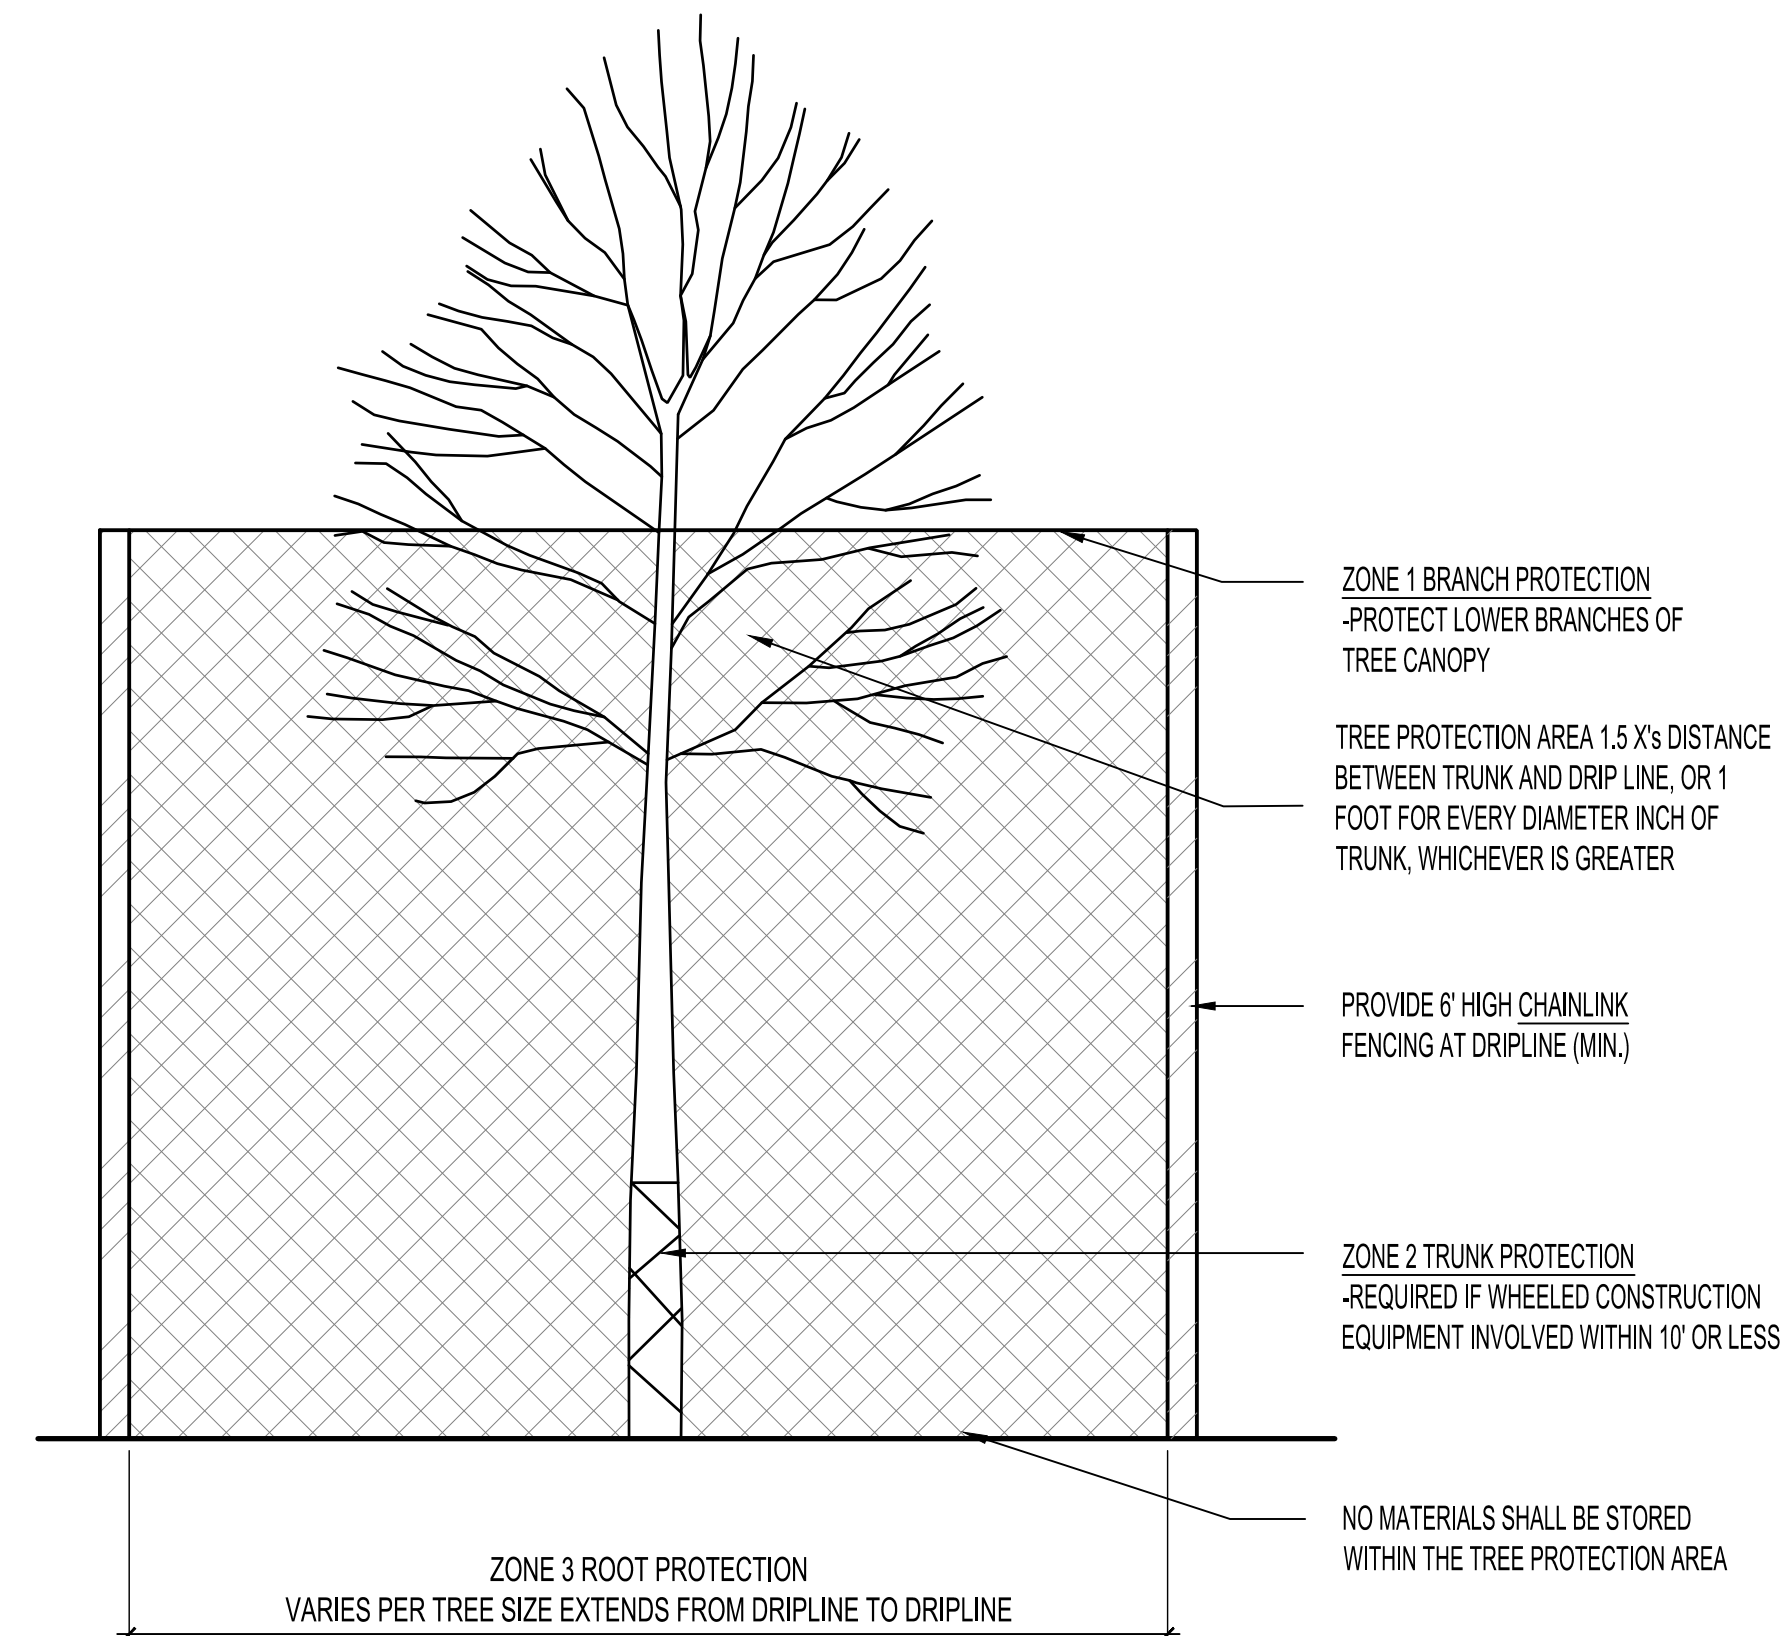

## TREE PROTECTION

Scale: 1" = 1'-0"

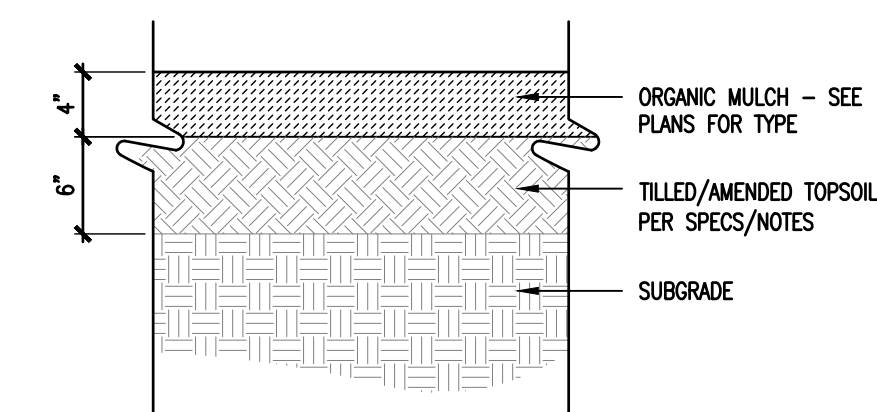


**MULCH**


Scale: 1 1/2" = 1'-0"

DT-PLNT-MLCH


EXTERIOR FINISH LEGEND			
SYM.	PATTERN	DESCRIPTION	MANUFACTURER / COLOR
(M)		BERRIDGE METAL PANEL OVER 7/8" HAT CHANNEL	BERRIDGE FW-12 COLOR SHASTA WHITE
(S)		THREE COAT STUCCO (3/8" SCRATCH COAT, 3/8" BROWN COAT, 1/8" FINISH COAT) OVER PAPER BACKED METAL LATH ON TYVEK STUCCO WRAP	LOTUS SCHOOL COLOR NAVY BLUE
(B)		RUNNING BOND 3/4" MIN. THIN BRICK SET IN MORTAR OVER PAPER BACKED METAL LATH ON TYVEK STUCCO WRAP ON 1/2" THICK CEMENT BACKER BOARD OR GYPSUM SHEATHING	BELDEN: GRAPHITE BLACK VELOUR OR SIMILAR
(SF)		STOREFRONT WINDOW SYSTEM WITH PPG SOLARBAN 70XL (2) SOLARGRAY GLAZING	TUBELITE TU14000 DARK BRONZE MULLIONS
(PC)		PRECAST	GRAY

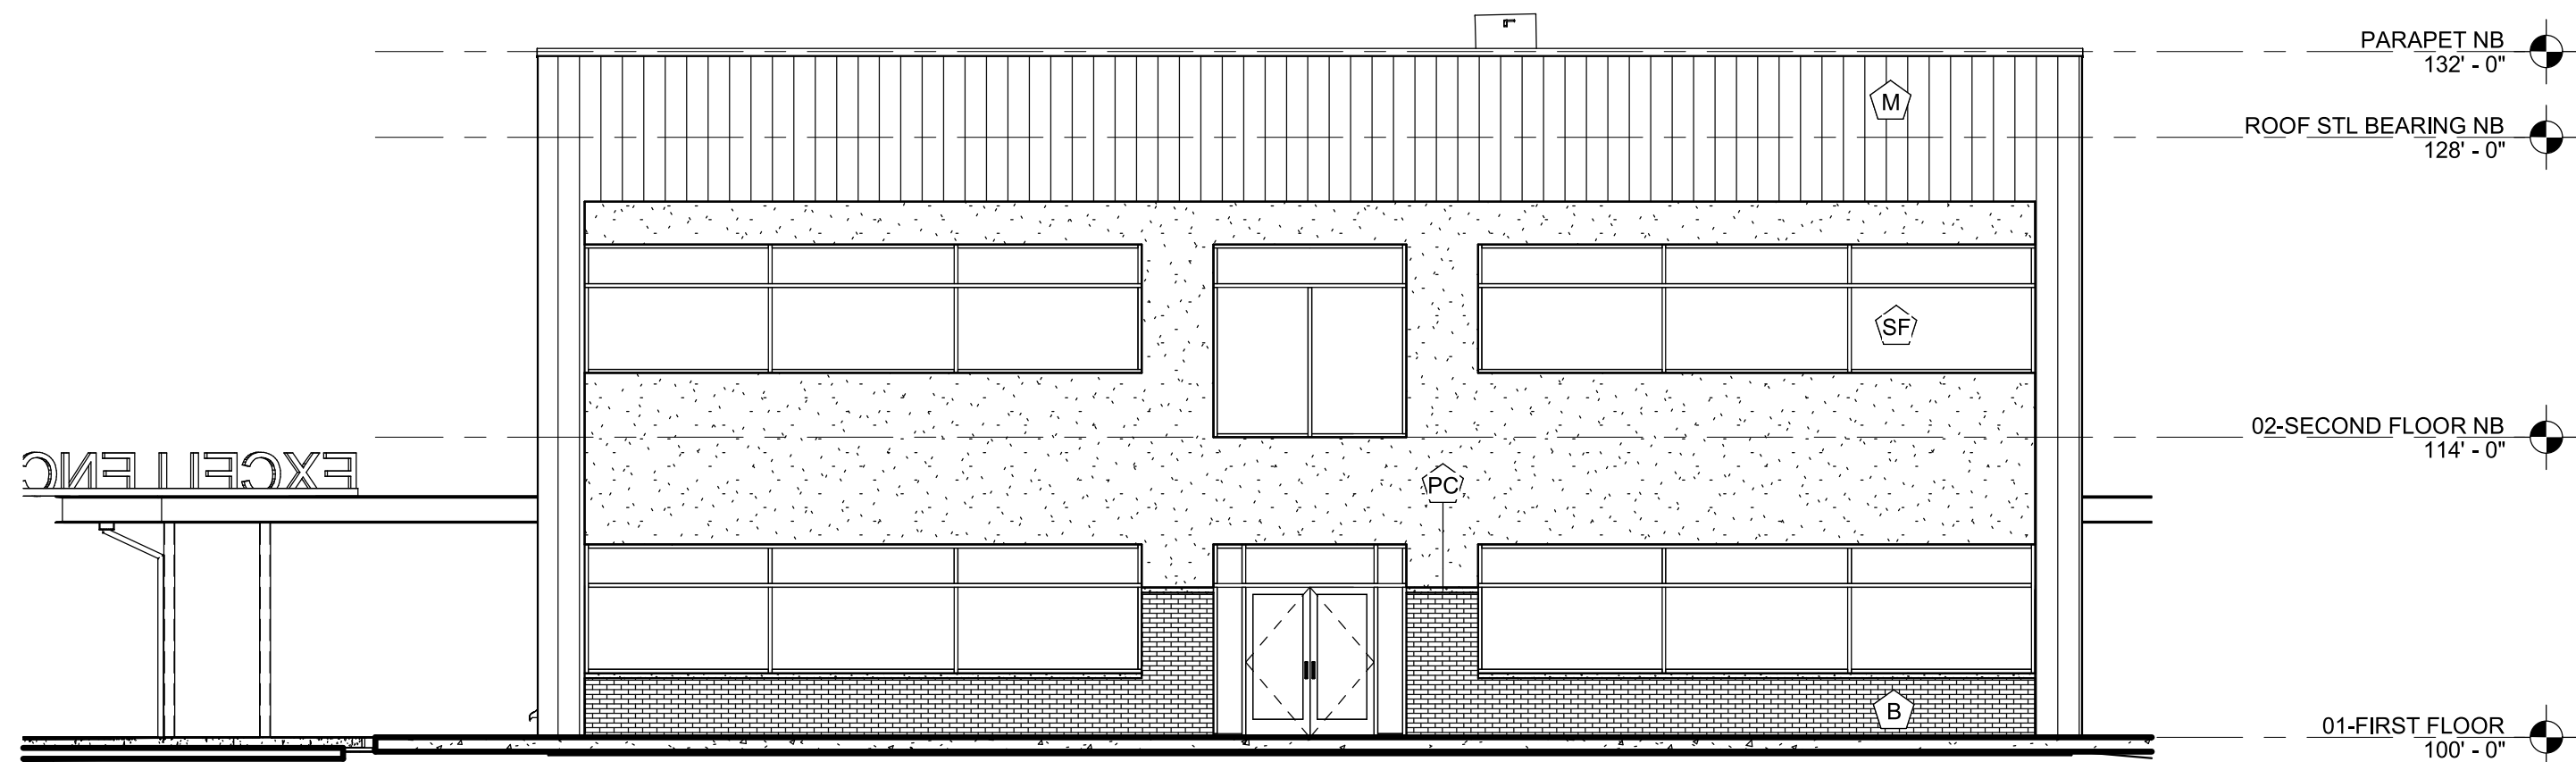


1 NORTH ELEVATION  
SCALE: 1/8" = 1'-0"

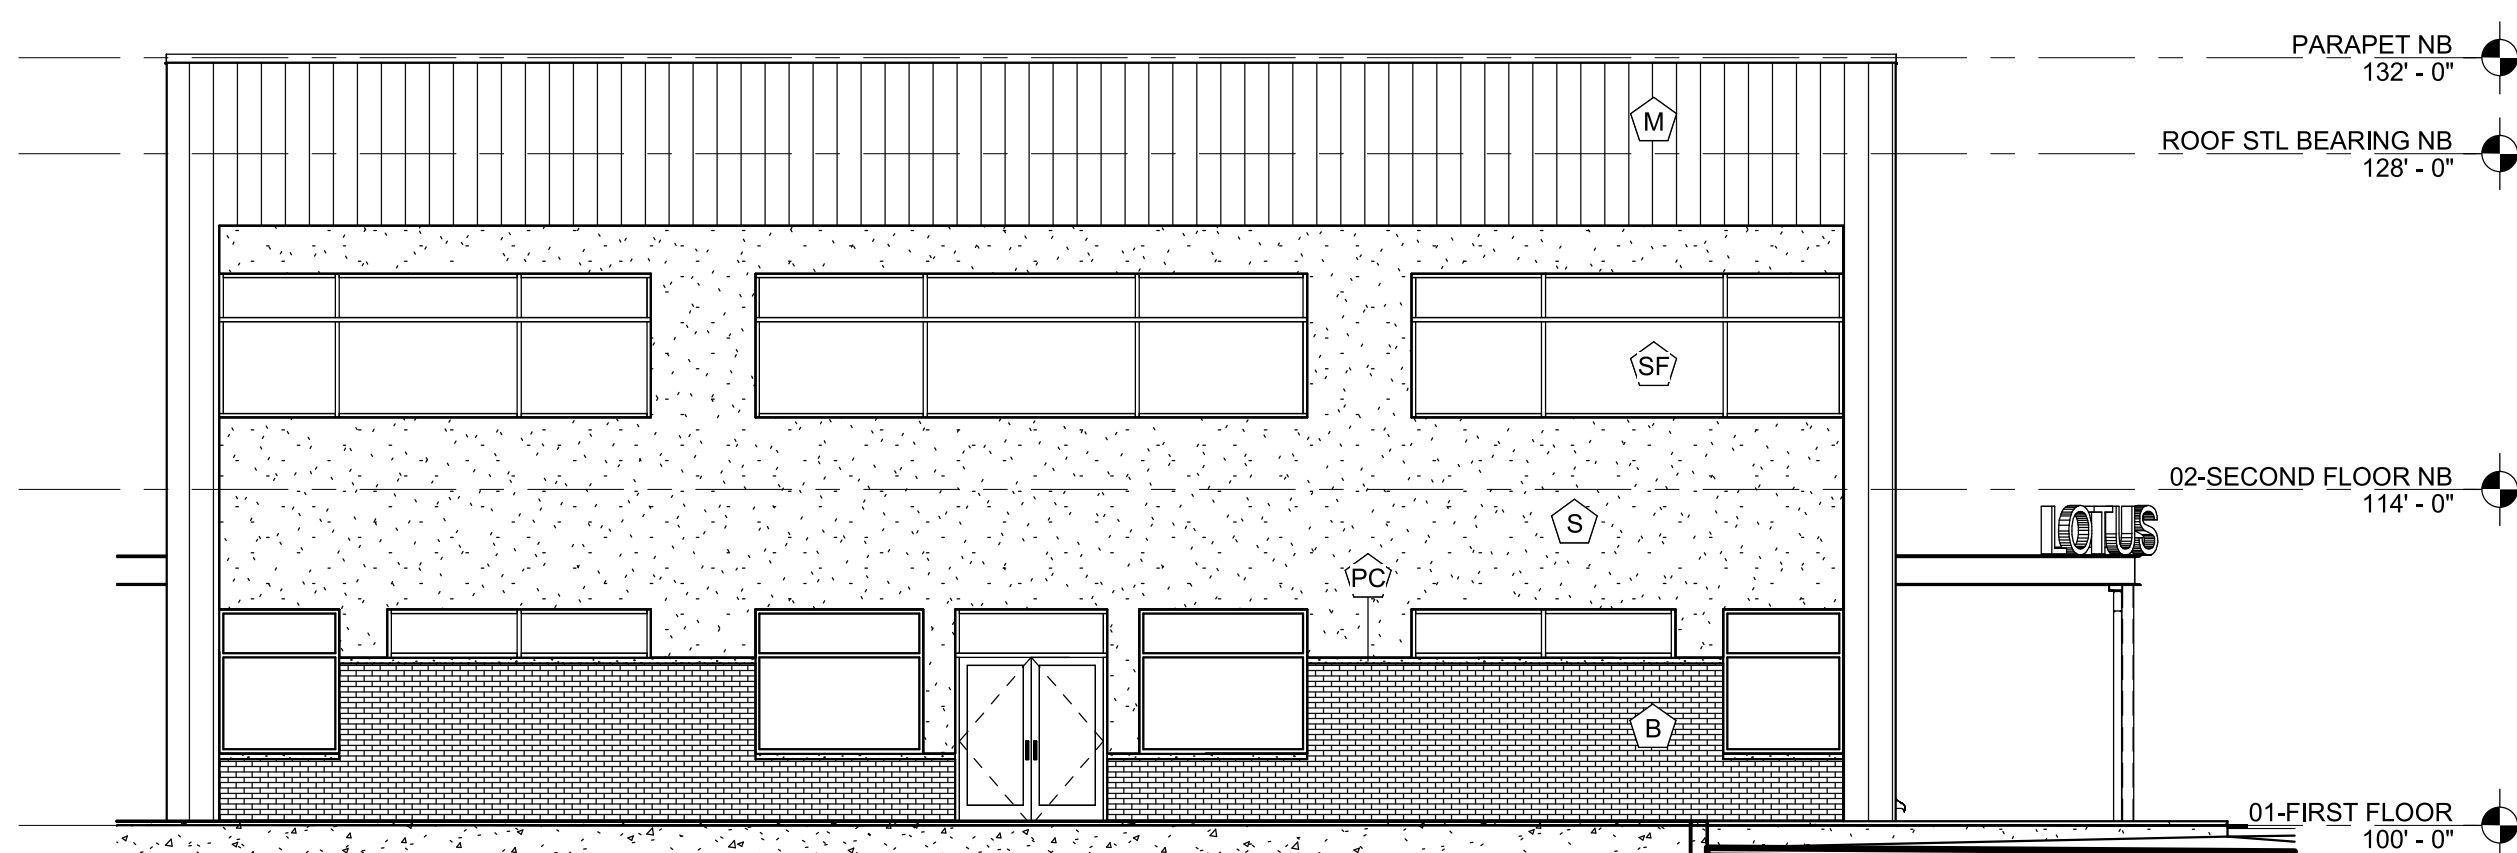

2 SOUTH ELEVATION  
SCALE: 1/8" = 1'-0"

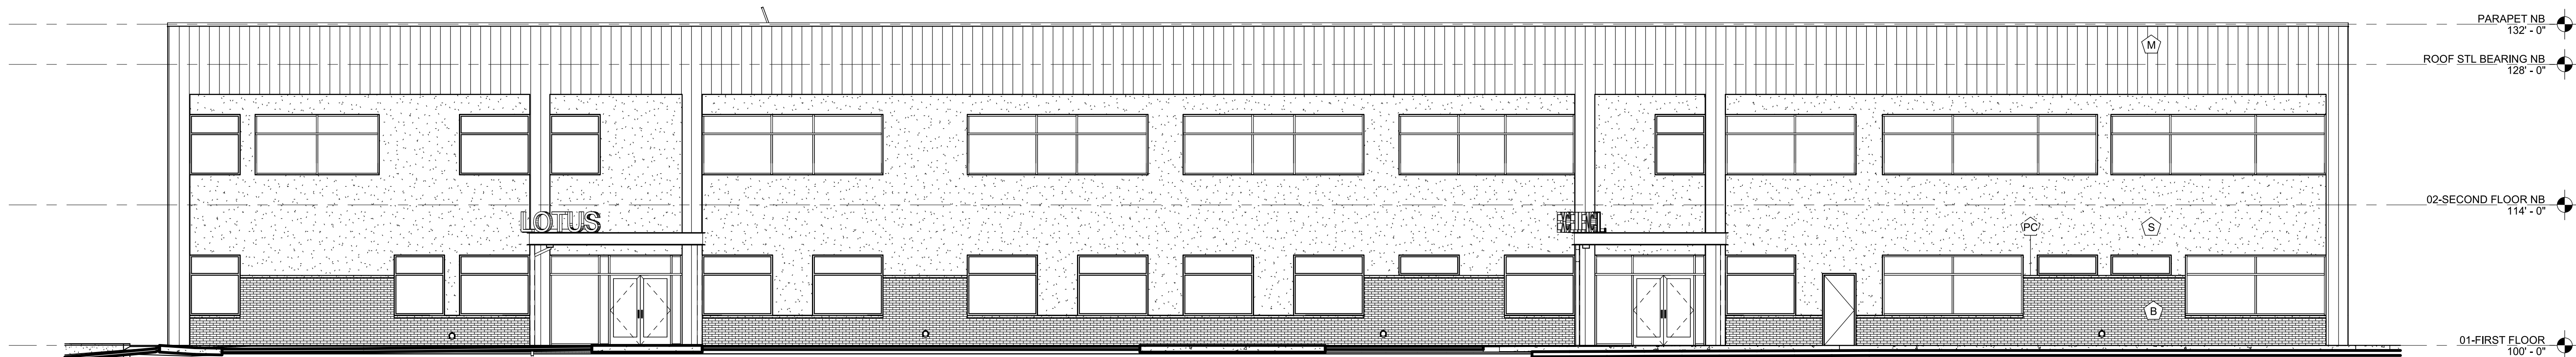

3 EAST ELEVATION  
SCALE: 1/8" = 1'-0"

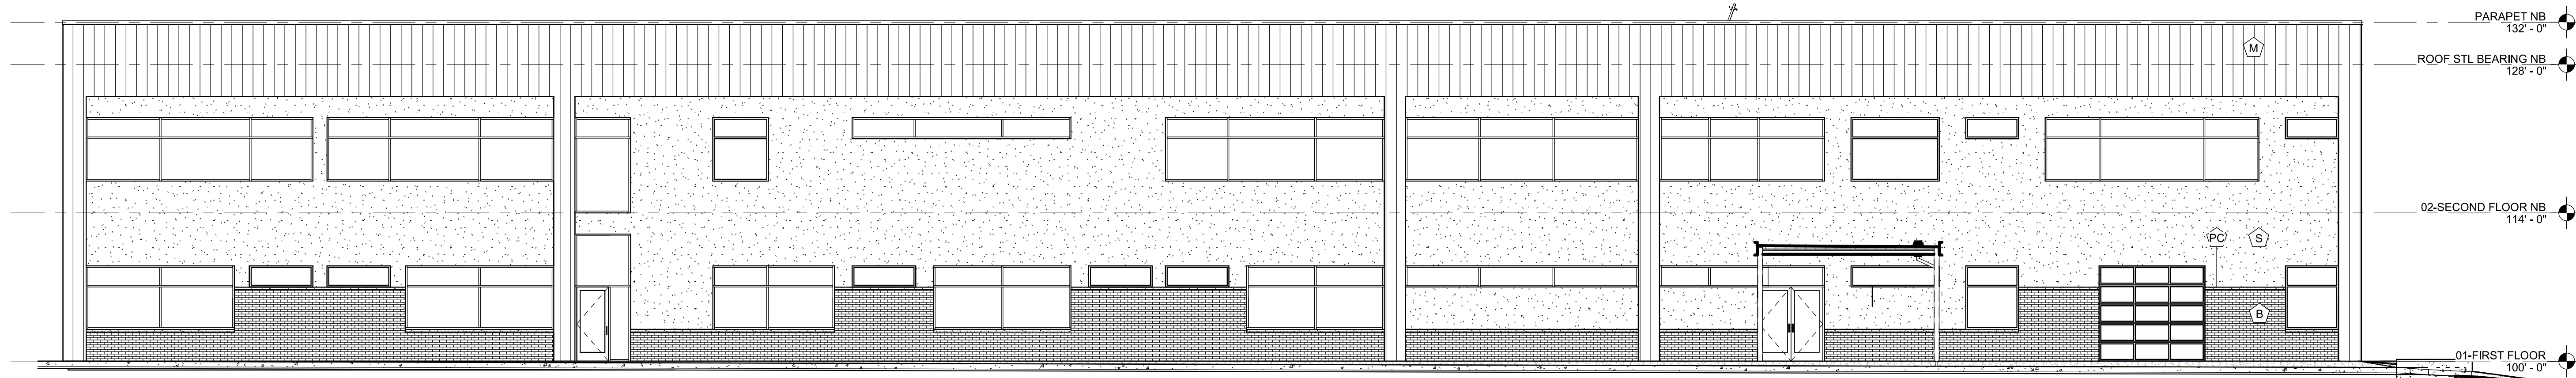

4 WEST ELEVATION  
SCALE: 1/8" = 1'-0"

LOTUS SCHOOL FOR EXCELLENCE

DATE	DESC.
11/11/2024	PREAPP
03/12/2025	MDLR CON DOC
03/26/2025	PRELIM
04/10/2025	DD
05/20/2025	MDLR RSPNS 1

SP-13  
EXTERIOR  
ELEVATIONS



