


KEYMAP  
1"=500'

LEGEND:

- PROPERTY LINE
- ▬ LIMITS OF PLANNING AREA
- ▬ PROPOSED BUILDING
- ▬ EXISTING BUILDING
- - - PROPOSED EASEMENT
- - - EXISTING EASEMENT
- ▬ PROPERTY SETBACK
- ▬ PROPOSED CURB & GUTTER
- ▬ EXISTING CURB & GUTTER
- - - PROPOSED SAWCUT
- ▨ PROPOSED ASPHALT
- ▨ PROPOSED WALK
- ☀ PROPOSED LIGHT POLE
- ☀ EXISTING LIGHT POLE
- PROPOSED SIGN
- EXISTING SIGN

NOTES:

1. ALL DIMENSIONS ARE TO FLOWLINE UNLESS OTHERWISE INDICATED.

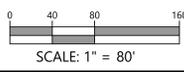

SEAL:

FOR AND ON BEHALF OF PROOF CIVIL CO.

REVISIONS

NO.	DATE	DESCRIPTION

PROJ. NO.:	24064
DATE:	
DRAWN BY:	ANM
CHECKED BY:	JGD

OVERALL SITE PLAN

LOTUS SCHOOL ADDITION  
LOTS 1 & 2 ASSEMBLY OF GOD FILING 3



COLORADO

AURORA

DRAWING NO.

SP-2



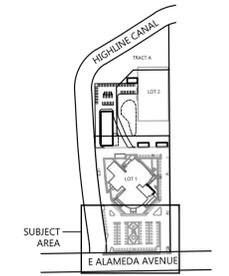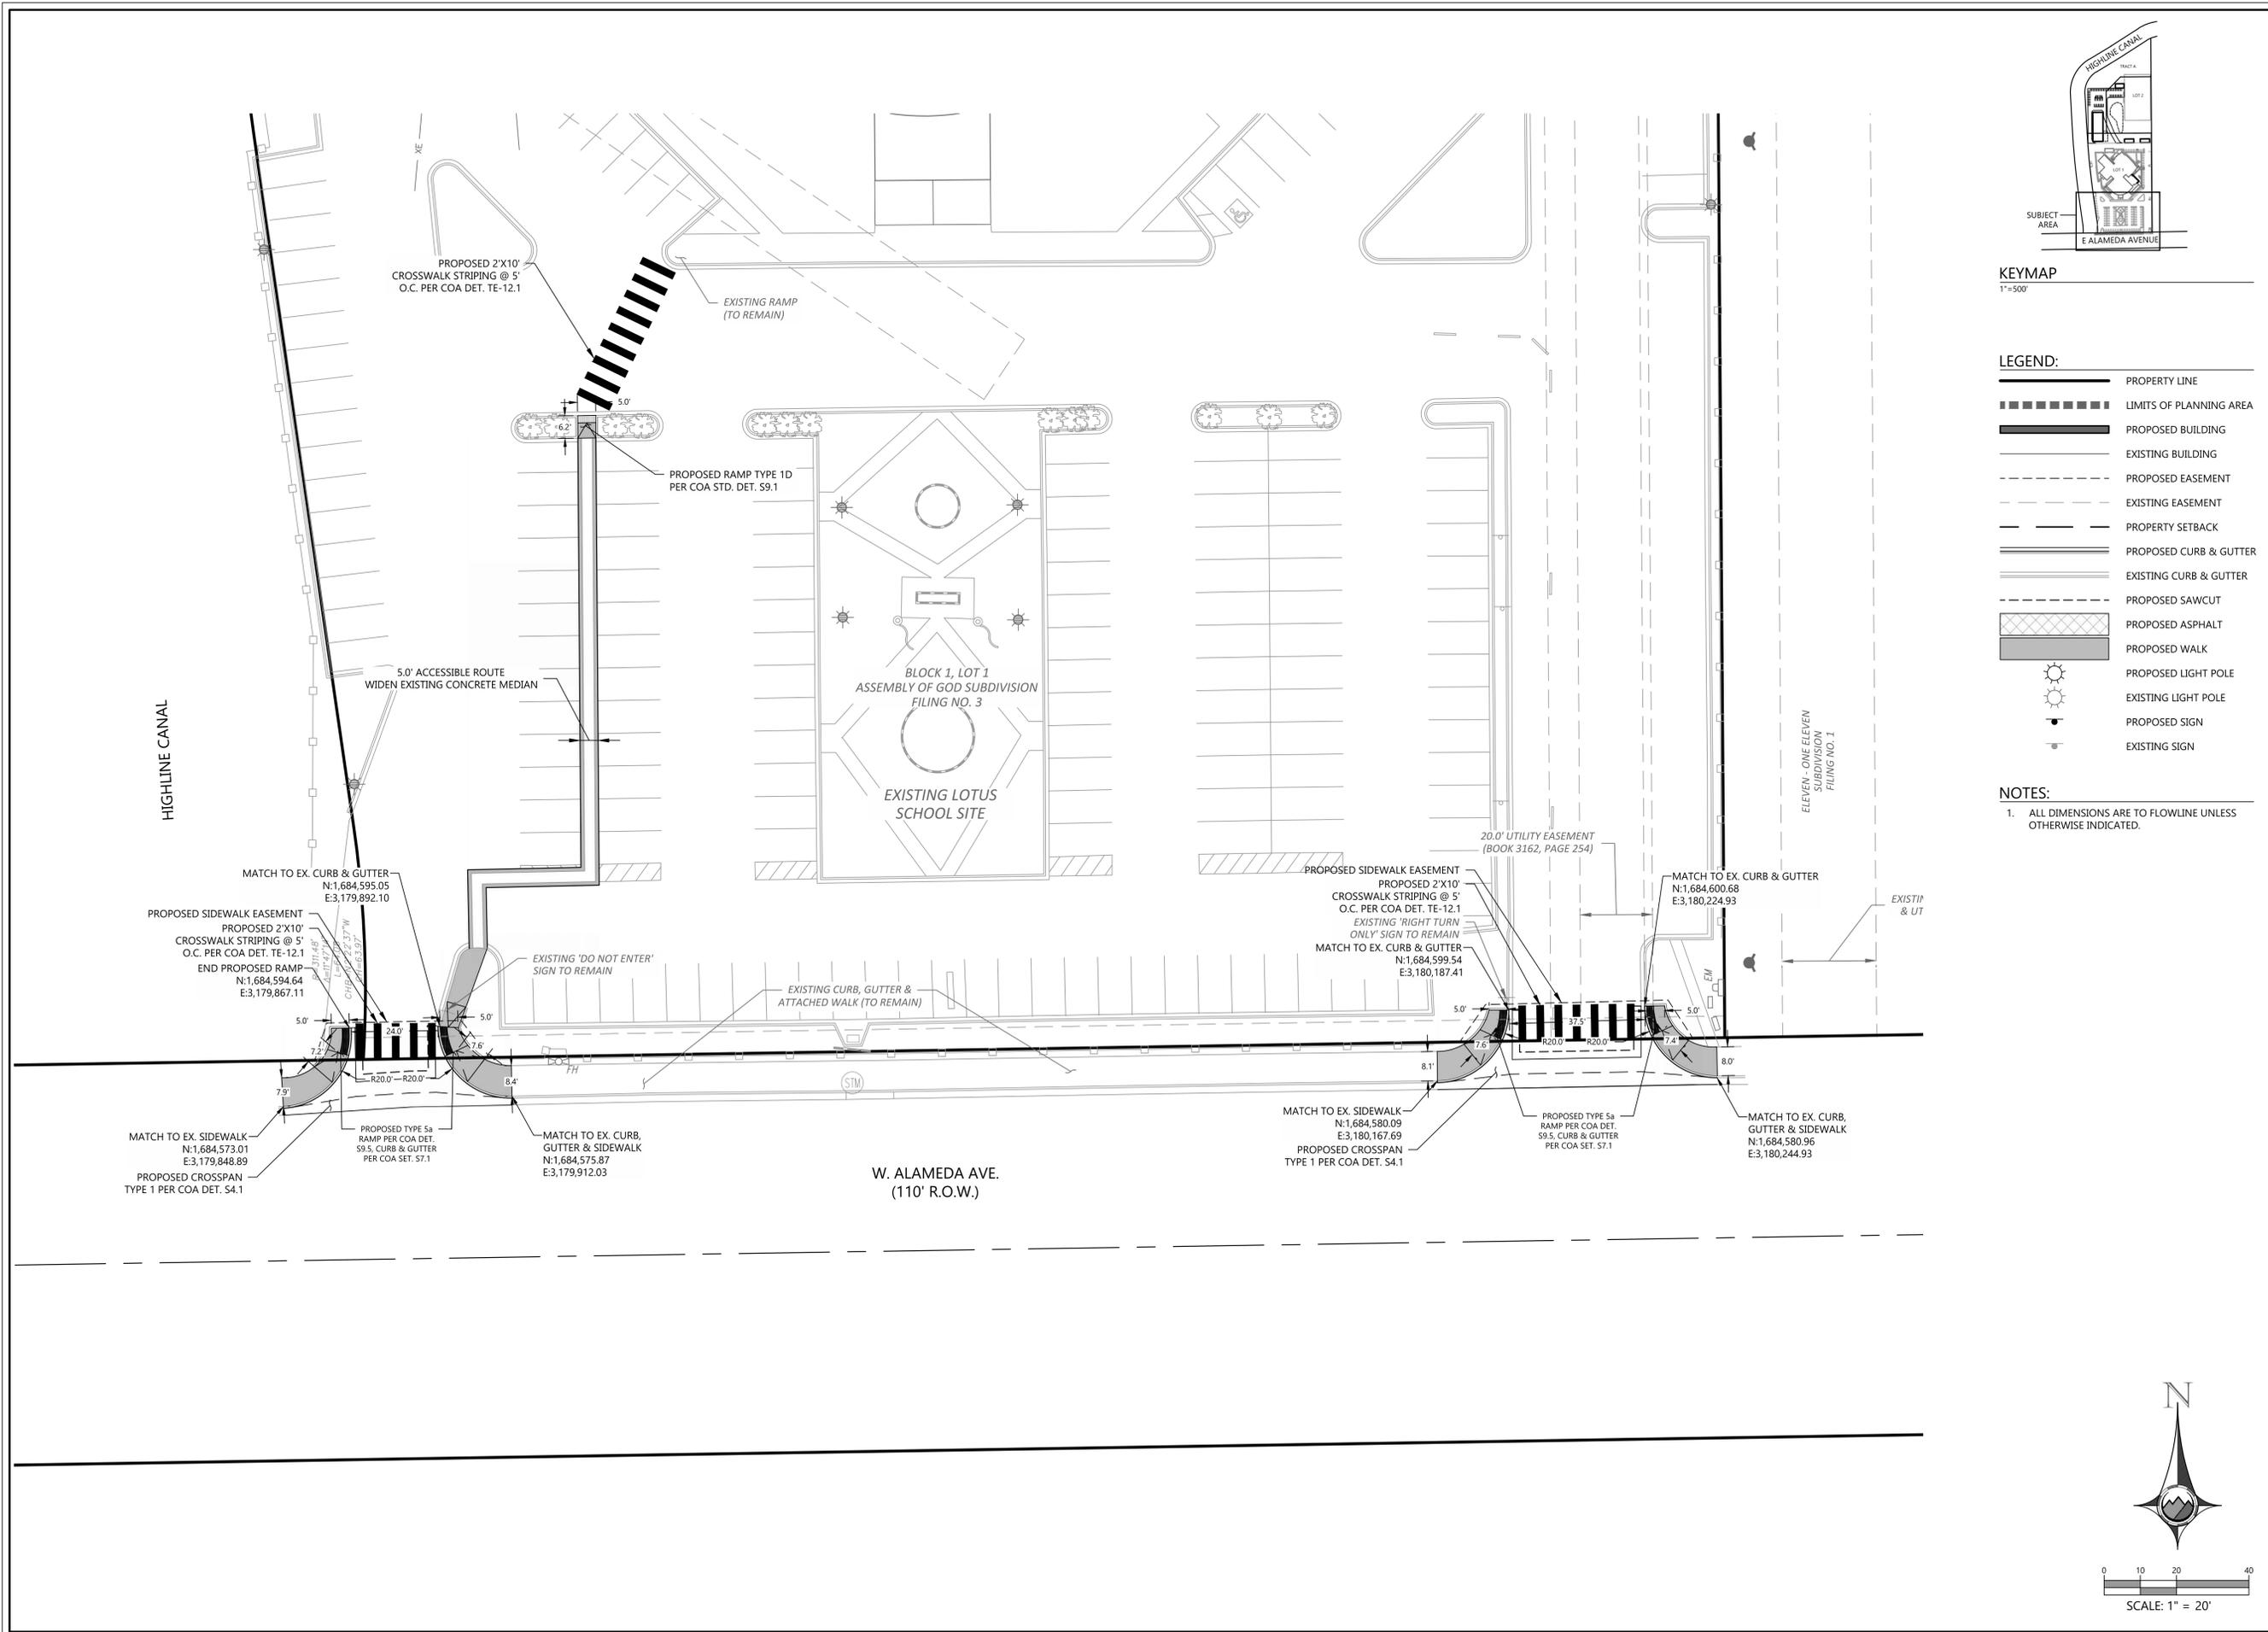

KEYMAP  
1"=500'

LEGEND:

- PROPERTY LINE
- ▬ LIMITS OF PLANNING AREA
- ▬ PROPOSED BUILDING
- ▬ EXISTING BUILDING
- - - PROPOSED EASEMENT
- - - EXISTING EASEMENT
- PROPERTY SETBACK
- ▬ PROPOSED CURB & GUTTER
- ▬ EXISTING CURB & GUTTER
- - - PROPOSED SAWCUT
- ▨ PROPOSED ASPHALT
- ▨ PROPOSED WALK
- ☀ PROPOSED LIGHT POLE
- ☀ EXISTING LIGHT POLE
- PROPOSED SIGN
- EXISTING SIGN

NOTES:

1. ALL DIMENSIONS ARE TO FLOWLINE UNLESS OTHERWISE INDICATED.

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**SITE PLAN II**

**LOTUS SCHOOL ADDITION**  
LOTS 1 & 2 ASSEMBLY OF GOD FILING 3


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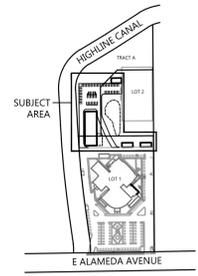
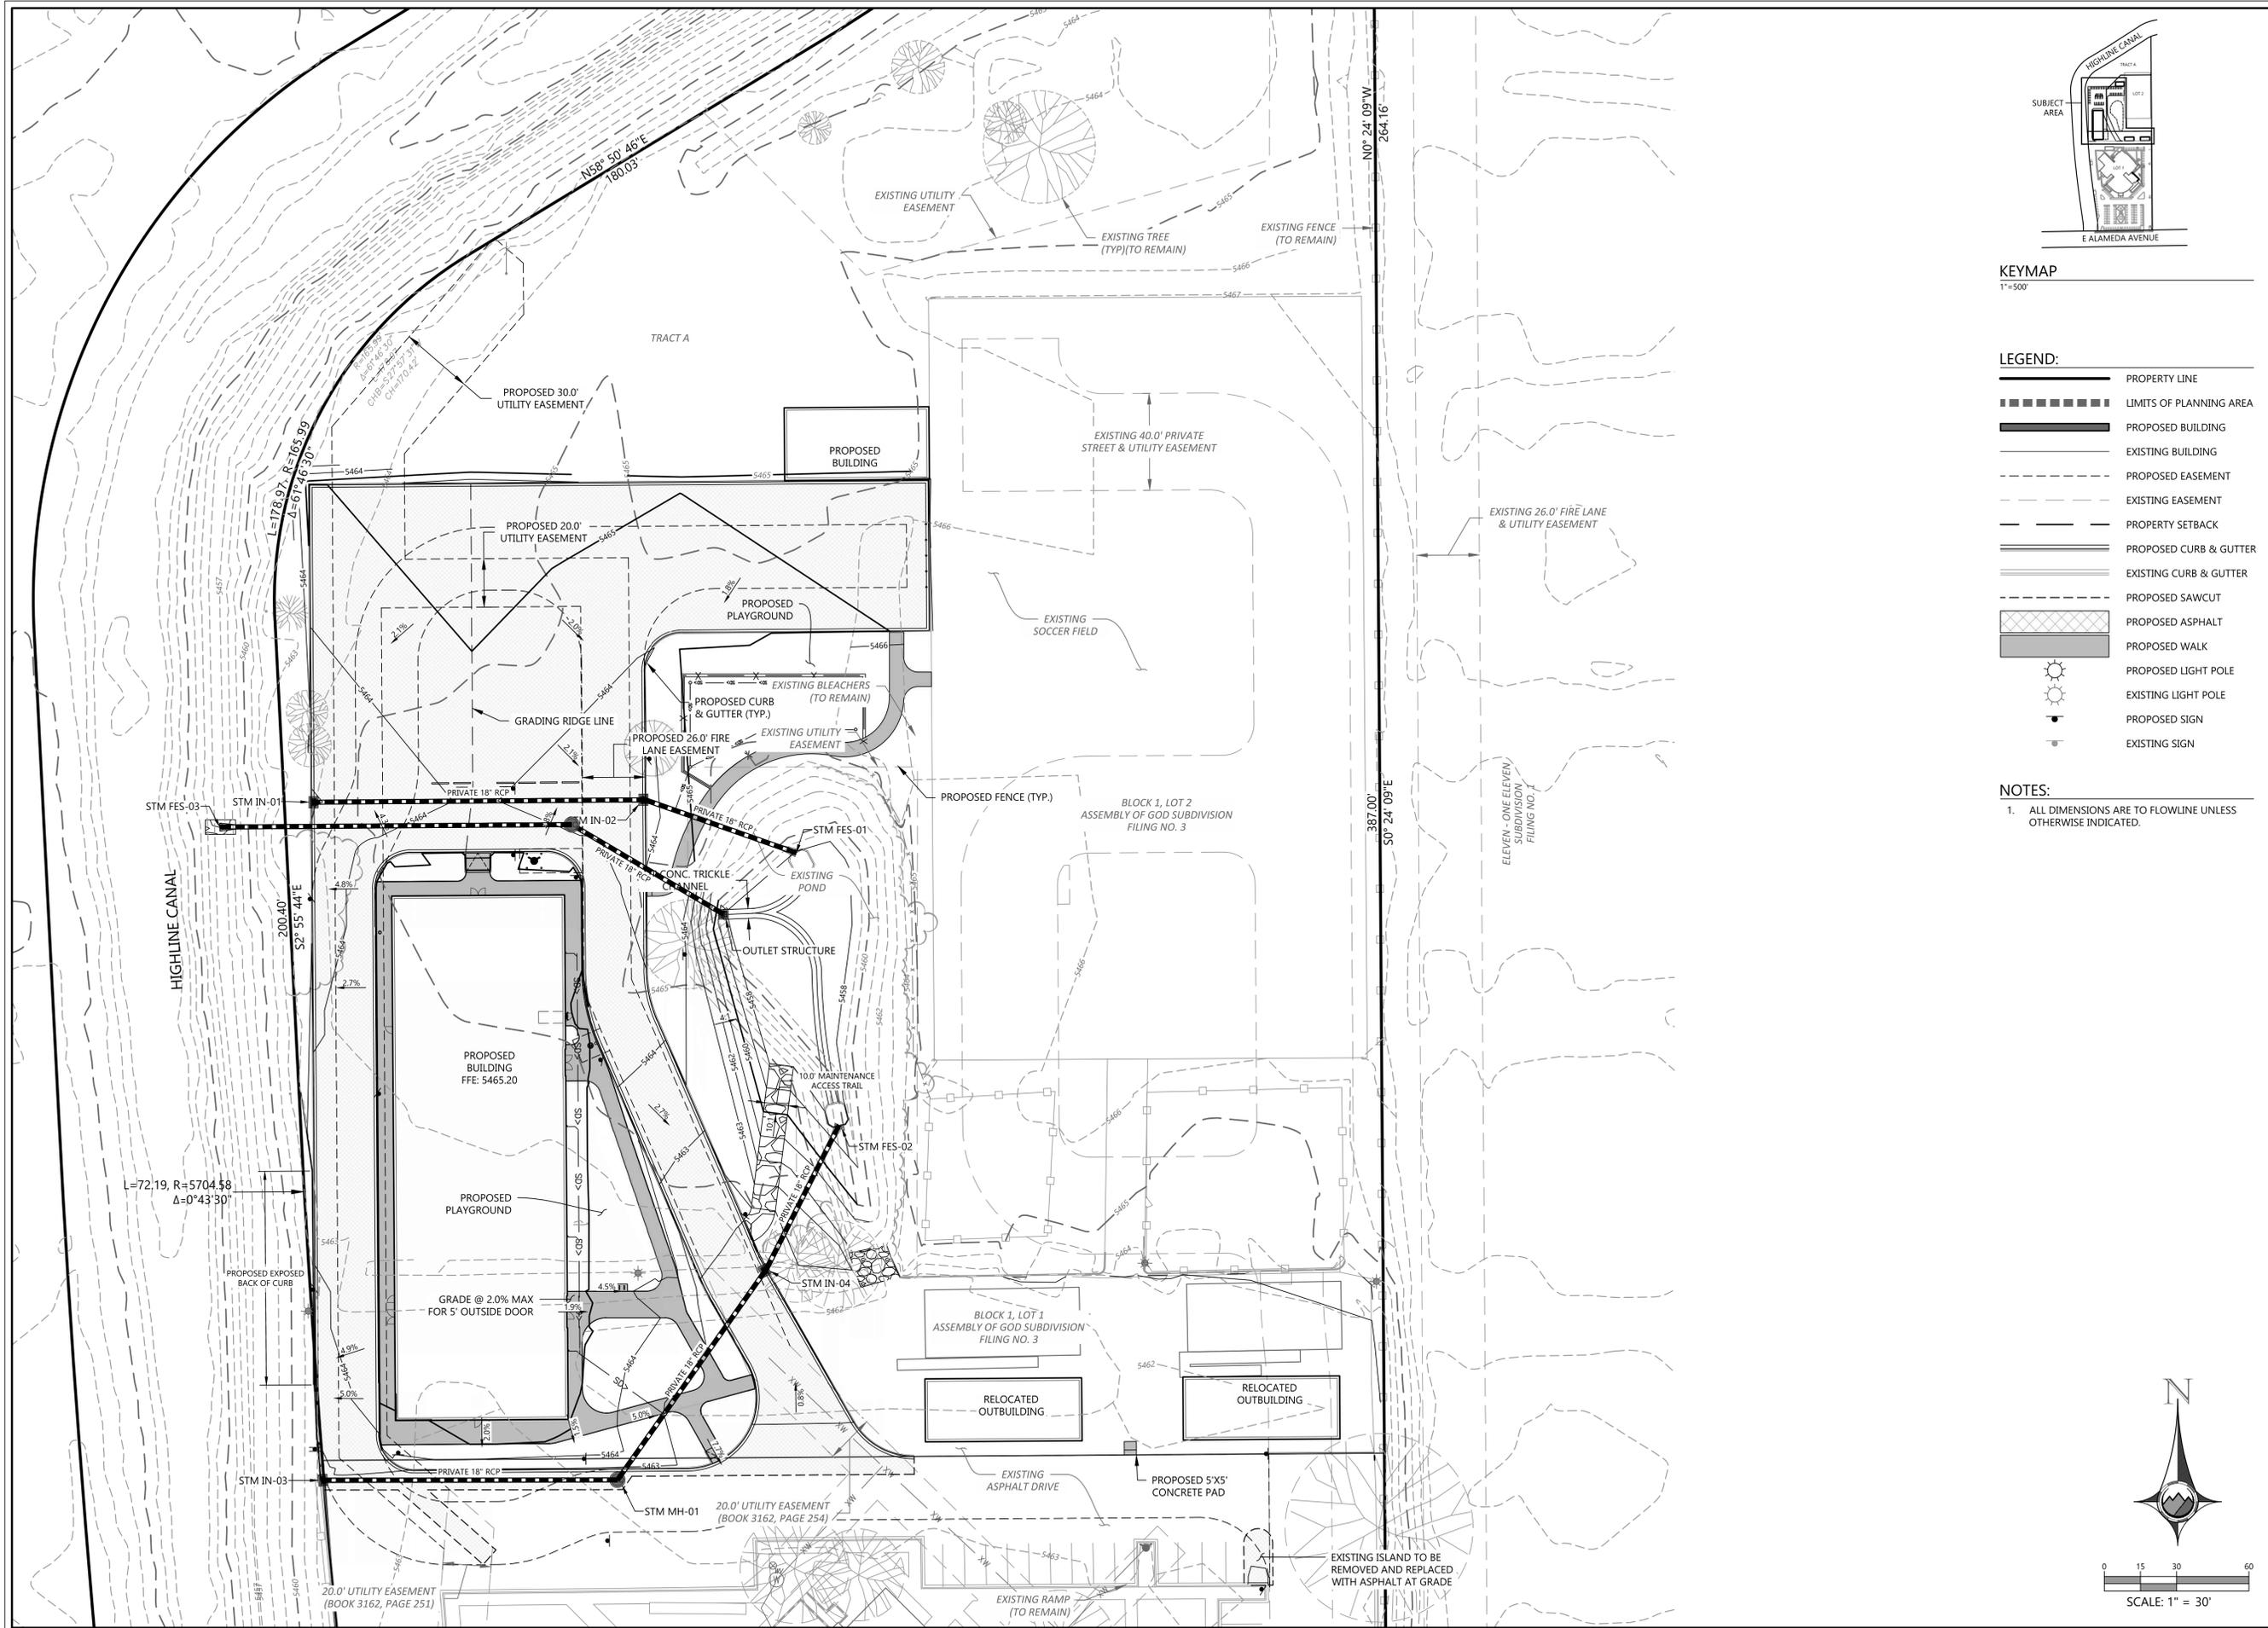
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AURORA

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DRAWING NO. **SP-4**





KEYMAP  
1"=500'

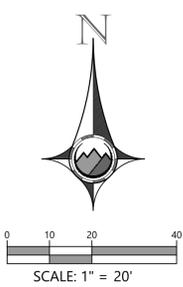LEGEND:

- PROPERTY LINE
- LIMITS OF PLANNING AREA
- PROPOSED BUILDING
- EXISTING BUILDING
- PROPOSED EASEMENT
- EXISTING EASEMENT
- PROPERTY SETBACK
- PROPOSED CURB & GUTTER
- EXISTING CURB & GUTTER
- PROPOSED SAWCUT
- PROPOSED ASPHALT
- PROPOSED WALK
- PROPOSED LIGHT POLE
- EXISTING LIGHT POLE
- PROPOSED SIGN
- EXISTING SIGN

NOTES:

1. ALL DIMENSIONS ARE TO FLOWLINE UNLESS OTHERWISE INDICATED.

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REVISIONS		NO.	DATE	DESCRIPTION

PROJ. NO.: 24064	DATE: _____	DRAWN BY: ANM	CHECKED BY: JGD
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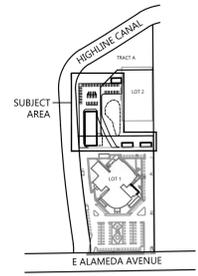
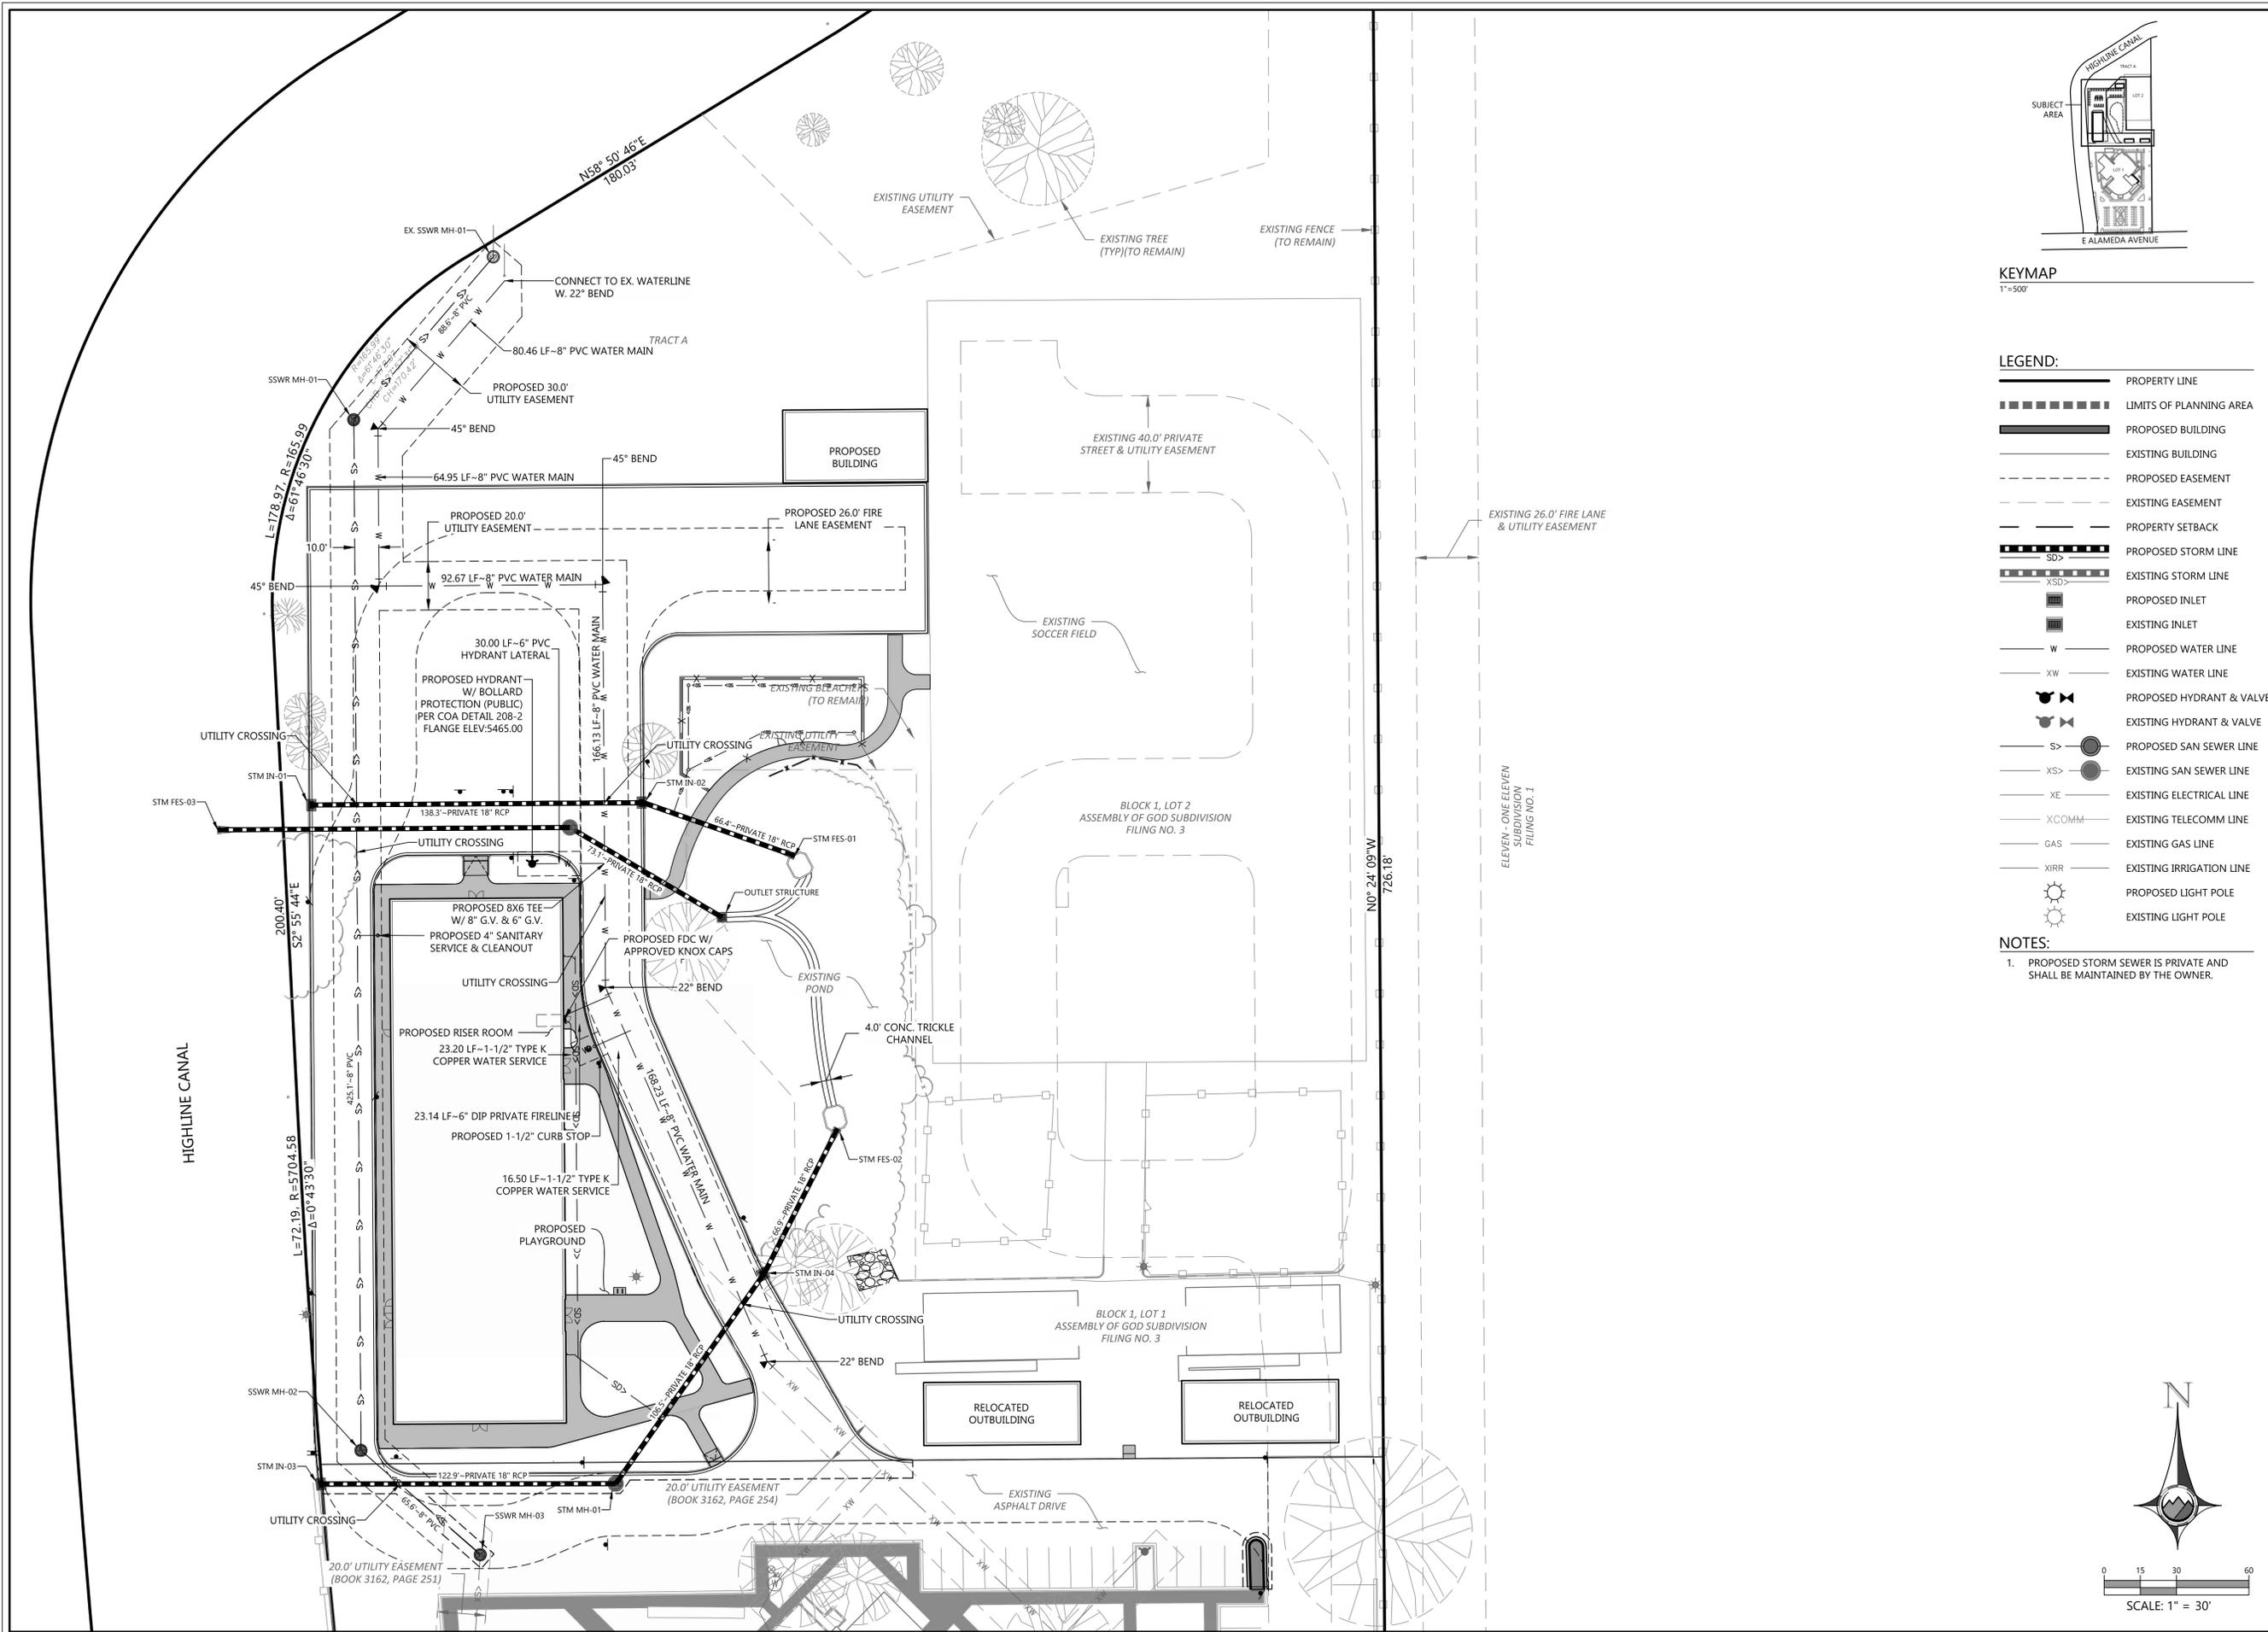
**GRADING PLAN**

**LOTUS SCHOOL ADDITION**  
LOTS 1 & 2 ASSEMBLY OF GOD FILING 3

AURORA COLORADO

DRAWING NO. **SP-5**






**LEGEND:**

	PROPERTY LINE
	LIMITS OF PLANNING AREA
	PROPOSED BUILDING
	EXISTING BUILDING
	PROPOSED EASEMENT
	EXISTING EASEMENT
	PROPERTY SETBACK
	PROPOSED STORM LINE
	EXISTING STORM LINE
	PROPOSED INLET
	EXISTING INLET
	PROPOSED WATER LINE
	EXISTING WATER LINE
	PROPOSED HYDRANT & VALVE
	EXISTING HYDRANT & VALVE
	PROPOSED SAN SEWER LINE
	EXISTING SAN SEWER LINE
	EXISTING ELECTRICAL LINE
	EXISTING TELECOMM LINE
	EXISTING GAS LINE
	EXISTING IRRIGATION LINE
	PROPOSED LIGHT POLE
	EXISTING LIGHT POLE

**NOTES:**

- PROPOSED STORM SEWER IS PRIVATE AND SHALL BE MAINTAINED BY THE OWNER.

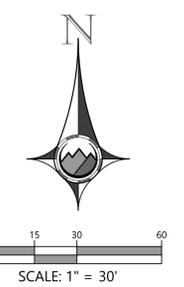

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**UTILITY PLAN**


**LOTUS SCHOOL ADDITION**  
LOTS 1 & 2 ASSEMBLY OF GOD FILING 3

AURORA    COLORADO

DRAWING NO. **SP-7**

By: Author

3/28/2025 11:10:47 AM

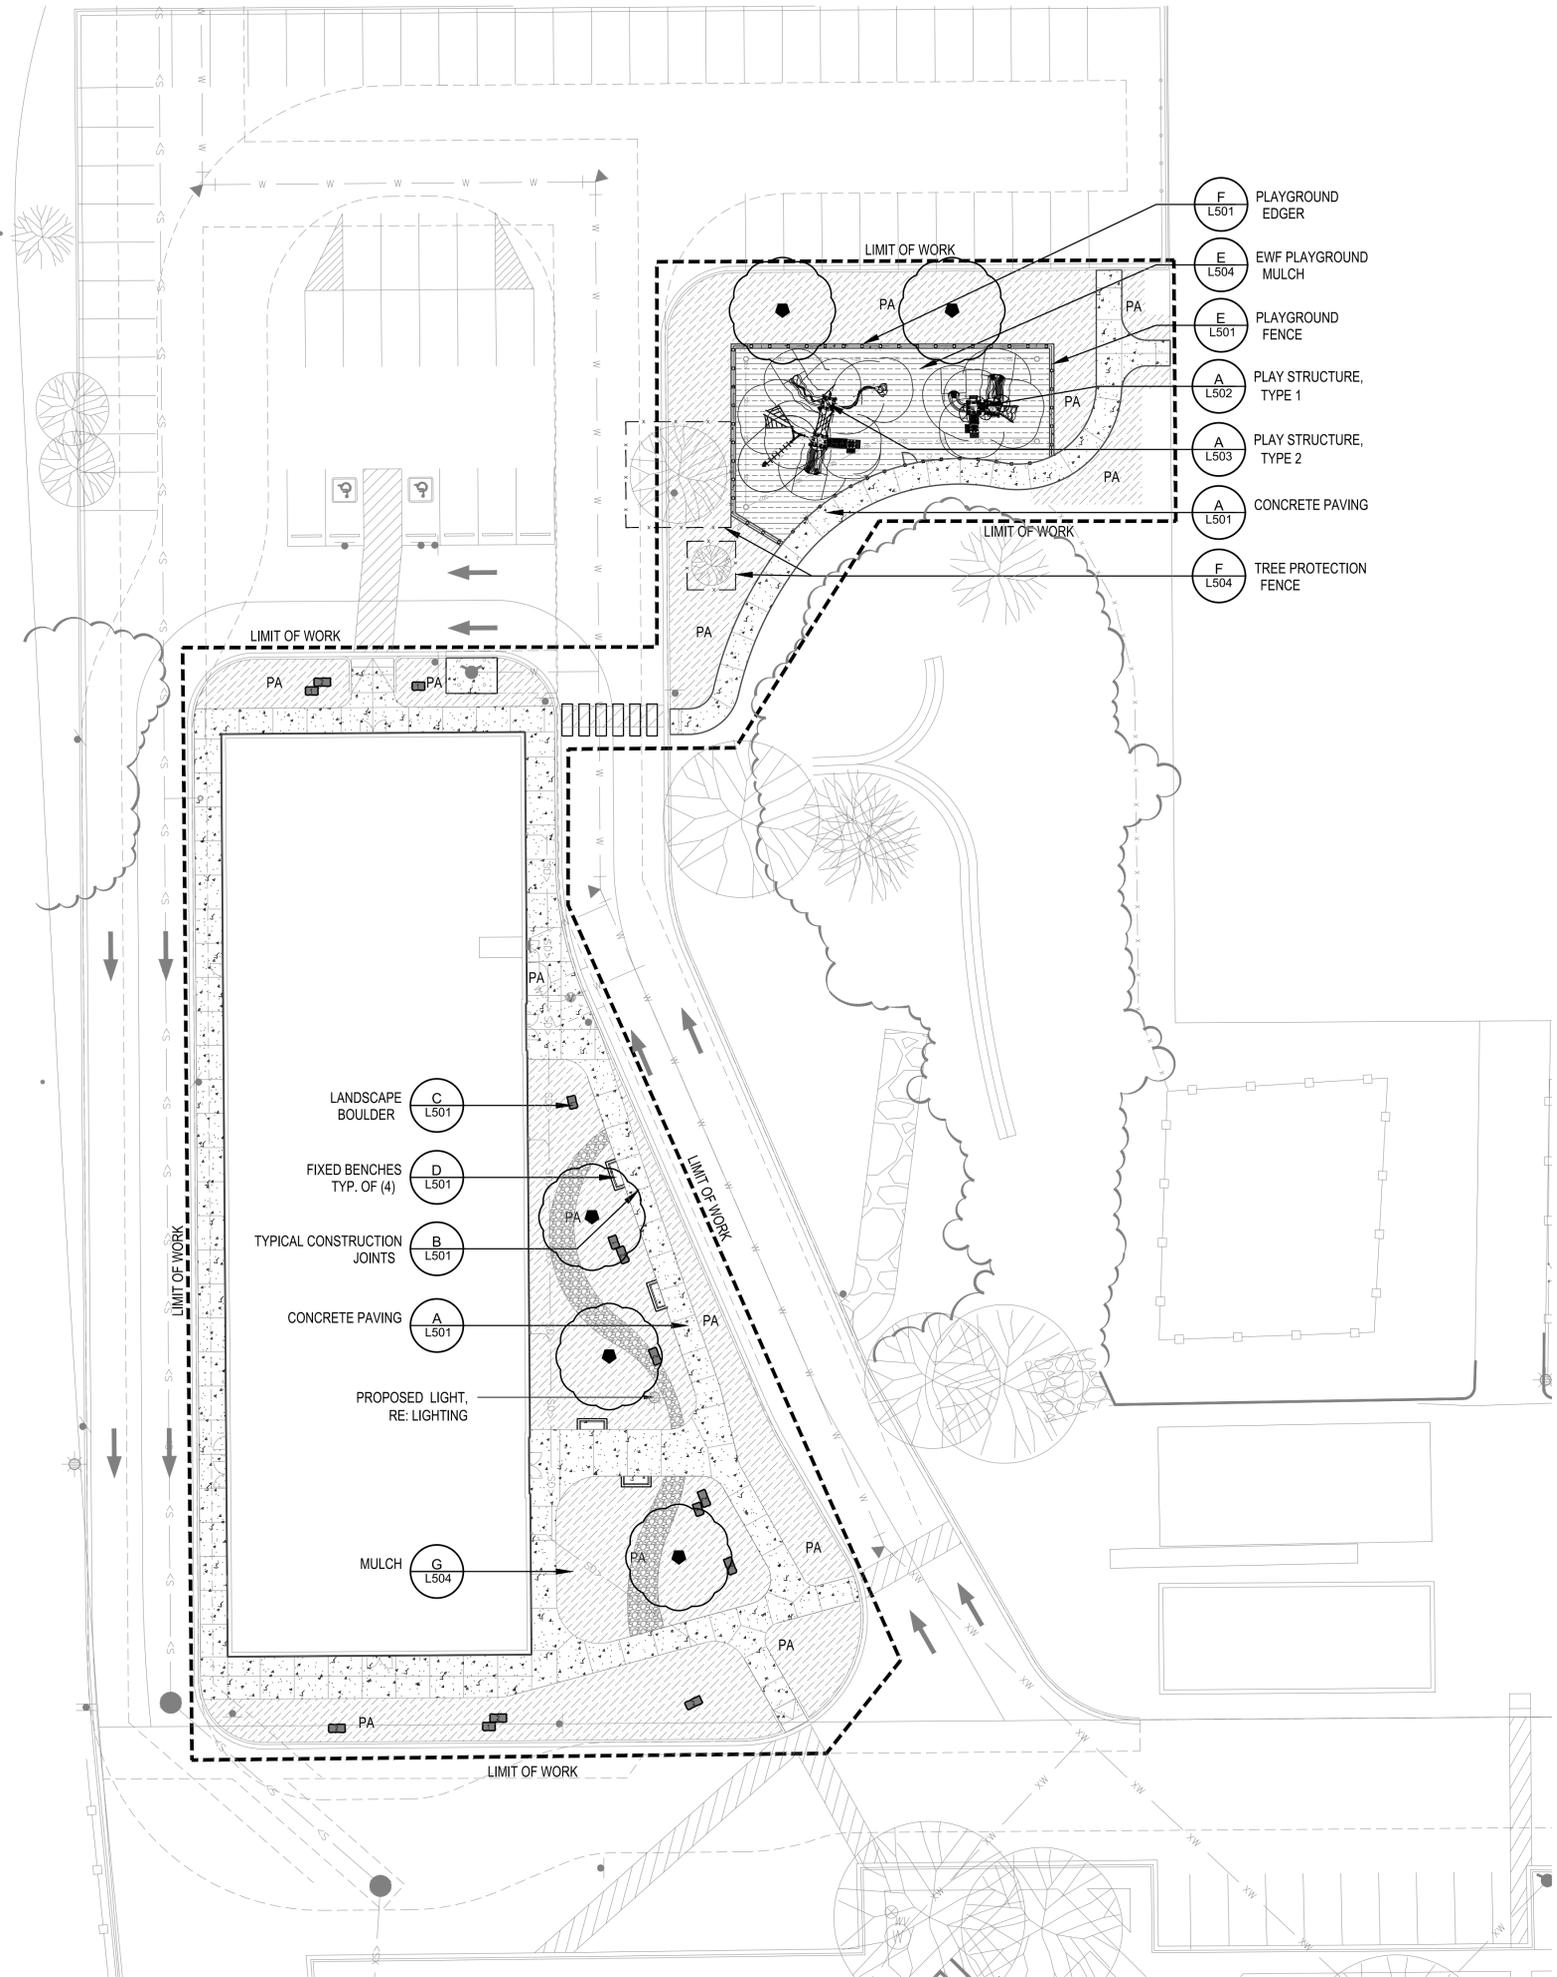

**SITE LEGEND:**

--- LIMIT OF WORK

**PLANTING**

EXISTING TREES TO REMAIN AND BE PROTECTED

**PAVING**

CONCRETE PAVING  
COLOR: STANDARD GRAY  
FINISH: LIGHT BROOM

**FURNISHINGS**

FIXED BENCH

**PLANTING AREA**

PA PLANTING AREA  
WOOD MULCH  
3" THICK SHREDDED CEDAR MULCH (NO LANDSCAPE FABRIC)

3" ROCK MULCH  
2-4" GLACIER WHITE RIVER ROCK

ENGINEERED WOOD FIBER MULCH  
1,000 SF

PLAYGROUND FENCE

TREE PROTECTION FENCE

**BOULDER SCHEDULE**

SYM	SIZE (LxWxH)	QTY
■	3'x2'x2'	6
■	4'x2'x2'	8


- GENERAL LANDSCAPE NOTES:**
- ALL SIDEWALKS AND RAMPS MUST CONFORM TO CITY STANDARDS. ACCESSIBLE RAMPS MUST BE PROVIDED AT ALL STREET AND DRIVE INTERSECTIONS AND AT ALL DESIGNATED ACCESSIBLE PARKING SPACES. ACCESSIBLE PARKING SPACES MUST SLOPE NO MORE THAN 1:48 IN ANY DIRECTION. ALL ACCESSIBLE ROUTES MUST SLOPE NO MORE THAN 1:20 IN DIRECTION OF TRAVEL AND WITH NO MORE THAN 1:48 CROSS SLOPE.
  - ALL UTILITY EASEMENTS SHALL REMAIN UNOBSTRUCTED AND FULLY ACCESSIBLE ALONG THEIR ENTIRE LENGTH FOR MAINTENANCE EQUIPMENT ENTRY.
  - ALL EXTERIOR LIGHTING PROVIDED SHALL COMPLY WITH THE FOOT-CANDLE REQUIREMENTS AND SHALL USE A CONCEALED, FULLY SHIELDED LIGHT SOURCE WITH SHARP CUT-OFF CAPABILITY SO AS TO MINIMIZE UP-LIGHT, SPILL LIGHT, GLARE AND UNNECESSARY DIFFUSION.
  - REFER TO FINAL UTILITY PLANS FOR EXACT LOCATIONS AND CONSTRUCTION INFORMATION FOR STORM DRAINAGE STRUCTURES, UTILITY MAINS AND SERVICES, PROPOSED TOPOGRAPHY, STREET IMPROVEMENTS, TOPSOIL: TO THE MAXIMUM EXTENT FEASIBLE, TOPSOIL THAT IS REMOVED DURING CONSTRUCTION ACTIVITY SHALL BE CONSERVED FOR LATER USE ON AREAS REQUIRING REVEGETATION AND LANDSCAPING.
  - SOIL AMENDMENTS: SOIL AMENDMENT SHALL BE THOROUGHLY INCORPORATED INTO THE SOIL OF ALL LANDSCAPE AREAS, INCLUDING PARKWAYS AND MEDIANS, SHALL BE THOROUGHLY LOOSENED TO A DEPTH OF NOT LESS THAN EIGHT(8) INCHES AND SOIL AMENDMENT SHALL BE THOROUGHLY INCORPORATED INTO THE SOIL OF ALL LANDSCAPE AREAS TO A DEPTH OF AT LEAST SIX(6) INCHES BY TILLING, DISCING OR OTHER SUITABLE METHOD, AT A RATE OF AT LEAST THREE (3) CUBIC YARDS OF SOIL AMENDMENT PER ONE THOUSAND (1,000) SQUARE FEET OF LANDSCAPE AREA, PRIOR TO THE ISSUANCE OF ANY CERTIFICATE OF OCCUPANCY. A WRITTEN CERTIFICATION MUST BE SUBMITTED TO THE CITY THAT ALL PLANTED AREAS, OR AREAS TO BE PLANTED, HAVE BEEN THOROUGHLY LOOSENED AND THE SOIL AMENDED, CONSISTENT WITH THE REQUIREMENTS SET FORTH IN SECTION 12-132.
  - INSTALLATION AND GUARANTEE: ALL LANDSCAPING SHALL BE INSTALLED ACCORDING TO SOUND HORTICULTURAL PRACTICES IN A MANNER DESIGNED TO ENCOURAGE QUICK ESTABLISHMENT AND HEALTHY GROWTH. ALL LANDSCAPING FOR EACH PHASE MUST BE EITHER INSTALLED OR THE INSTALLATION MUST BE SECURED WITH AN IRREVOCABLE LETTER OF CREDIT, PERFORMANCE BOND, OR ESCROW ACCOUNT FOR 125% OF THE VALUATION OF THE MATERIALS AND LABOR PRIOR TO ISSUANCE OF A CERTIFICATE OF OCCUPANCY FOR ANY BUILDING IN SUCH PHASE.
  - MAINTENANCE: TREES AND VEGETATION, IRRIGATION SYSTEMS, FENCES, WALLS AND OTHER LANDSCAPE ELEMENTS WITH THESE FINAL PLANS SHALL BE CONSIDERED AS ELEMENTS OF THE PROJECT IN THE SAME MANNER AS PARKING, BUILDING MATERIALS AND OTHER SITE DETAILS. THE APPLICANT, LANDOWNER OR SUCCESSORS IN INTEREST SHALL BE JOINTLY AND SEVERALLY RESPONSIBLE FOR THE REGULAR MAINTENANCE OF ALL LANDSCAPING ELEMENTS IN GOOD CONDITION. ALL LANDSCAPING SHALL BE MAINTAINED FREE FROM DISEASE, PESTS, WEEDS AND LITTER, AND ALL LANDSCAPE STRUCTURES SUCH AS FENCES AND WALLS SHALL BE REPAIRED AND REPLACED PERIODICALLY TO MAINTAIN A STRUCTURALLY SOUND CONDITION.
  - REPLACEMENT: ANY LANDSCAPE ELEMENT THAT DIES, OR IS OTHERWISE REMOVED, SHALL BE PROMPTLY REPLACED IN ACCORDANCE WITH THE REQUIREMENTS OF THESE PLANS.
  - ALL STREET TREES SHALL BE PLACED A MINIMUM EIGHT (8) FEET AWAY FROM THE EDGES OF DRIVEWAYS.
  - PLACEMENT OF ALL LANDSCAPING SHALL BE IN ACCORDANCE WITH THE SIGHT DISTANCE CRITERIA AS SPECIFIED BY CITY OF AURORA. NO STRUCTURES OR LANDSCAPE ELEMENTS GREATER THAN 24" SHALL BE ALLOWED WITHIN THE SIGHT DISTANCE TRIANGLE OR EASEMENTS WITH THE EXCEPTION OF DECIDUOUS TREES PROVIDED THAT THE LOWEST BRANCH IS AT LEAST 6' FROM GRADE. ANY FENCES WITHIN THE SIGHT DISTANCE TRIANGLE OR EASEMENT MUST BE NOT MORE THAN 42" IN HEIGHT AND OF AN OPEN DESIGN.
  - THE FINAL LANDSCAPE PLAN SHALL BE COORDINATED WITH ALL OTHER FINAL PLAN ELEMENTS SO THAT THE PROPOSED GRADING, STORM DRAINAGE, AND OTHER DEVELOPMENT IMPROVEMENTS DO NOT CONFLICT WITH NOR PRECLUDE INSTALLATION AND MAINTENANCE OF LANDSCAPE ELEMENTS ON THIS PLAN.
  - MINOR CHANGES IN SPECIES AND PLANT LOCATIONS MAY BE MADE DURING CONSTRUCTION -- AS REQUIRED BY SITE CONDITIONS OR PLANT AVAILABILITY. OVERALL QUANTITY, QUALITY, AND DESIGN CONCEPT MUST BE CONSISTENT WITH THE APPROVED PLANS. IN THE EVENT OF CONFLICT WITH THE QUANTITIES INCLUDED IN THE PLANT LIST, SPECIES AND QUANTITIES ILLUSTRATED SHALL BE PROVIDED. ALL CHANGES OF PLANT SPECIES AND LOCATION MUST HAVE WRITTEN APPROVAL BY THE CITY PRIOR TO INSTALLATION.
  - ALL PLANTING BEDS SHALL BE MULCHED TO A MINIMUM DEPTH OF THREE INCHES.



DATE	DESC.
11/11/2024	PREAPP
03/12/2025	MDR CON DOC
03/26/2025	PRELIM
05/15/2025	BID SET
05/23/2025	CITY SUB.

By: Author

3/28/2025 11:10:47 AM

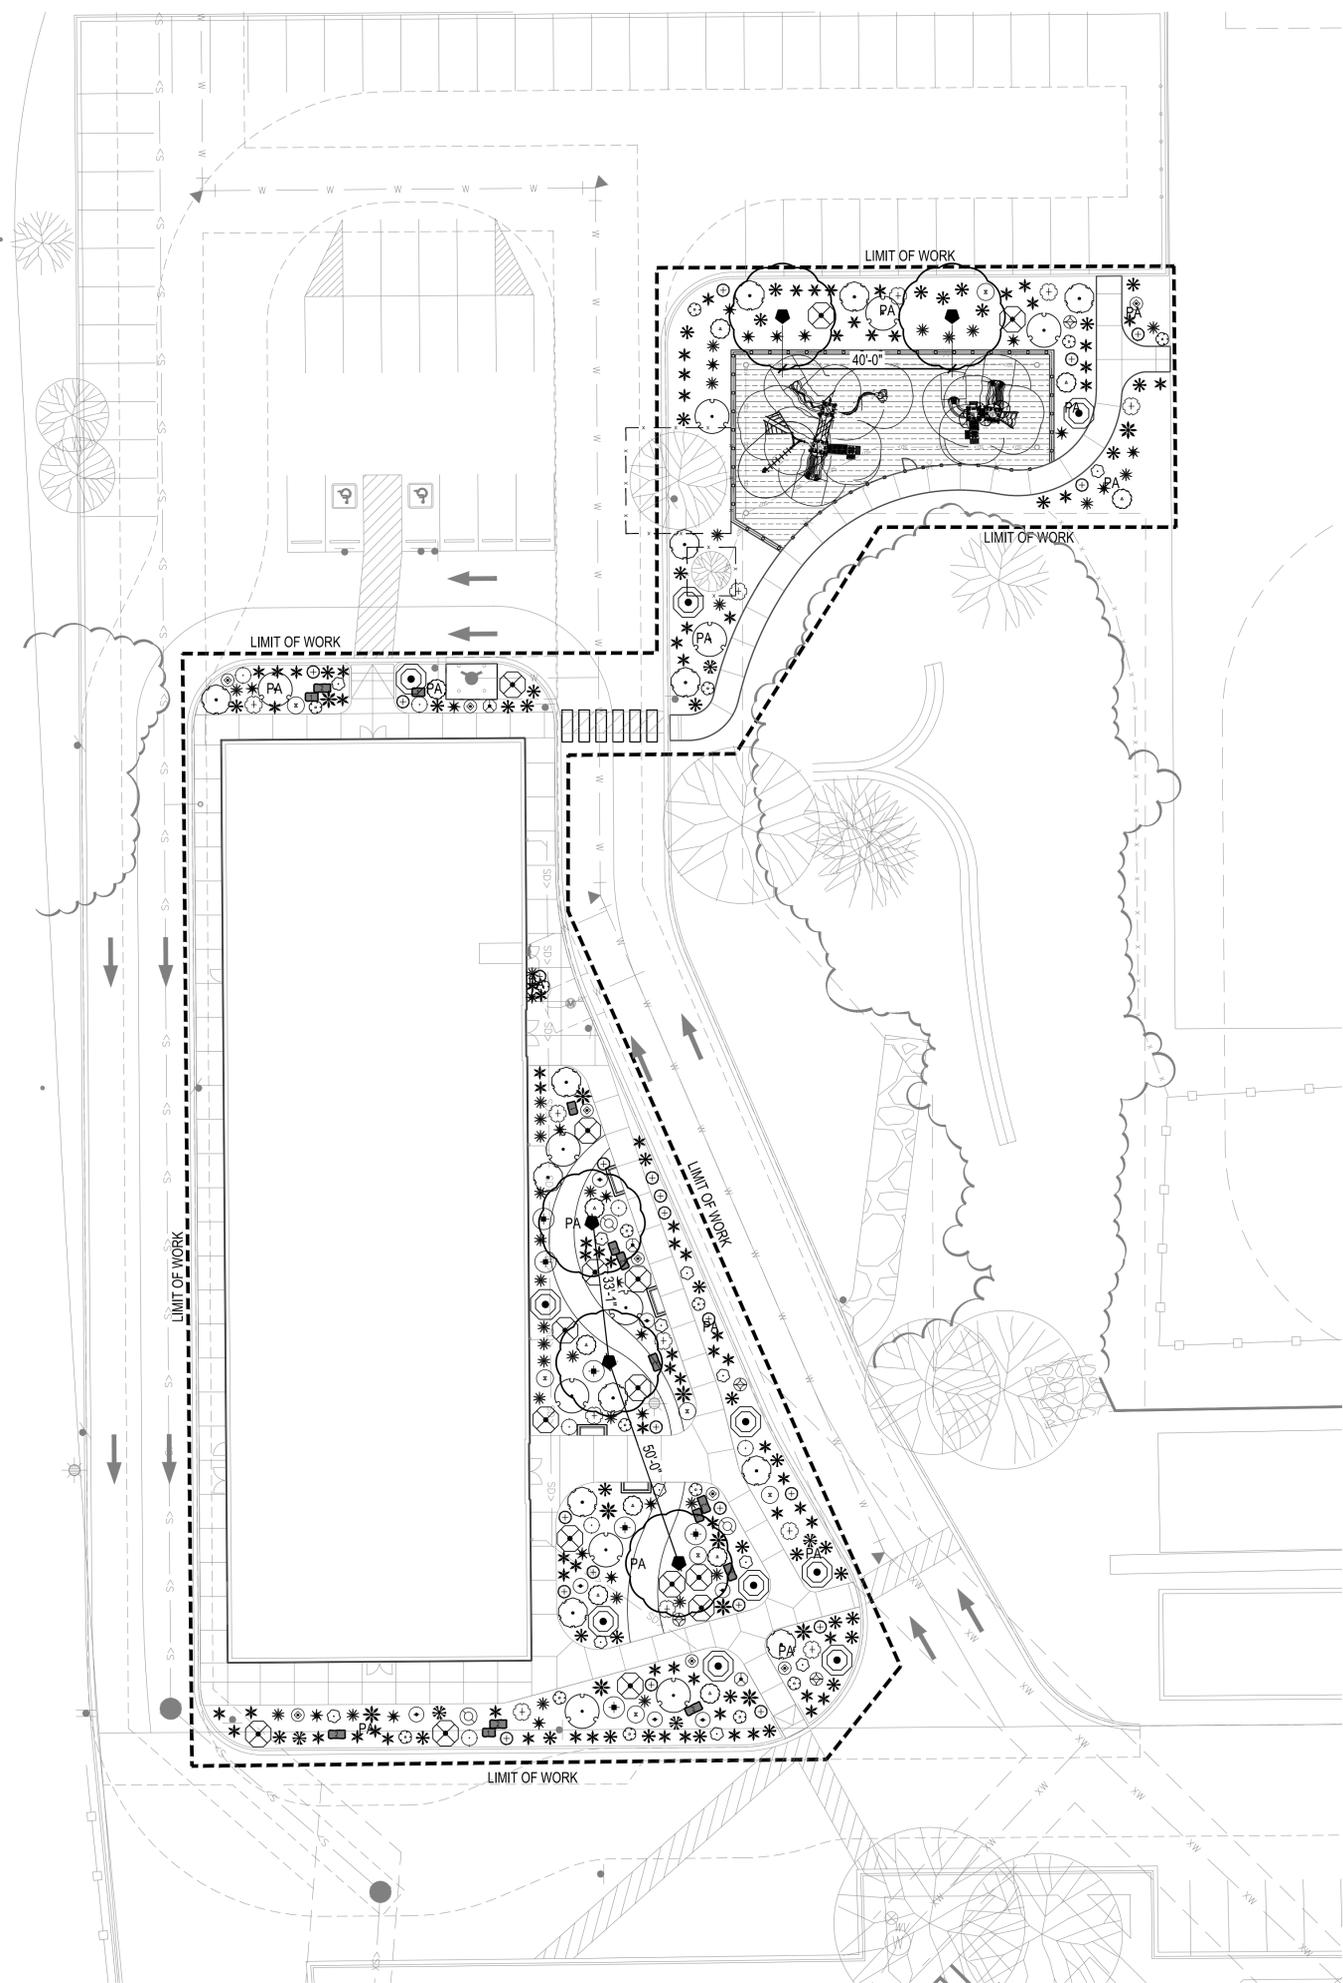

**SITE LEGEND:**

- LIMIT OF WORK
- PLANTING
- EXISTING TREES TO REMAIN AND BE PROTECTED
- PAVING  
CONCRETE PAVING  
COLOR: STANDARD GRAY  
FINISH: LIGHT BROOM
- FURNISHINGS  
FIXED BENCH
- PLANTING AREA**
- PA  
PLANTING AREA  
WOOD MULCH  
3" THICK SHREDDED CEDAR MULCH (NO LANDSCAPE FABRIC)
- 3" ROCK MULCH  
2-4" GLACIER WHITE RIVER ROCK
- ENGINEERED WOOD FIBER MULCH  
1,000 SF
- PLAYGROUND FENCE
- TREE PROTECTION FENCE
- BOULDER SCHEDULE**

SYM	SIZE (LxWxH)	QTY
	3'x2'x2'	6
	4'x2'x2'	8

**GENERAL LANDSCAPE NOTES:**

- PLANT QUALITY: ALL PLANT MATERIAL SHALL BE A-GRADE OR NO. 1 GRADE - FREE OF ANY DEFECTS, OF NORMAL HEALTH, HEIGHT, LEAF DENSITY AND SPREAD APPROPRIATE TO THE SPECIES AS DEFINED BY THE AMERICAN ASSOCIATION OF NURSERYMEN (AAN) STANDARDS. ALL TREES SHALL BE BALL AND BURLAP OR EQUIVALENT.
- ALL LANDSCAPING AND PLANTS TO BE LOCATED NOT TO INTERFERE WITH EXISTING OR PROPOSED UTILITIES CONTRACTOR SHALL VERIFY LOCATION OF ALL UNDERGROUND UTILITIES, LINES AND STRUCTURES PRIOR TO EXCAVATION OR TRENCHING. DAMAGE TO THESE UTILITIES SHALL BE REPAIRED BY THE CONTRACTOR AT NO COST TO THE OWNER OR LANDSCAPE ARCHITECT.
- PLANT QUANTITIES SHOWN FOR INFORMATION PURPOSES ONLY. CONTRACTOR TO VERIFY ALL QUANTITIES.
- ALL TREE AND SHRUB LOCATIONS SHALL BE STAKED BY CONTRACTOR AND APPROVED BY LANDSCAPE ARCHITECT.
- PLANT SUBSTITUTIONS WILL NOT BE PERMITTED WITHOUT APPROVAL FROM LANDSCAPE ARCHITECT.
- PLANTS SHALL BE INSTALLED IMMEDIATELY UPON DELIVERY TO SITE, IF THIS IS NOT POSSIBLE, PLANTS SHALL BE HEeled IN AND WATERED TO PREVENT DEHYDRATION.
- SOIL AMENDMENT:**  
SHRUB AND PLANTING BEDS - 4" OF COMPOST TILLED INTO 6" OF EXISTING SOIL.  
ACCEPTABLE PRODUCT: CLASS I COMPOST. COMPOSTED MATERIAL SHALL CONSIST OF AGED ORGANIC MATTER, FREE OF WEED OR OTHER NOXIOUS PLANT SEEDS, LUMPS, STONES, OR OTHER FOREIGN CONTAMINANTS HARMFUL TO PLANT LIFE, AND HAVING THE FOLLOWING CHARACTERISTICS BASED ON A NUTRIENT TEST PERFORMED NO LONGER THAN 3 MONTHS PRIOR TO ITS INCORPORATION INTO THE PROJECT.  
A. ORGANIC MATTER: 25% MINIMUM.  
B. SALT CONTENT: 5.0 MMHOS/CM MAXIMUM  
C. PH: 7.5 MAXIMUM.  
D. CARBON TO NITROGEN RATIO OF 10:1 TO 20:1
- ALL LANDSCAPED AREAS AND PLANT MATERIAL, EXCEPT FOR NON-IRRIGATED NATIVE, RESTORATIVE, AND DRYLAND GRASS AREAS THAT COMPLY WITH REQUIREMENTS FOUND IN SEC. 146-1429 AND/OR SEC. 146-1435 MUST BE WATERED BY AN AUTOMATIC UNDERGROUND IRRIGATION SYSTEM. IRRIGATION SYSTEM DESIGN, INSTALLATION, OPERATION, AND MAINTENANCE SHALL CONFORM TO REQUIREMENTS FOUND IN THE CITY OF AURORA IRRIGATION ORDINANCE.
- SOD TO BE REPLACED OVER ALL TRENCHED IRRIGATION LINES.
- INSTALL 4" OF ORGANIC WOOD MULCH IN EXISTING PLANTING BEDS AND TREE PLANTING PITS THAT HAVE BEEN DISTURBED OR ENLARGED. MULCH TO MATCH EXISTING.
- ALL DAMAGED OR DEAD PLANT MATERIAL TO BE REPLACED. CONTRACTOR TO PROVIDE WATER THROUGHOUT CONSTRUCTION PERIOD.
- THE FOLLOWING SEPARATIONS SHALL BE PROVIDED BETWEEN TREES/SHRUBS AND UTILITIES:  
40 FEET BETWEEN CANOPY TREES AND STREET LIGHTS  
15 FEET BETWEEN ORNAMENTAL TREES AND STREETLIGHTS  
10 FEET BETWEEN TREES AND PUBLIC WATER, SANITARY AND STORM SEWER MAIN LINES  
6 FEET BETWEEN TREES AND PUBLIC WATER, SANITARY AND STORM SEWER SERVICE LINES.  
4 FEET BETWEEN SHRUBS AND PUBLIC WATER AND SANITARY AND STORM SEWER LINES  
4 FEET BETWEEN TREES AND GAS LINES
- ALL STREET TREES SHALL BE PLACED A MINIMUM EIGHT (8) FEET AWAY FROM THE EDGES OF DRIVEWAYS.
- PLACEMENT OF ALL LANDSCAPING SHALL BE IN ACCORDANCE WITH THE SIGHT DISTANCE CRITERIA AS SPECIFIED BY CHERRY HILLS VILLAGE. NO STRUCTURES OR LANDSCAPE ELEMENTS GREATER THAN 24" SHALL BE ALLOWED WITHIN THE SIGHT DISTANCE TRIANGLE OR EASEMENTS WITH THE EXCEPTION OF DECIDUOUS TREES PROVIDED THAT THE LOWEST BRANCH IS AT LEAST 6' FROM GRADE. ANY FENCES WITHIN THE SIGHT DISTANCE TRIANGLE OR EASEMENT MUST BE NOT MORE THAN 42" IN HEIGHT AND OF AN OPEN DESIGN.
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- ALL PLANTING BEDS SHALL BE MULCHED TO A MINIMUM DEPTH OF THREE INCHES.

**PLANT SCHEDULE**

SYMBOL	CODE	QTY	BOTANICAL / COMMON NAME	CONT	CAL	WATER USE
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**TREES**

	AG	2	Acer grandidentatum / Bigtooth Maple	B&B	1.5'	Low - Medium
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SYMBOL	CODE	QTY	BOTANICAL / COMMON NAME	CONT	O.C	WATER USE
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**DECIDUOUS SHRUBS**

	CB	10	Caryopteris x clandonensis 'Blue Mist' / Blue Mist Bluebeard	5 gal.		Low - Medium
	CM	7	Chamaebatiaria millefolium / Fernbush	5 gal.		Very low - Low
	CS	6	Cytisus purgans 'Spanish Gold' / Spanish Gold Broom	5 gal.		Very low - Medium
	EN	12	Ericameria nauseosa / Rubber Rabbitbrush	5 gal.		Very low - Low
	PG	7	Potentilla fruticosa 'Goldfinger' / Goldfinger Bush Cinquefoil	5 gal.		Medium
	PP	10	Prunus besseyi 'P011S' / Pawnee Buttes® Sand Cherry	5 gal.		Low
	PB	3	Prunus pumila besseyi / Western Sand Cherry	5 gal.		Low
	PT	11	Prunus tomentosa / Nanking Cherry	5 gal.		Medium
	RG	13	Rhus aromatica 'Gro-Low' / Gro-Low Fragrant Sumac	5 gal.		Very low - Medium

**EVERGREEN SHRUBS**

	AU	16	Arctostaphylos uva-ursi / Kinnikinnick	5 gal.		Low
	PS2	7	Pinus mugo 'Slowmound' / Slowmound Mugo Pine	5 gal.		Low - Medium

**ORNAMENTAL GRASS**

	BG	82	Bouteloua gracilis / Blue Grama Grass	1 gal.		Low
	CA	33	Calamagrostis x acutiflora / Feather Reed Grass	1 gal.		Medium
	SL	23	Schizachyrium scoparium / Little Bluestem	1 gal.		Very low - Low
	SH	44	Sporobolus heterolepis / Prairie Dropseed	1 gal.		Low

**PERENNIAL**

	AM	23	Achillea x 'Moonshine' / Moonshine Yarrow	1 gal.		Low
	AC	11	Aquilegia caerulea / Rocky Mountain Columbine	1 gal.		Medium
	EM	12	Echinacea purpurea 'Magnus' / Magnus Purple Coneflower	1 gal.		Low - Medium
	GA	9	Gaillardia aristata / Blanket Flower	1 gal.		Low - Medium
	NW	15	Nepeta x faassenii 'Walker's Low' / Walker's Low Catmint	1 gal.		Low - Medium
	PS	3	Penstemon strictus / Rocky Mountain Penstemon	1 gal.		Low
	RC	4	Ratibida columnifera / Prairie Coneflower	1 gal.		Low - Medium
	RA	5	Rudbeckia amplexicaulis / Black-eyed Susan	1 gal.		High




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LOTUS SCHOOL FOR EXCELLENCE

11001 EAST ALAMEDA AVENUE  
AURORA, CO 80012


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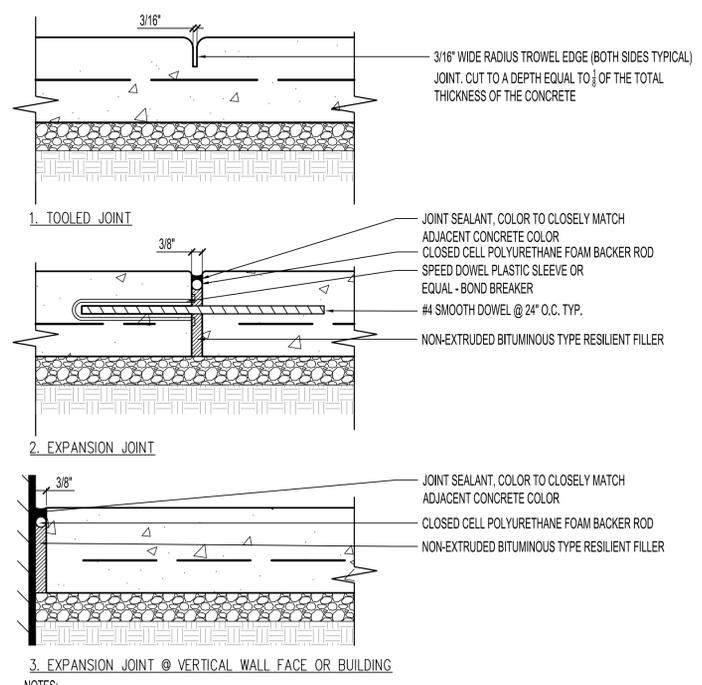
- NOTES:
1. REFERENCE PLANS & SPECIFICATIONS FOR COLOR AND/OR FINISH
  2. REFER TO SPECS FOR CONCRETE STRENGTH AND REINFORCEMENT REQ.
  3. REFER TO PLANS FOR EXPANSION JOINT LOCATIONS
  4. REFER TO PLANS FOR CONTROL JOINT LOCATIONS. CONTROL JOINTS ARE TO BE MAX. 2x THE THICKNESS OF THE CONCRETE.
  5. PROVIDE ISOLATION JOINTS AT ALL WALLS AND BUILDINGS TYP.
  6. CONCRETE SHALL HAVE A MAXIMUM 1.8% AND A MINIMUM OF 1% CROSS SLOPE.

**A CONCRETE PAVING - PEDESTRIAN**  
 Scale: 1/2" = 1'-0"

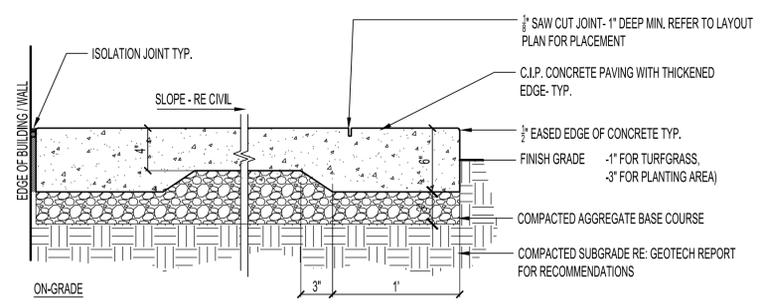


MANUFACTURER: LANDSCAPE FORMS  
 PRODUCT: RATIO BENCH  
 MATERIALS: STAINLESS STEEL  
 FINISHES: POWDER COAT SILVER TEXTURE ON ARM RESTS  
 DIMENSIONS: 77" L X 24.25" W X 32" TALL  
 MOUNTING: SURFACE MOUNT. PROVIDE THREADED ANCHORS AND STAINLESS STEEL MOUNTING HARDWARE.

**D FIXED BENCH TYPE 1- RATIO BENCH - BACKED**  
 Scale: 1" = 1'-0"

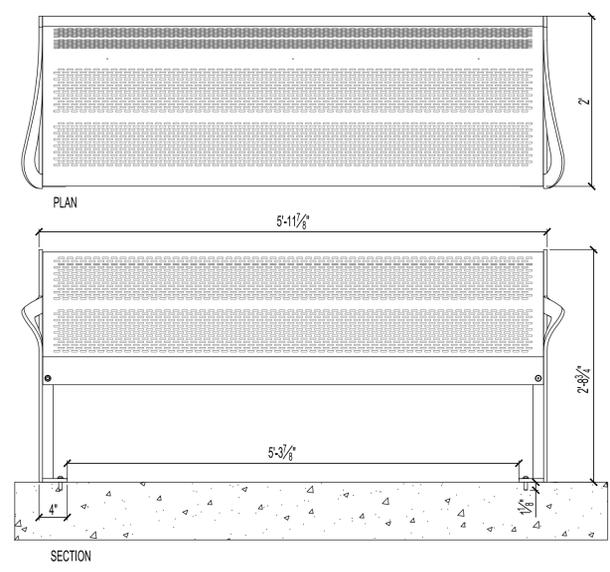


- NOTES:
1. REFER TO MATERIAL SCHEDULE & DETAILS FOR COLOR, PATTERN, TEXTURE AND FINISH OF CONCRETE PAVING
  2. REFER TO PLANS FOR LOCATION OF ALL CONSTRUCTION JOINTS.
  3. ALL CONNECTIONS BETWEEN EXISTING AND NEW CONCRETE PAVING SHALL BE SMOOTH AND FLUSH TRANSITIONS


**B TYPICAL CONSTRUCTION JOINTS**  
 Scale: 1" = 1'-0"

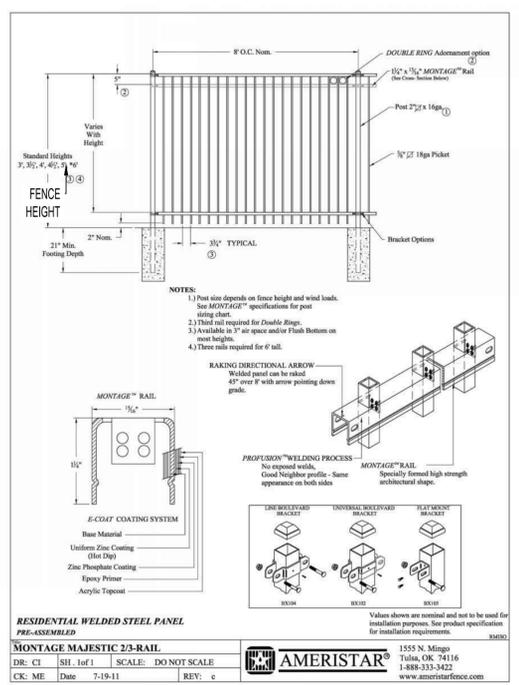

**E TYPICAL FENCE**  
 Scale: NTS


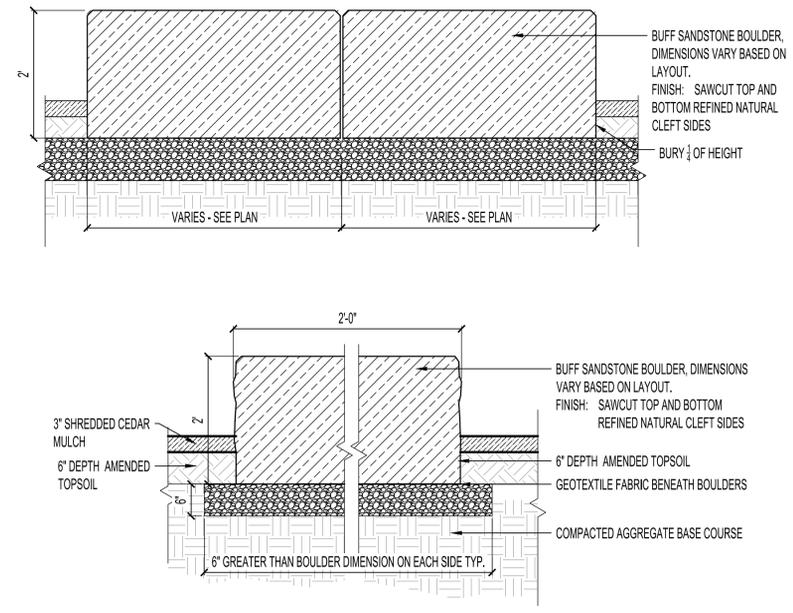


**C LANDSCAPE BOULDERS**  
 Scale: 3/4" = 1'-0"

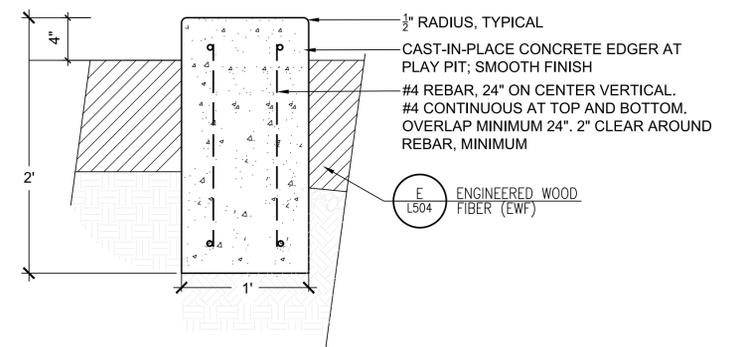


- NOTES:
1. PLAYGROUND FENCE SPECIFYING INFO
    - 5 FT. TALL FENCE W/ SINGLE SWING GATES LOCATED PER PLAN. GATE TO SWING IN THE DIRECTION OF EGRESS WITH ABILITY TO LOCK OUTSIDE WITH A PANIC DEVICE.
- FENCE MANUFACTURER SHALL SUBMIT SHOP DRAWINGS OF EACH FENCE AND GATE TYPE FOR APPROVAL BY THE LARCH, PRIOR TO FABRICATION
- NOTES:  
 JOINT SPACING AT EDGER:
1. SAW CUT CONTROL JOINTS EQUALLY SPACED AT 8' MINIMUM, 10' MAXIMUM AND CONTINUE DOWN ENTIRE FACE OF EDGER
  2. EXPANSION JOINTS EQUALLY SPACED AT 80' MINIMUM, 100' MAXIMUM
  3. REFER TO SPECIFICATIONS FOR ALL MATERIALS CALLED OUT IN DETAIL

**F PLAYGROUND EDGER**  
 Scale: 1/2" = 1'-0"

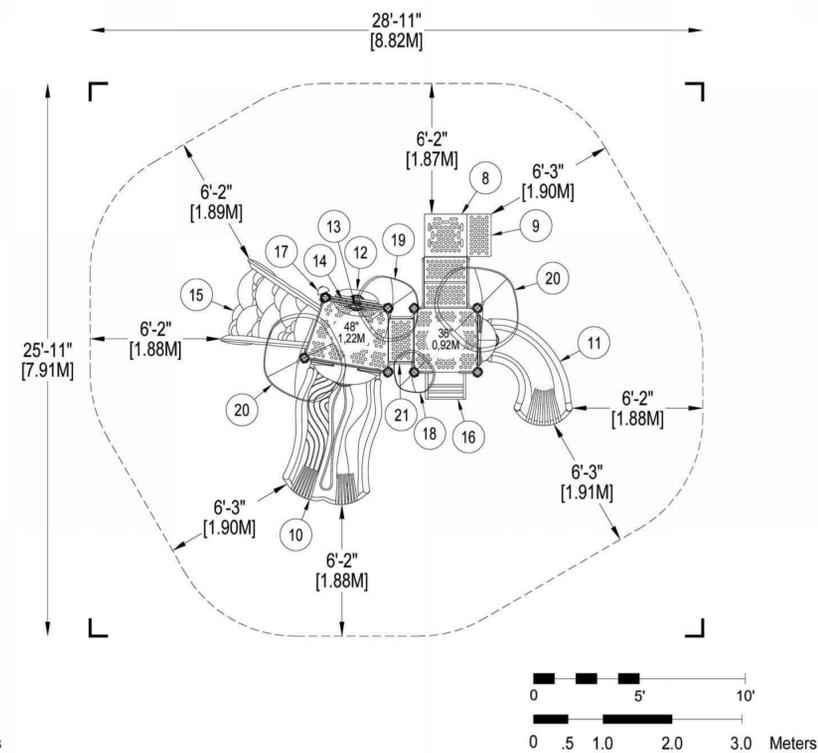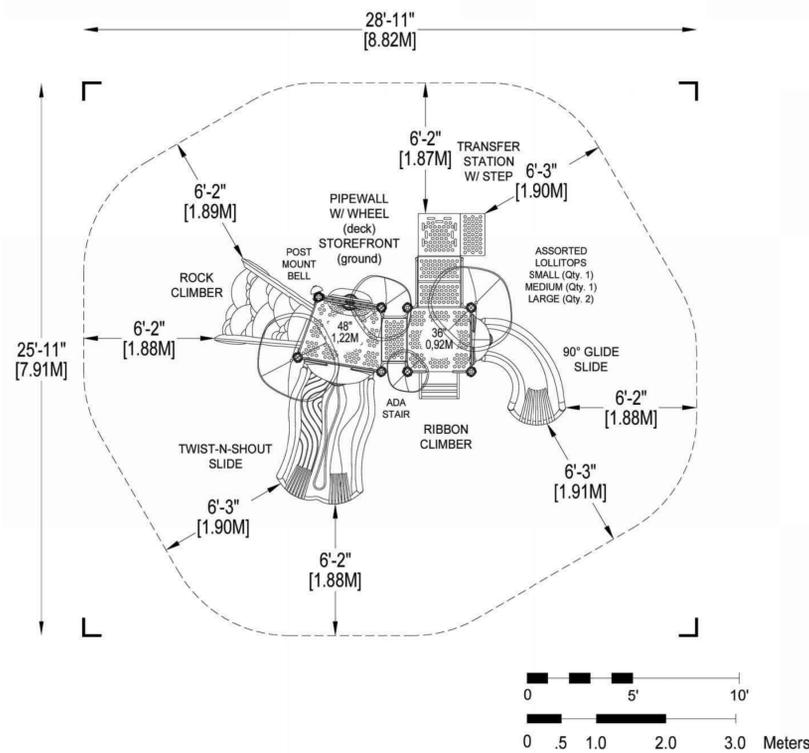


**A PLAY STRUCTURE- TYPE 1**  
Scale: FULLSCALE

**DETAIL 1**  
Support Post, Spiral Slide and Post Footing Detail

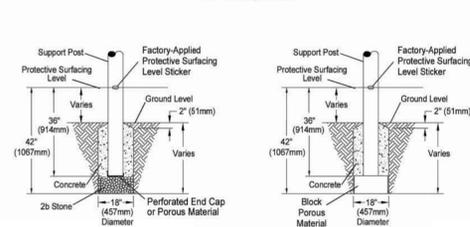


STONE OPTION OR BLOCK OPTION  
When utilizing Post Extensions adjust depth of footing/concrete accordingly.

**DETAIL 2**  
GroundZero, Cantilever and "T" Post Footing Detail

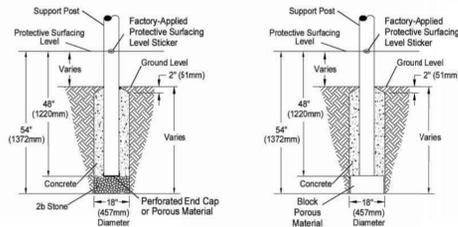


STONE OPTION OR BLOCK OPTION

**DETAIL 3**  
Component Footing Detail

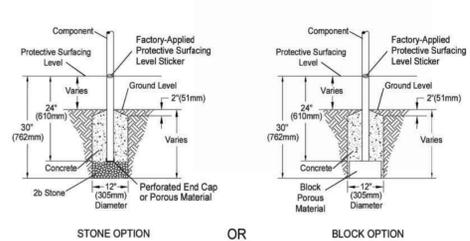


STONE OPTION OR BLOCK OPTION

**DETAIL 4**  
Surface Mount Detail

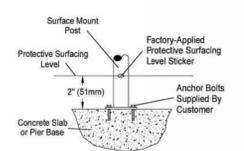


**DETAIL 5**  
Shade Post Footing Detail

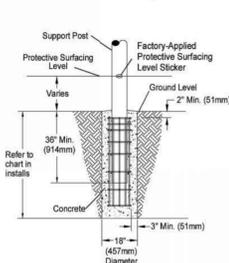

**SITE NOTES:**  
1) The site plan provided must be checked against the actual site area to ensure that placement of your structure meets required clearances.  
2) The dimensions labeled are for location of footing notes, not exact placement of equipment. Assemble, plant, and level equipment before pouring concrete.  
3) There must be a minimum distance of 1' (305mm) between any obstacle, sidewalk, etc., and your structure.  
4) Slides must have a use zone that extends out from the lower end section of the slide a distance that is at least 1' (305mm) or equal to the vertical distance from the highest point of the sliding surface to the top of the protective surfacing, whichever is greater. The side use zone should not extend greater than 1' (305mm) from the end of the lower end section.  
5) The controllable area, including the space under and around the equipment, must be covered with an impact attenuating material.  
See the 1997 publication, "Handbook for Public Playground Safety", published by the U.S. Consumer Product Safety Commission, for guidelines and recommendations on the type and depth of surfacing material. For a copy of the "Handbook for Public Playground Safety", write to: U.S. Consumer Product Safety Commission, Office of Information and Public Affairs, Washington, D.C. 20272

**INSTALLATION NOTES:**  
1) Paved surfaces, such as asphalt and concrete, are not acceptable for use under your structure.  
2) It is the consumer's responsibility to check with local utilities prior to excavating footings for any underground utility lines that may exist within the installation area.  
3) It is the consumer's responsibility to check local soil conditions and drainage within the site area. Inquire with local contractors for appropriate recommendations.  
4) If the structure is to be installed across uneven terrain, maintain the support post marks for protective surfacing level at the lowest grade. Adjust other footings accordingly.  
5) The base of footings must be below frost line.  
6) Do not encase the bottom of support posts in concrete. Place all posts directly on packed stone.  
7) Assemble the entire structure before pouring concrete unless specifically instructed to do so in the individual component installation instructions.  
8) Read completely the installation instructions provided with your structure prior to beginning construction.


\*PLAYGROUND SUPERVISION REQUIRED

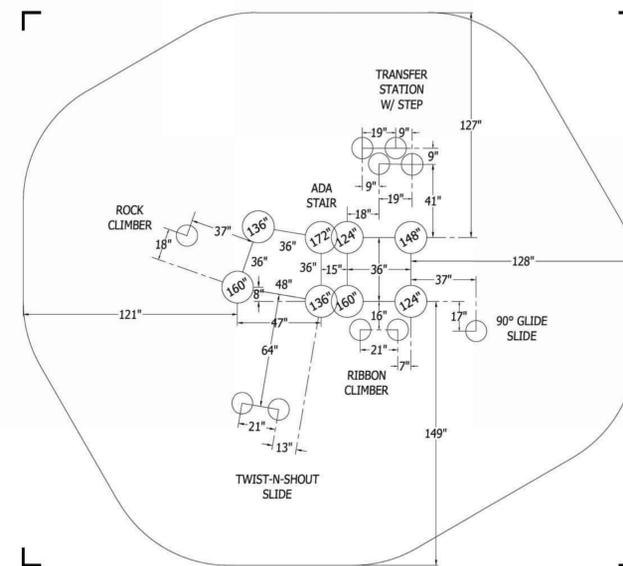

- COMPANY: PLAYWORLD OR APPROVED EQUAL  
ITEM: 350-1736  
AGE RANGE: 2-5 YEARS  
INSTALL PER MANUFACTURER RECOMMENDATIONS AND SPECIFICATIONS
1. DETAIL(S) FROM MANUFACTURER, RVI IS NOT RESPONSIBLE FOR INFORMATION SHOWN.
  2. CONTRACTOR TO VERIFY WITH MANUFACTURER THAT DETAIL(S) IS/ARE MOST CURRENT AVAILABLE PRIOR TO INSTALLATION.
  3. ADDITIONAL DETAILS AND INSTALLATION INFORMATION IS PART OF INSTALLATION GUIDE PROVIDED BY MANUFACTURER. CONTRACTOR TO OBTAIN ALL ADDITIONAL INFORMATION AND FULLY UNDERSTAND PRIOR TO INSTALLATION OF EQUIPMENT.
  4. REFER TO SITE PLANS FOR ADJACENT PLAYGROUND SURFACING. FINISHED SURFACE LEVEL SHOWN ON DETAIL SHALL BE HELD FOR ALL SURFACE TYPES.

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03/26/2025	PRELIM
05/15/2025	BID SET
05/23/2025	CITY SUB.

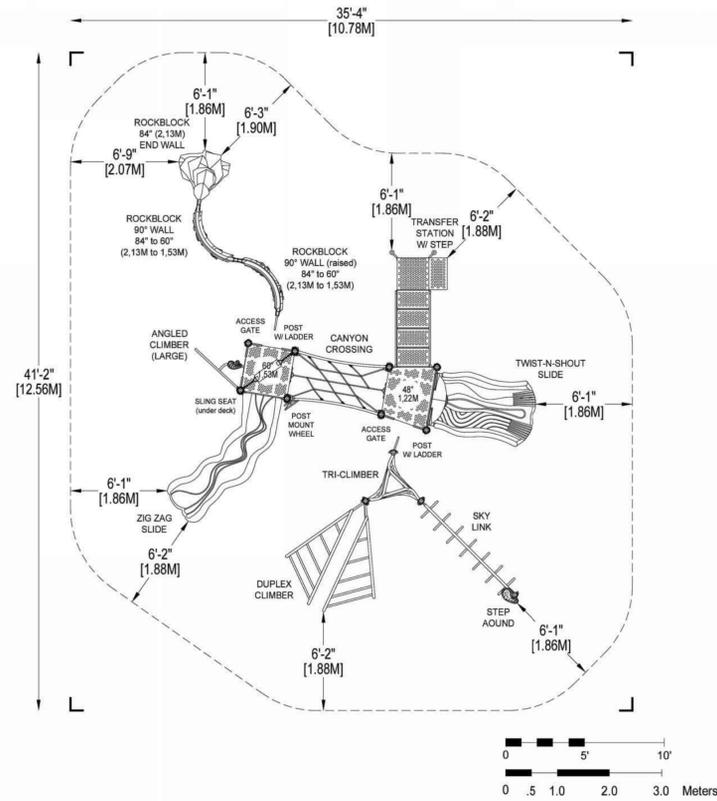

COMPANY: PLAYWORLD OR APPROVED EQUAL  
ITEM: 350-2105A

AGE RANGE: 5-12 YEARS

INSTALL PER MANUFACTURER RECOMMENDATIONS AND SPECIFICATIONS

1. DETAIL(S) FROM MANUFACTURER, RVI IS NOT RESPONSIBLE FOR INFORMATION SHOWN.
2. CONTRACTOR TO VERIFY WITH MANUFACTURER THAT DETAIL(S) IS/ARE MOST CURRENT AVAILABLE PRIOR TO INSTALLATION.
3. ADDITIONAL DETAILS AND INSTALLATION INFORMATION IS PART OF INSTALLATION GUIDE PROVIDED BY MANUFACTURER. CONTRACTOR TO OBTAIN ALL ADDITIONAL INFORMATION AND FULLY UNDERSTAND PRIOR TO INSTALLATION OF EQUIPMENT.
4. REFER TO SITE PLANS FOR ADJACENT PLAYGROUND SURFACING. FINISHED SURFACE LEVEL SHOWN ON DETAIL SHALL BE HELD FOR ALL SURFACE TYPES.

24-114



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architecture + development  
719.244.4023  
719.351.4918  
www.adragnaarch.com  
7950 S. Hamibal Cir.  
Englewood, CO, 80112

LOTUS SCHOOL FOR EXCELLENCE


11001 EAST ALAMEDA AVENUE  
AURORA, CO 80012

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11/11/2024	PREAPP
03/12/2025	MDLR CON DOC
03/26/2025	PRELIM
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05/23/2025	CITY SUB.


SP-11  
Landscape  
Details

**A PLAY STRUCTURE- TYPE 2**


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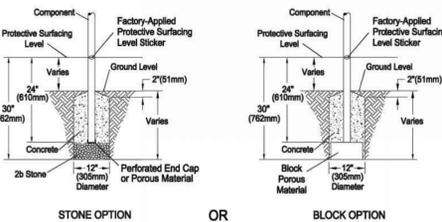
**DETAIL 1**  
Support Post, Spiral Slide and Post Footing Detail

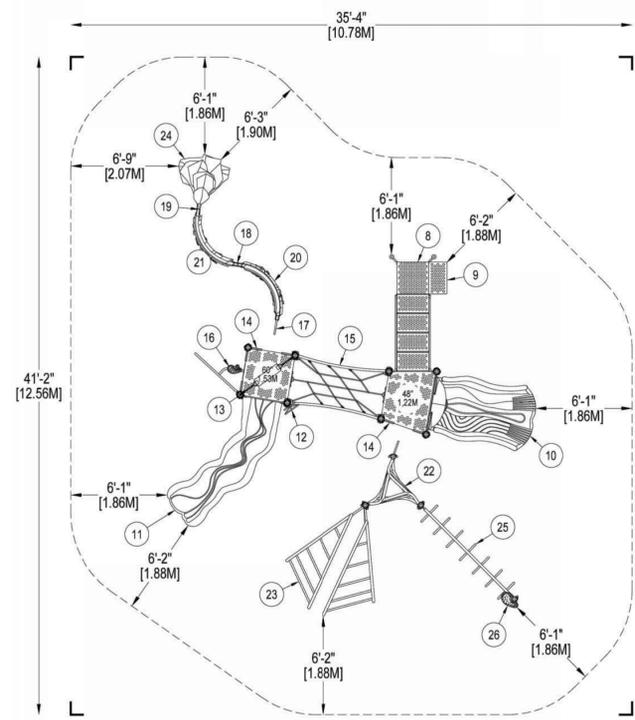


**DETAIL 2**  
GroundZero, Cantilever and "T" Post Footing Detail

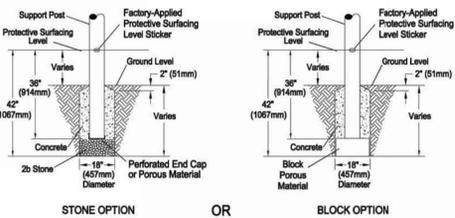



**DETAIL 3**  
Component Footing Detail

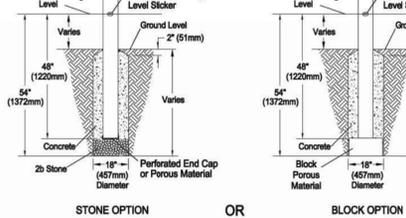

**DETAIL 4**  
Surface Mount Detail

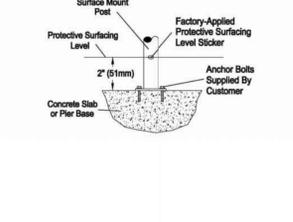

**DETAIL 5**  
Shade Post Footing Detail

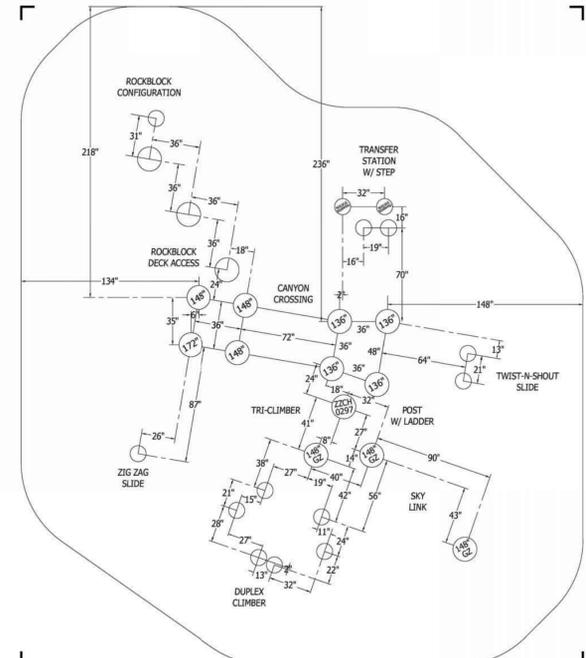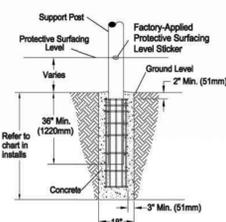

**SITE NOTES:**

- 1) The site plan provided must be checked against the actual site area to ensure that placement of your structure meets required clearances.
- 2) The dimensions labeled are for location of footing holes, not exact placement of equipment. Assembly, plants, and level equipment before pouring concrete.
- 3) There must be a minimum distance of 6" (150mm) between any obstacle, sidewalk, etc., and your structure.
- 4) Slides must have a use zone that extends out from the lower end section of the slide a distance that is at least 6" (150mm) or equal to the vertical distance from the highest point of the sliding surface to the top of the protective surfacing, whichever is greater. The slide use zone should not extend greater than 12" (305mm) from the end of the lower end section.
- 5) The complete area, including the space under and around the equipment, must be covered with an impact attenuating material. See the 1997 publication, "Handbook for Public Playground Safety," published by the U.S. Consumer Product Safety Commission, for guidelines and recommendations on the type and depth of surfacing material. For a copy of the "Handbook for Public Playground Safety," write to: U.S. Consumer Product Safety Commission, Office of Information and Public Affairs, Washington, D.C. 20207

**INSTALLATION NOTES:**


- 1) Paved surfaces, such as asphalt and concrete, are not acceptable for use under your structure.
- 2) It is the consumer's responsibility to check local soil conditions and drainage within the site area. Inquire with local contractors for appropriate recommendations.
- 3) If the structure is to be installed across uneven terrain, maintain the support post mark for protective surfacing level at the lowest grade. Adjust other footings accordingly.
- 4) If the structure is to be installed across uneven terrain, maintain the support post mark for protective surfacing level at the lowest grade. Adjust other footings accordingly.
- 5) The bases of footings must be below frost lines.
- 6) Do not encase the bottom of support posts in concrete. Place all posts directly on packed stone.
- 7) Assemble the entire structure before pouring concrete unless specifically instructed to do so in the individual component installation instructions.
- 8) Read completely the installation instructions provided with your structure prior to beginning construction.

\*PLAYGROUND SUPERVISION REQUIRED


By: Author

3/28/2025 11:10:47 AM




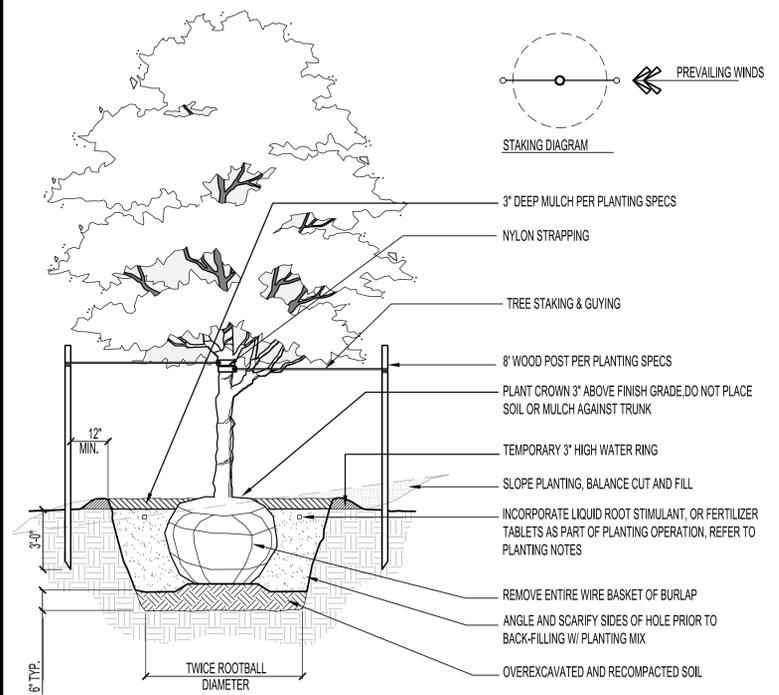


**A DECIDUOUS TREE PLANTING**  
 Scale: N.T.S.

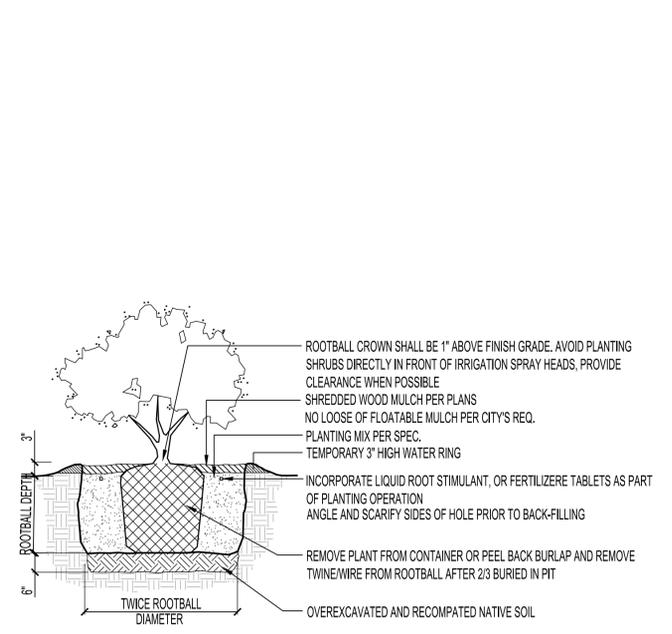

**B SHRUB PLANTING**  
 Scale: N.T.S.

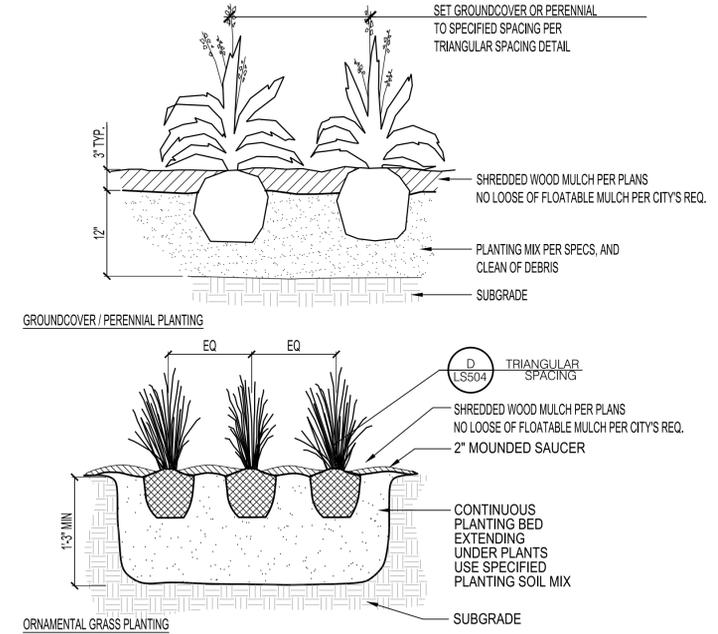


**C ORNAMENTAL GRASS & PERENNIAL PLANTING**  
 Scale: N.T.S.

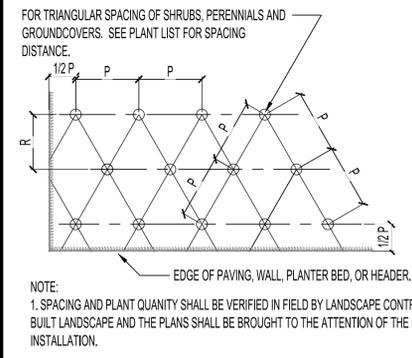


TYPICAL SPACING CHART		
P	R	AREA PER PLANT SQ. FT.
4"	3 7/16"	.096
6"	5 1/4"	.22
8"	7"	.385
10"	8 3/4"	.60
12"	10 3/8"	.87
18"	15 5/8"	1.95
24"	20 3/4"	3.46
30"	26"	5.42
36"	31"	7.80
48"	41 1/2"	13.84
60"	52"	21.65
72"	62 3/8"	31.20

**D PLANT SPACING DIAGRAM**  
 Scale: 1"=1'-0"

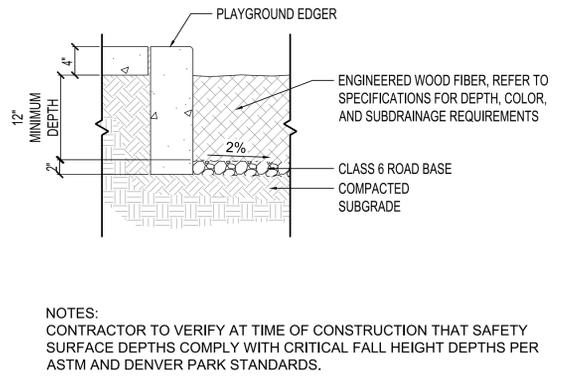


NOTES:  
 CONTRACTOR TO VERIFY AT TIME OF CONSTRUCTION THAT SAFETY SURFACE DEPTHS COMPLY WITH CRITICAL FALL HEIGHT DEPTHS PER ASTM AND DENVER PARK STANDARDS.

**E ENGINEERED WOOD FIBER**  
 Scale: 1"=1'-0"

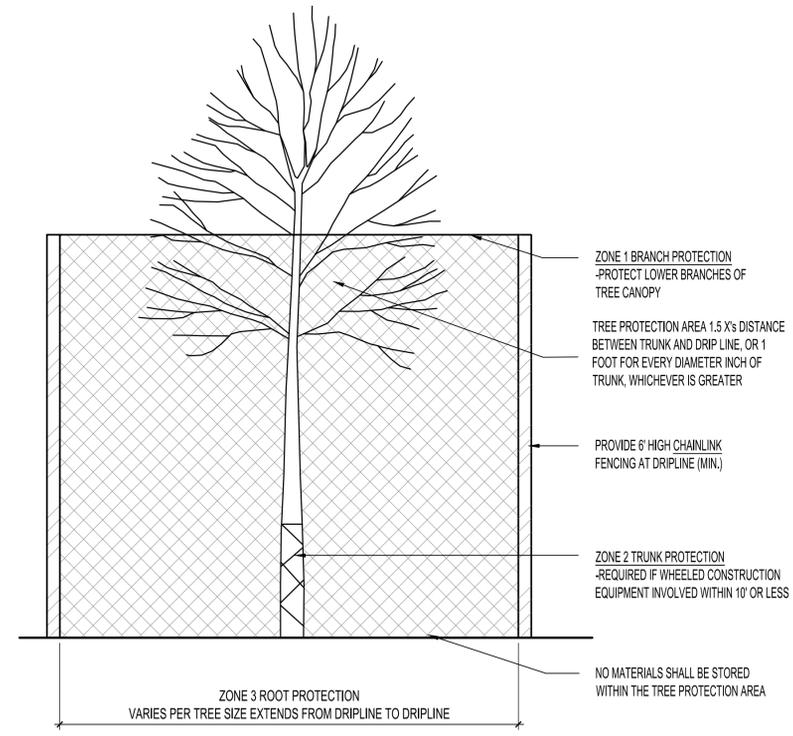


**F TREE PROTECTION**  
 Scale: 1"=1'-0"

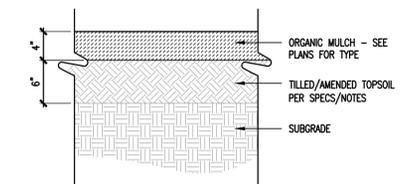


**G MULCH**  
 Scale: 1 1/2"=1'-0"  
 DT-PLANT-MULCH

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05/15/2025	BID SET
05/23/2025	CITY SUB.


SYM.	PATTERN	DESCRIPTION	MANUFACTURER / COLOR
(M)		BERRIDGE METAL PANEL OVER 7/8" HAT CHANNEL	BERRIDGE FW-12 COLOR SHASTA WHITE
(S)		THREE COAT STUCCO (3/8" SCRATCH COAT, 3/8" BROWN COAT, 1/8" FINISH COAT) OVER PAPER BACKED METAL LATH ON TYVEK STUCCO WRAP	LOTUS SCHOOL COLOR NAVY BLUE
(B)		RUNNING BOND 3/4" MIN. THIN BRICK SET IN MORTAR OVER PAPER BACKED METAL LATH ON TYVEK STUCCO WRAP ON 1/2" THICK CEMENT BACKER BOARD OR GYPSUM SHEATHING	BELDEN: GRAPHITE BLACK VELOUR OR SIMILAR
(SF)		STOREFRONT WINDOW SYSTEM WITH PPG SOLARBAN 70XL (2) SOLARGRAY GLAZING	TUBELITE TU14000 DARK BRONZE MULLIONS
(PC)		PRECAST	GRAY

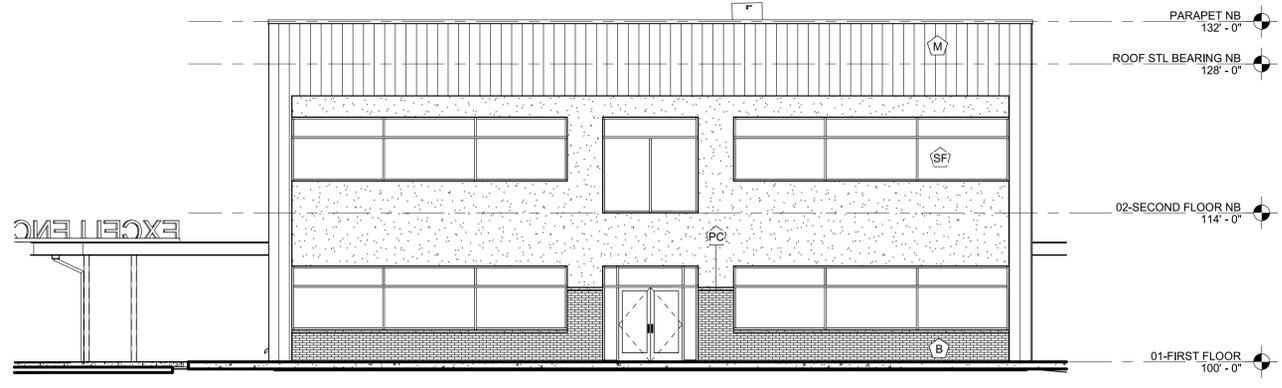


1 NORTH ELEVATION  
 SCALE: 1/8" = 1'-0"

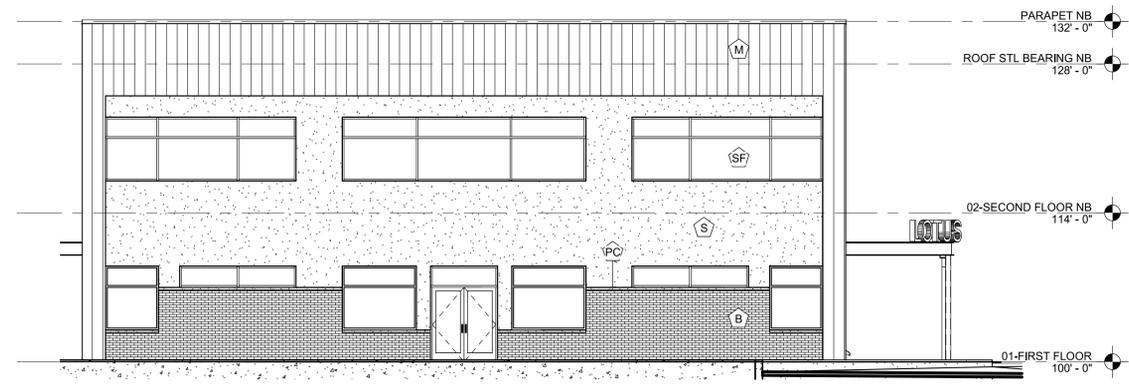

2 SOUTH ELEVATION  
 SCALE: 1/8" = 1'-0"

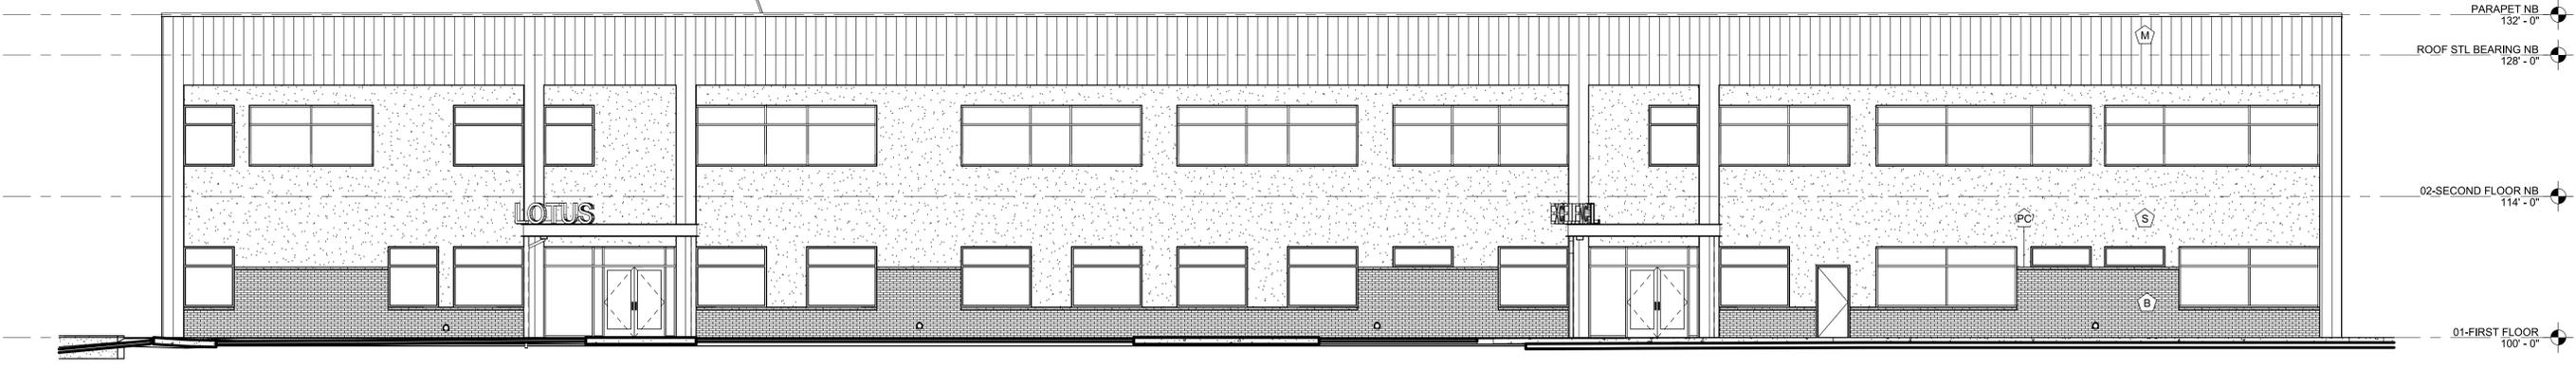

3 EAST ELEVATION  
 SCALE: 1/8" = 1'-0"

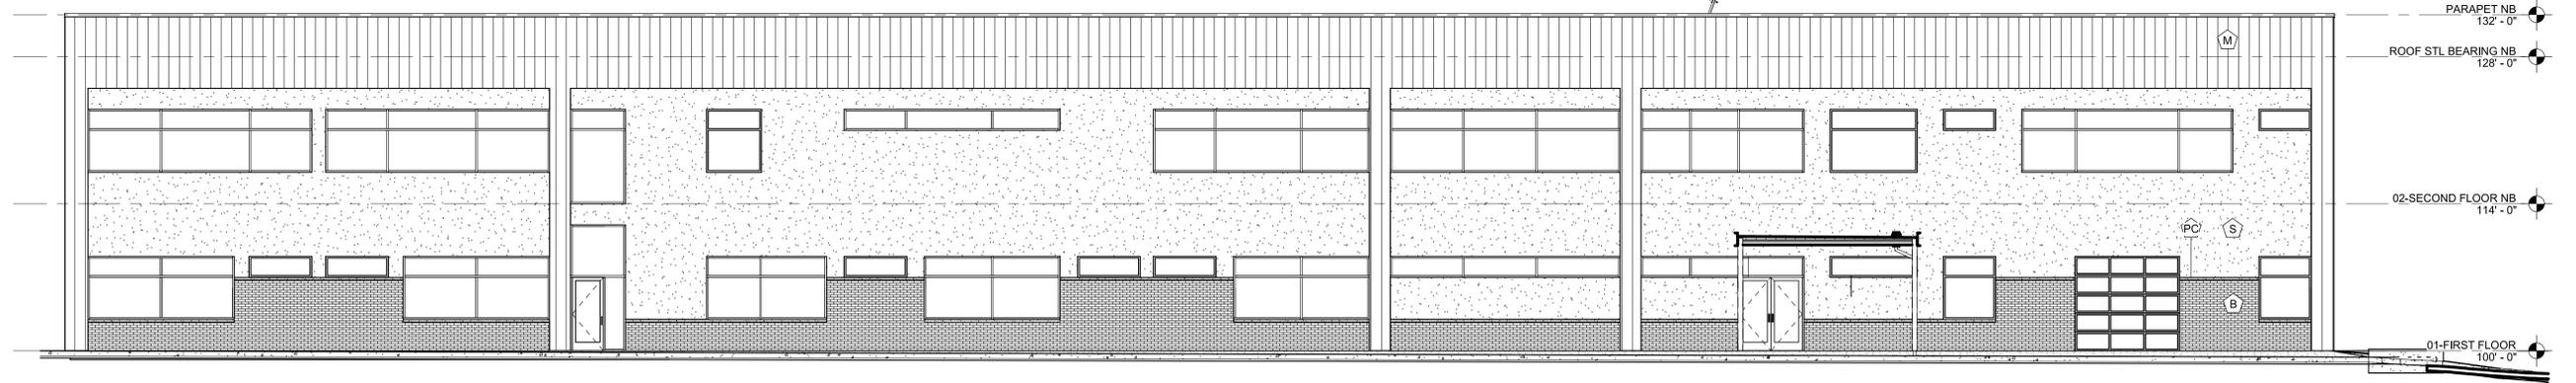

4 WEST ELEVATION  
 SCALE: 1/8" = 1'-0"

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